


ARKANSAS ONE-CALL SYSTEM, INC. 1-800-482-8998 OR 811


BRIDGER PARK PHASE II JONESBORO, ARKANSAS PRELIMINARY SUBDIVISION

APRIL 2017

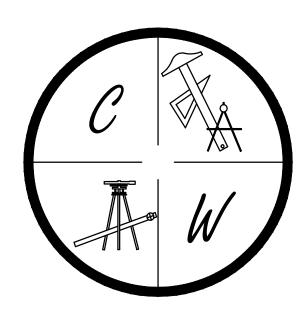



CARLOS WOOD, P.E. ENGINEERING CONSULTANT 148 CR 375 BONO, AR 72416 PHONE/FAX: (870) 972-8335 EMAIL: WOODENGR@SBCGLOBAL.NET WEBSITE: WWW.WOODENGR.COM

PROJECT VICINITY MAP SCALE: 1" = 1000'

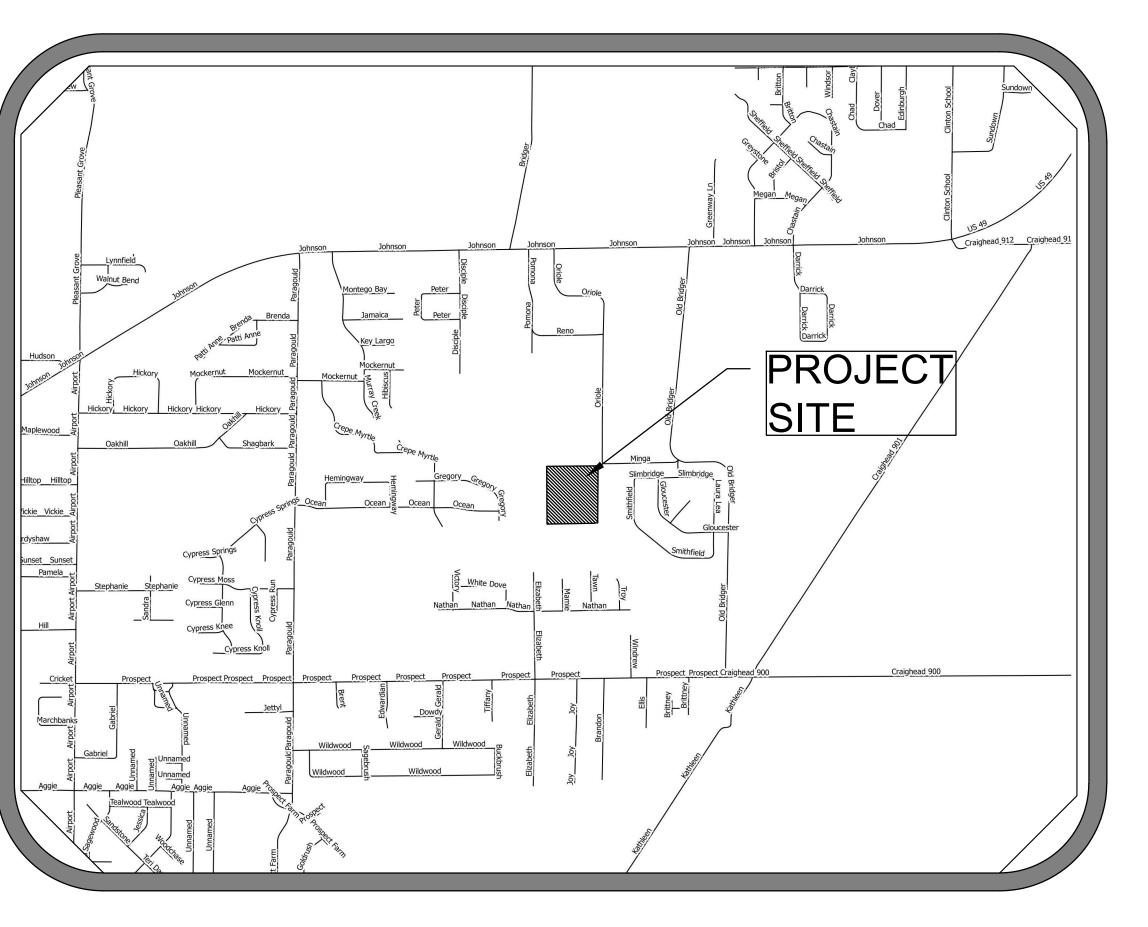



SHEET LAYOUT						
PLAT						
TOPOGRAPHY & DRAINAGE	STR-1					
BRIDGER PARK COURT PLAN & PROFILE	STR-2					
SUBDIVISION OVERALL	OVR					
UTILITY PLAN	UTIL-1					
EROSION CONTROL MAP	ECM-1					
TYPICAL STREET DETAILS	DET-1 DET-2					

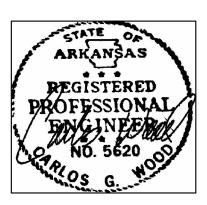

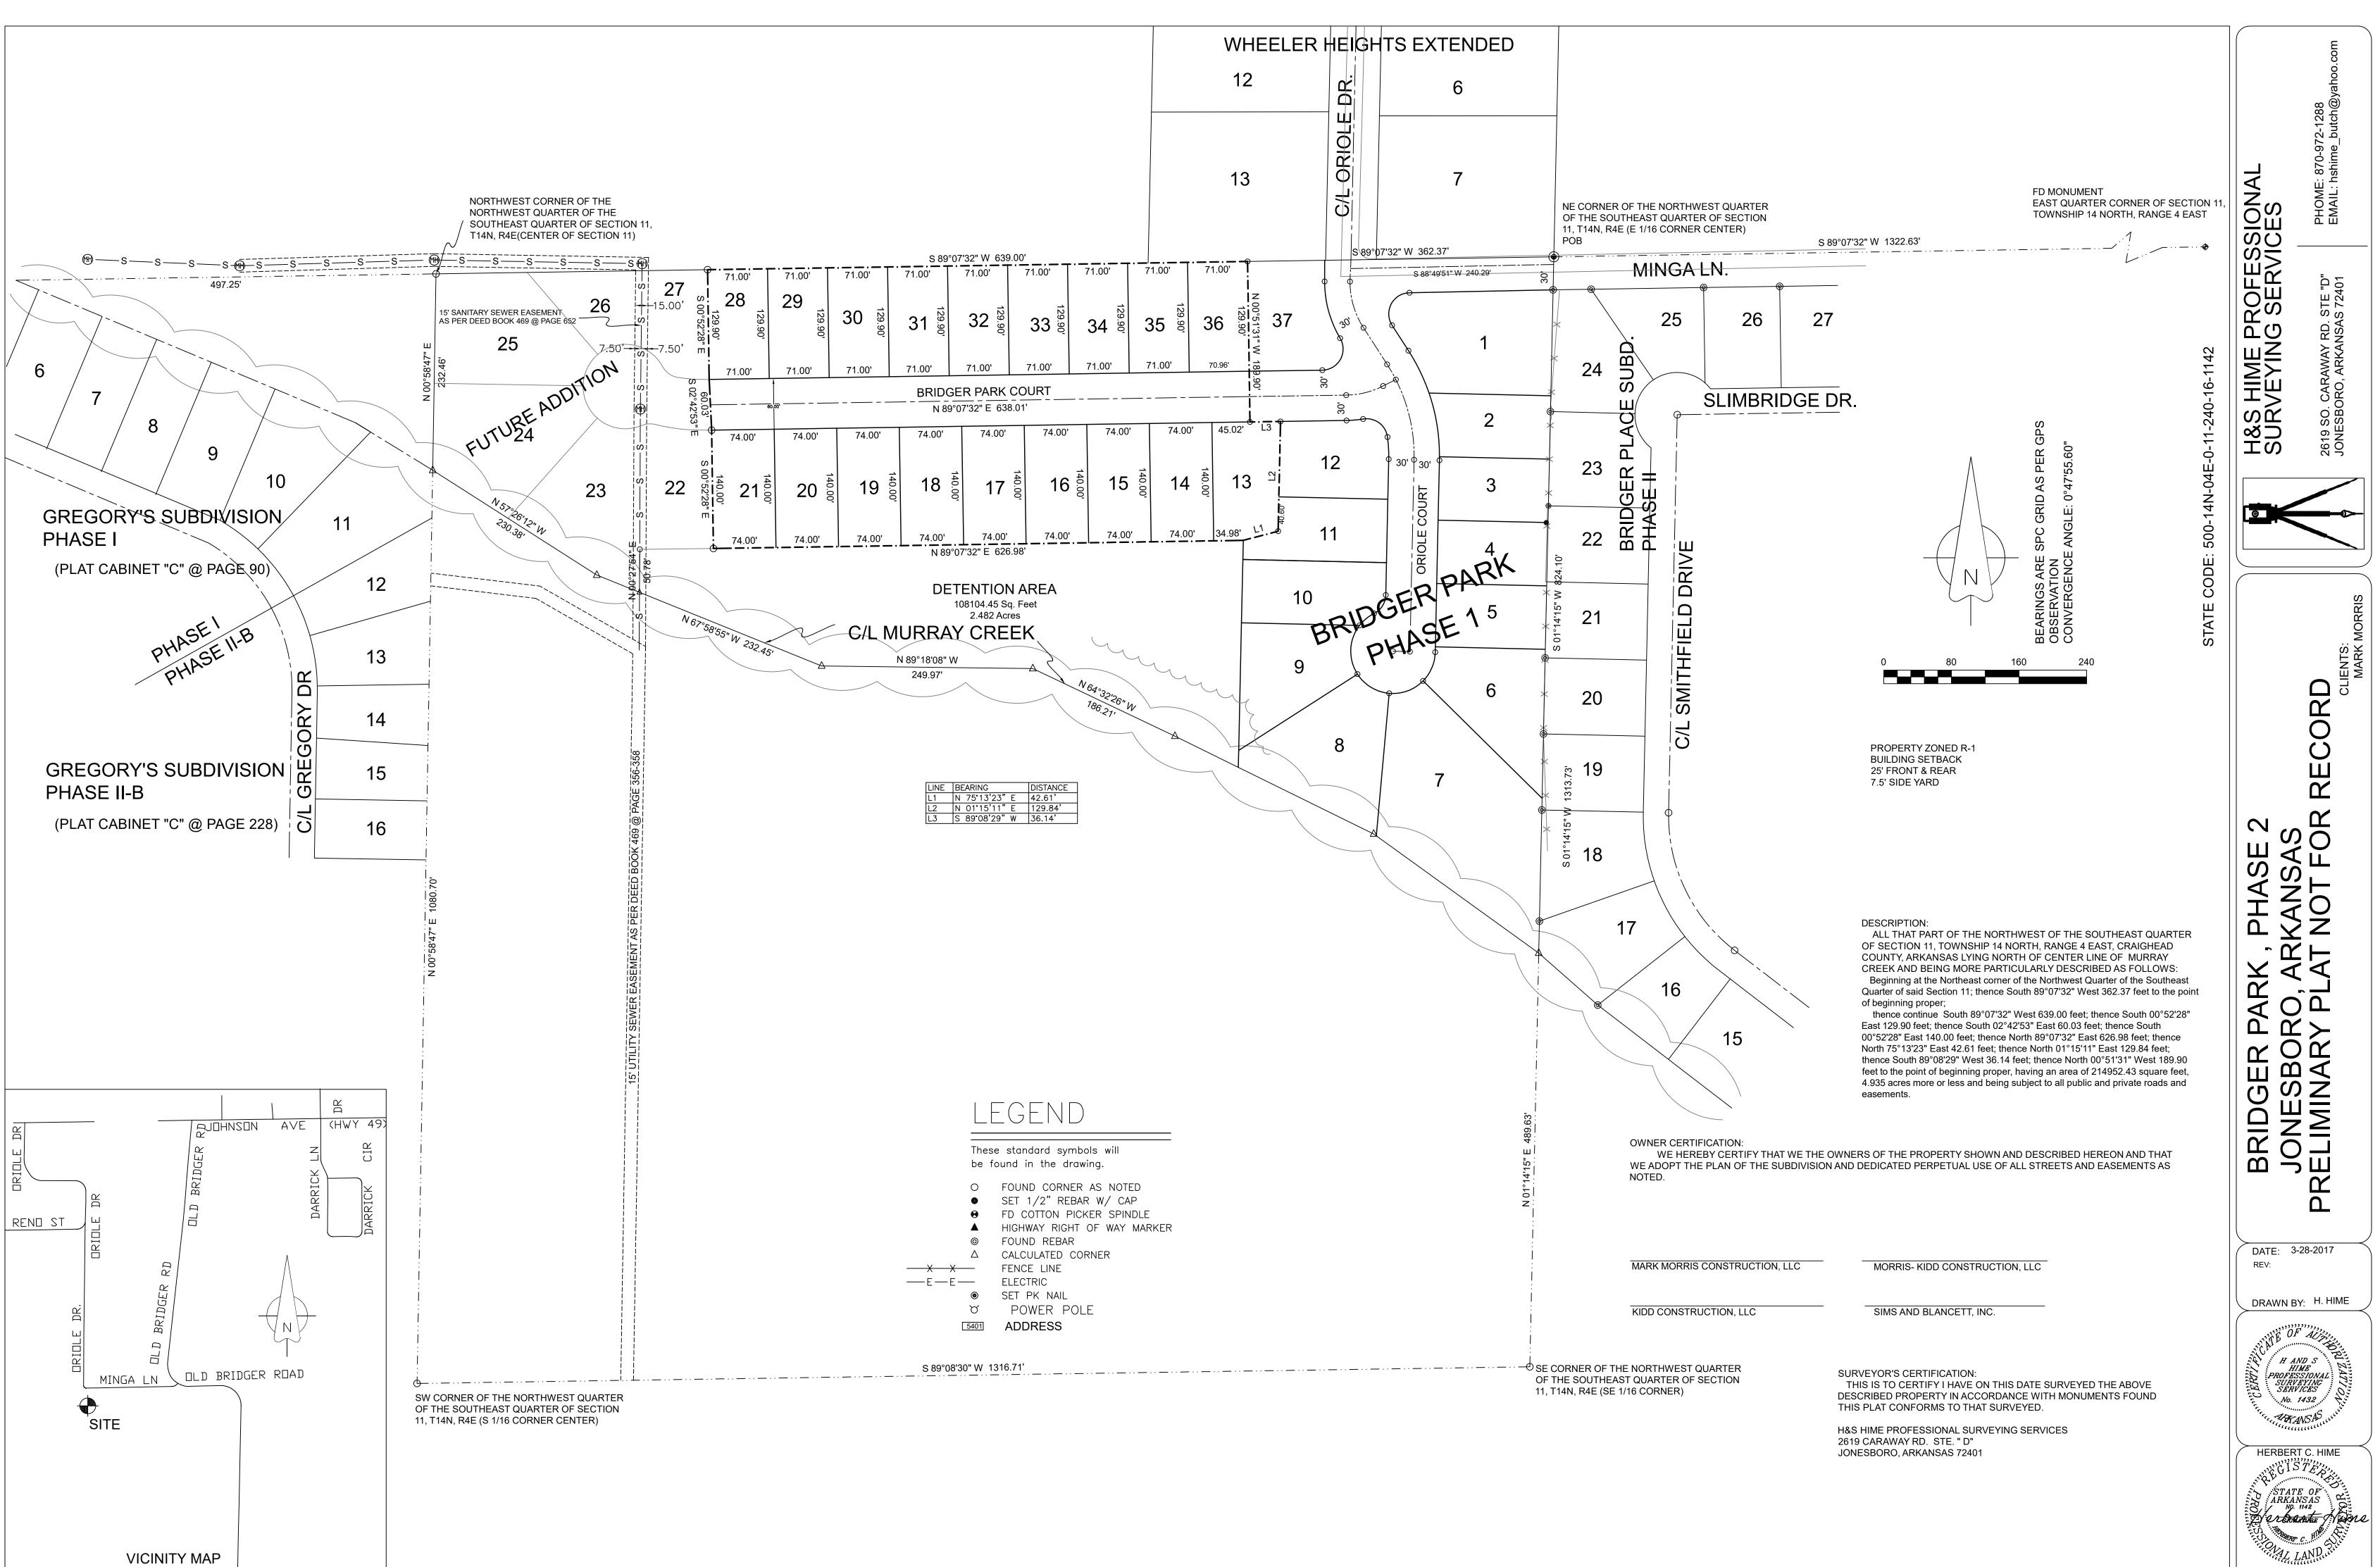

PLS # 1142

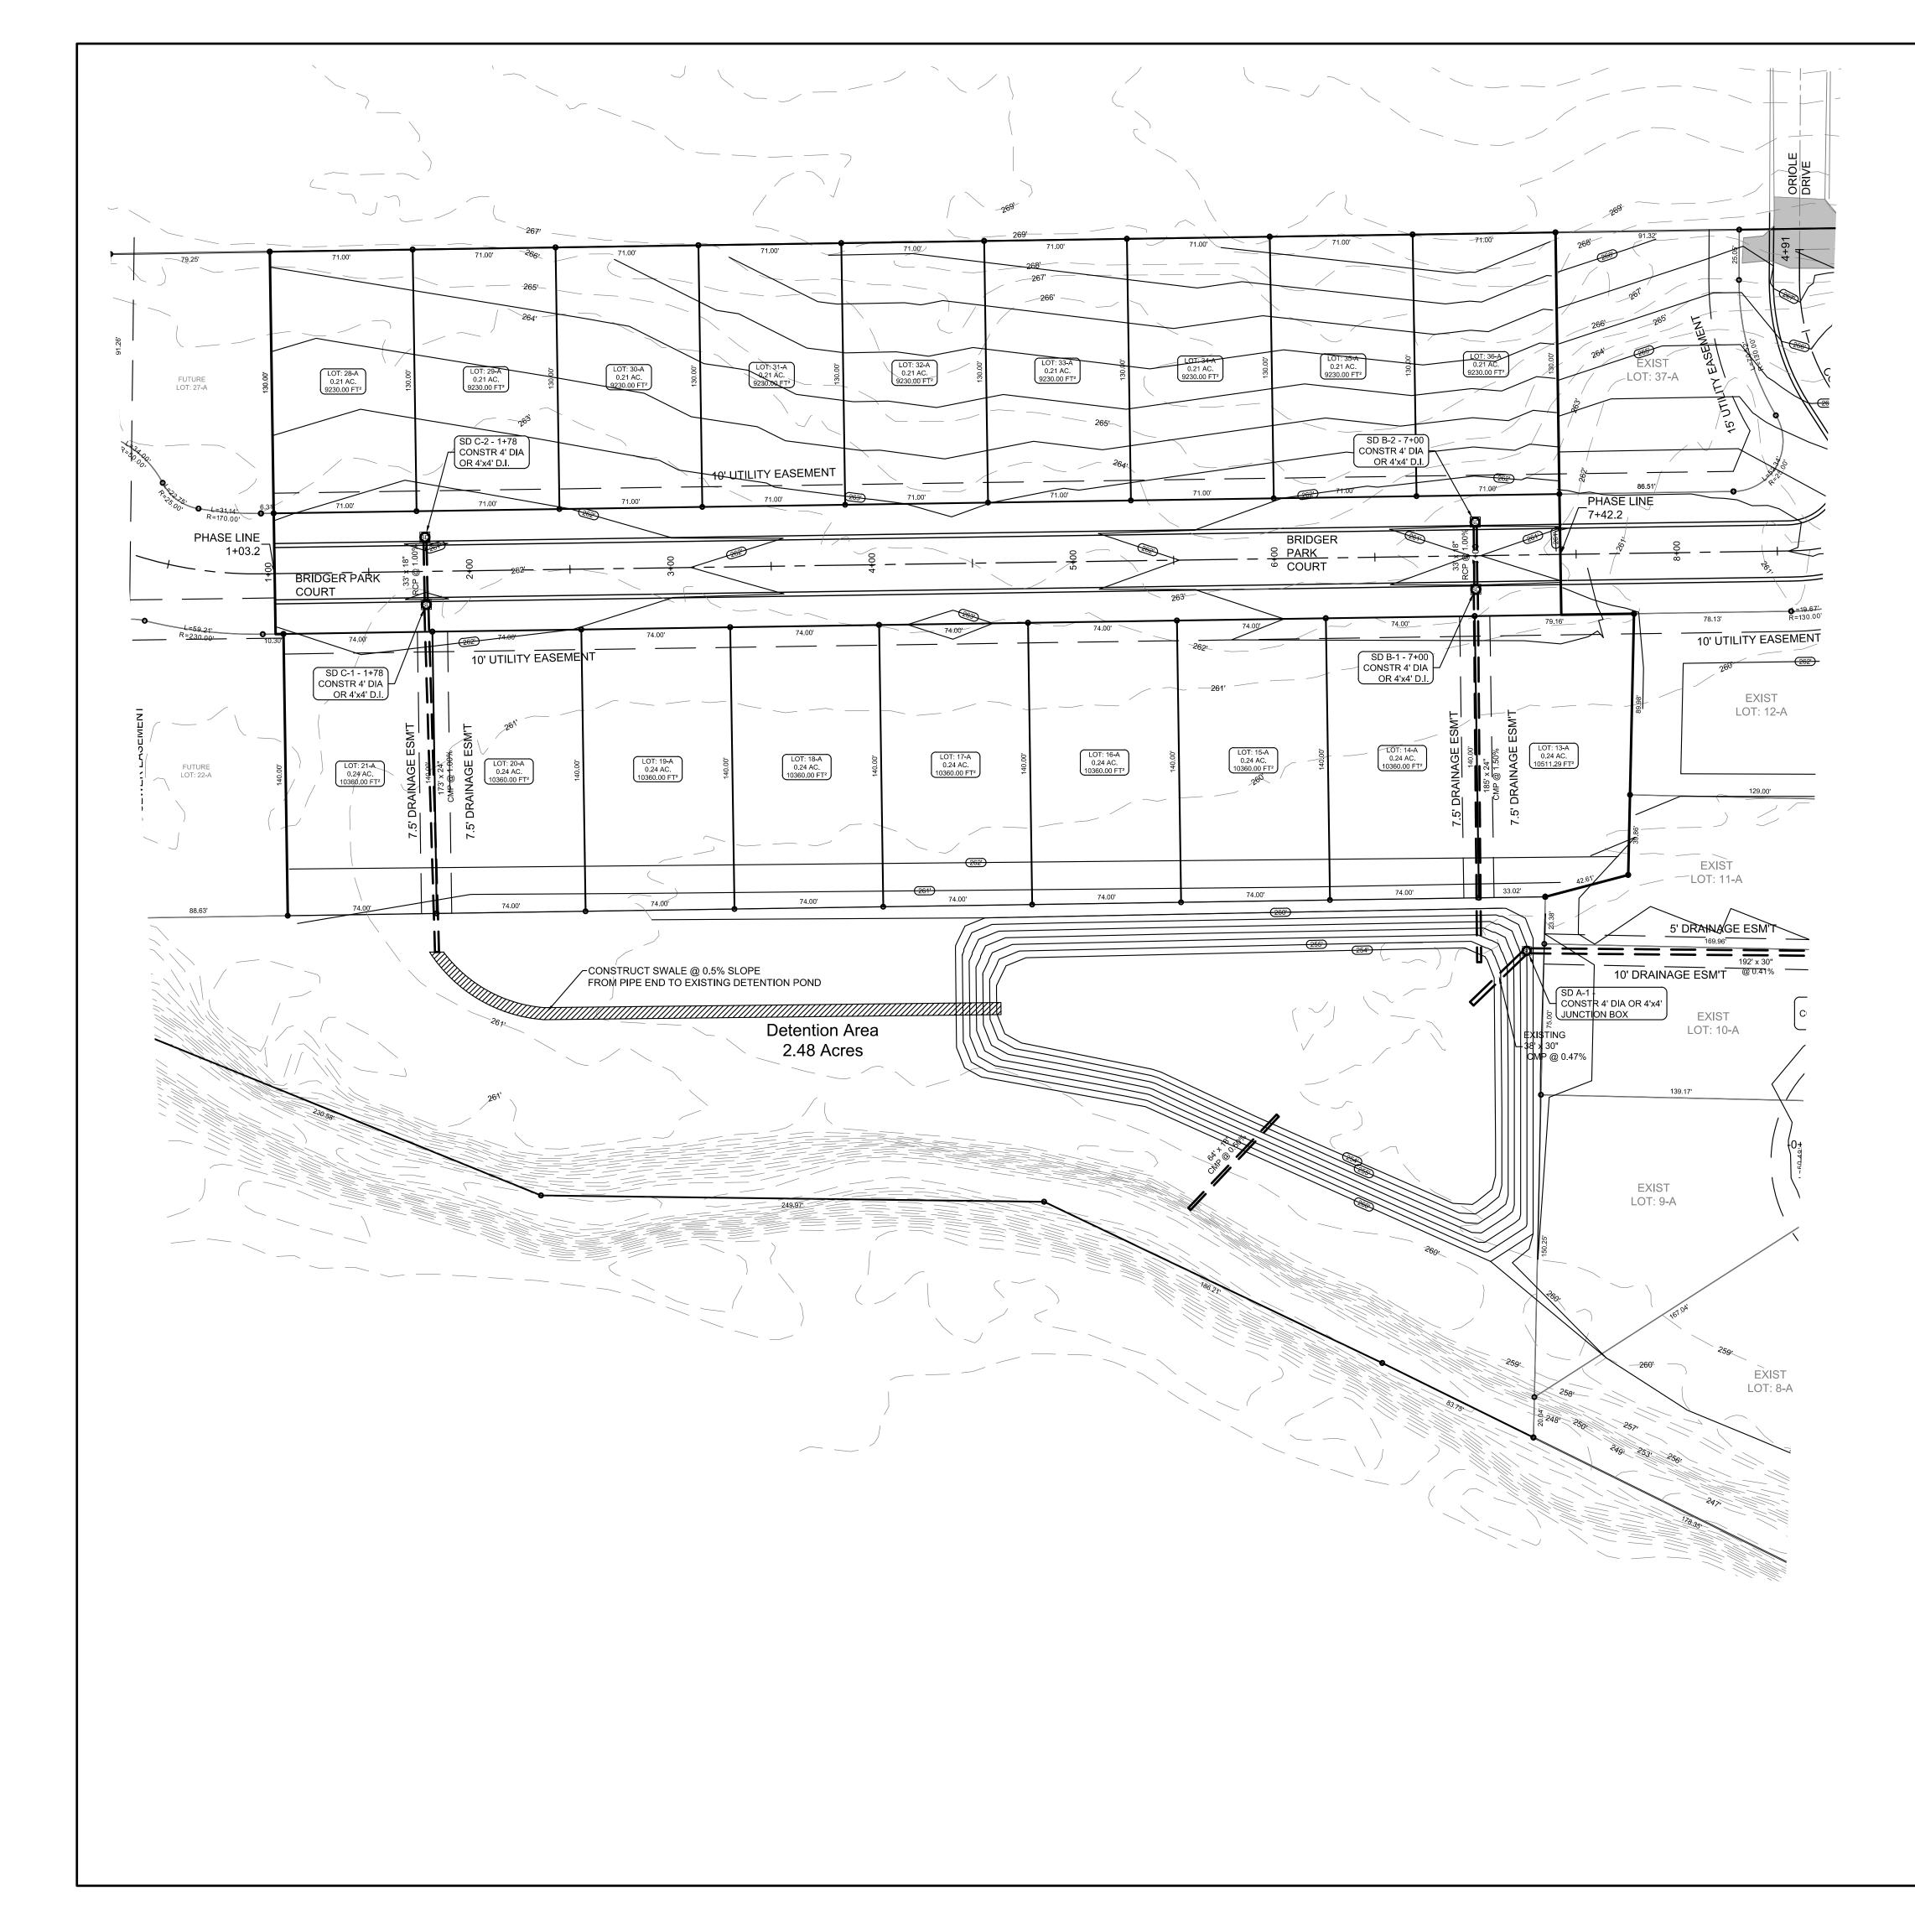

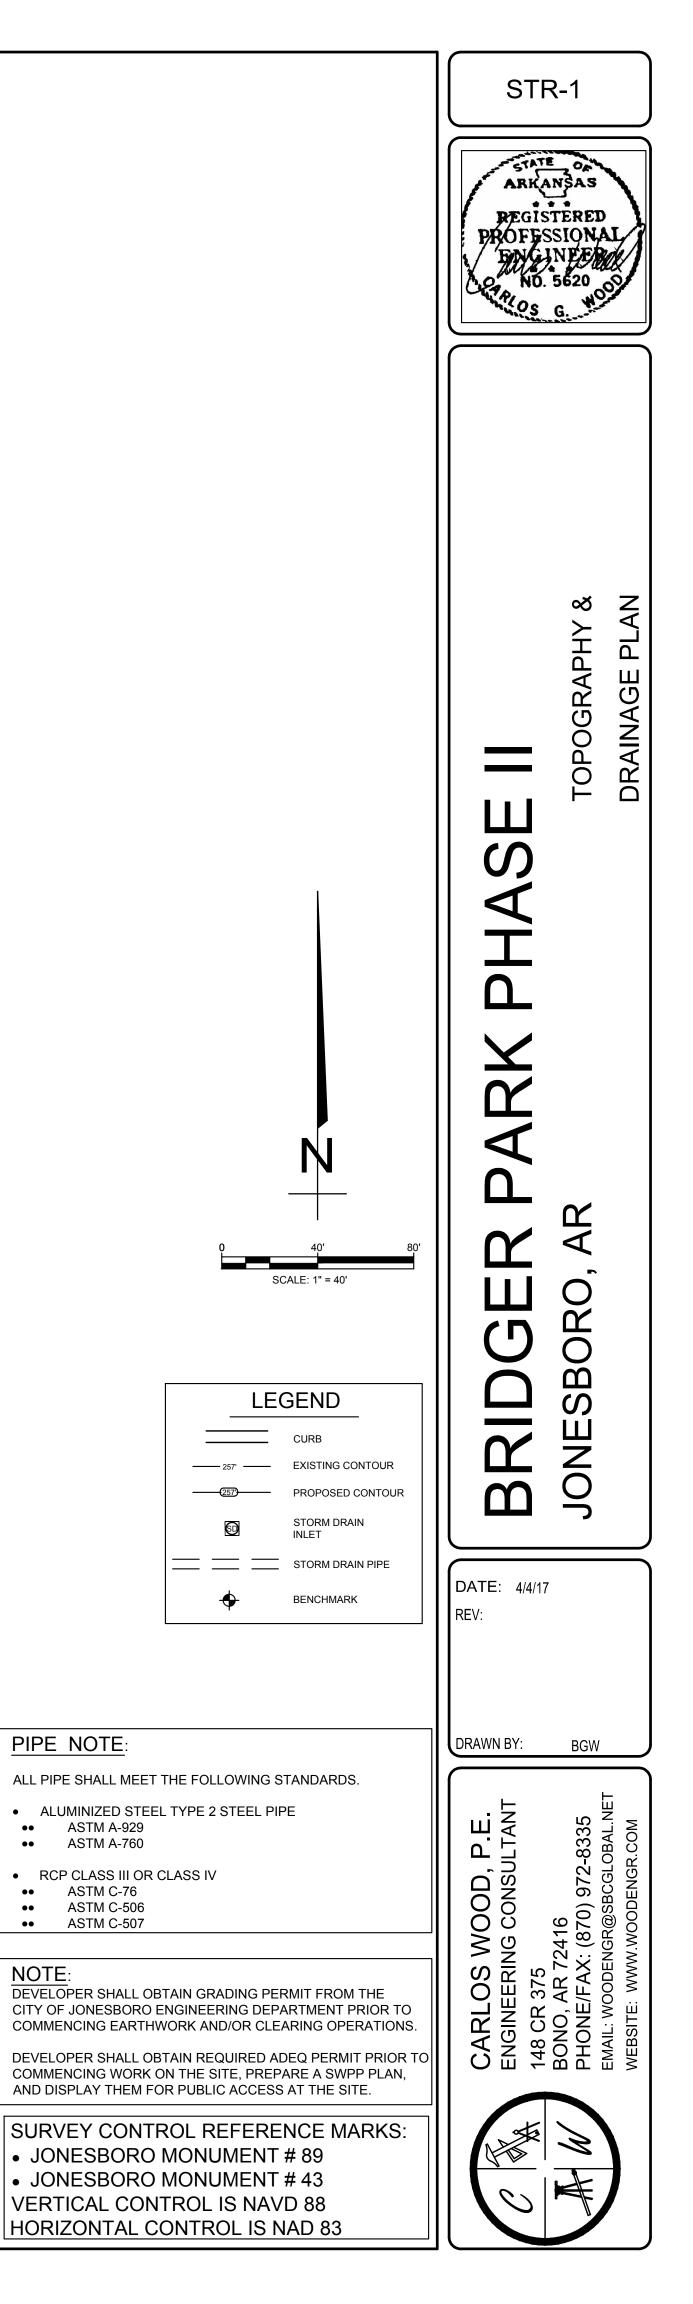

PIPE NOTE:


•• ASTM A-929


•• ASTM A-760

•• ASTM C-76 •• ASTM C-506 •• ASTM C-507

NOTE:


RCP CLASS III OR CLASS IV

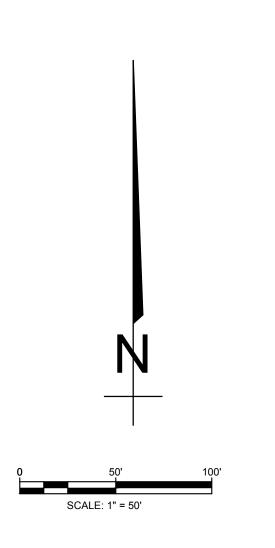

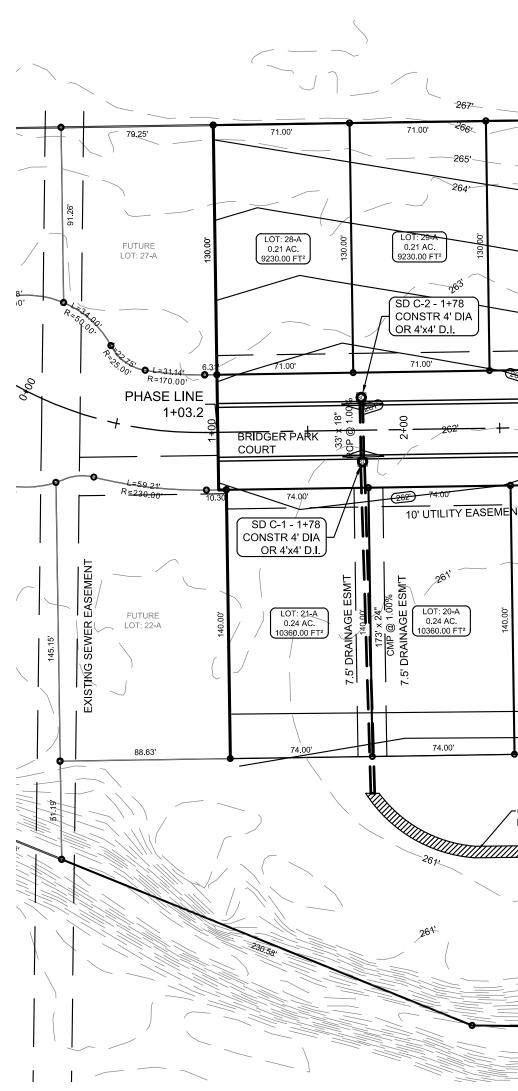

PROFILE SCALE:

HORIZONTAL: 1" = 50' VERTICAL: 1" = 5'

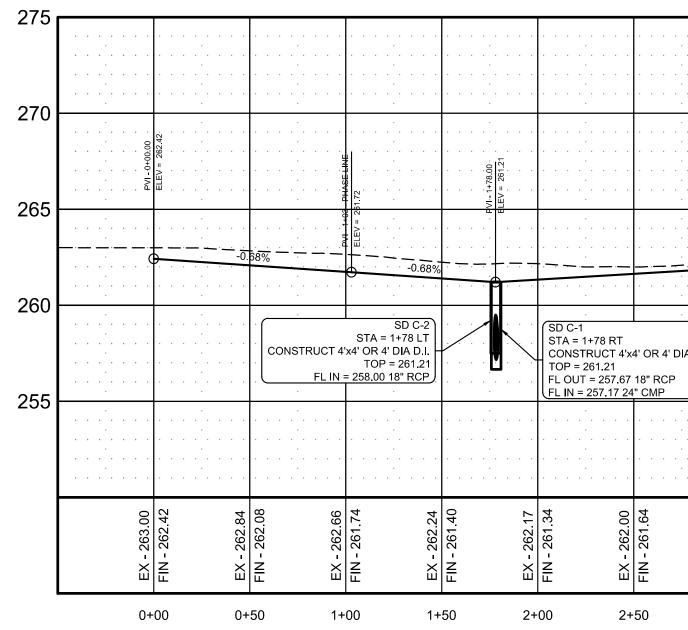

BRIDGER PARK COURT

				Detentior 2.48 A	ר A Cre	Area es							\ -38	(ISTIN 5' x 30' MP @	NG LOT: 10 9 0.47%		
											X				139.17'		
				249.97								260		50.25'	EXIST LOT: 9-A		
	· ·		•		•		· ·	· · ·		· ·				· · ·			
	· · ·			 	•		• •	· · ·		· ·		· · · · · · · · · · · · · · · · · · ·	ElEV = 260.388	· · · ·		PVI - 8+55.00 ELEV = 262.01	
	. <u>0</u> .6	<u>50%</u>					· · ·	· · · ·	-0.69%	· ·					0.66%	0.86°	»
4' DIA D.I.	· · •	· · · · · · · · · · · · · · · · · · ·	•		•••	· · · ·			SE STA = 7+0 JCT 4'x4' OR 4' DIA TOP = 26 OUT = 257.80 18"	A D.I.		CON TOP FL IN	3-1 = 7+00 RT NSTRUCT 4'x4' OR 4' DIA D.I. P = 260.98 N = 256.97 24" CMP N = 257.47 18" RCP	· · · · · · · · · · · · · · · · · · ·	•
· · · · · · · ·	· ·		•	· · · · · · · · · · · · · · · · · · ·	•		· ·	· · · ·		· ·	· · · · · · · · · · · · · · · · · · ·			· · · ·		· · · · · · · · · · ·	• • •
EX - 262 18	FIN - 261.94	EV 262.43	C4 202 - VJ	FIN - 262.24 EX - 262.81	FIN - 262.54		EX - 262.99	FIN - 262.37	EX - 263.50 FIN - 262.02	EX - 263.53	FIN - 261.67 EX - 263.12	FIN - 261.33 EX - 262.46	FIN - 260.98	FIN - 261.31	EX - 261.00 FIN - 261.64	FIN - 261.98	EX - 260.60
3	+00	3	3+5	50 4+	+00	4+50	5-	+00	5+50	6+(00 6+	-50 7-	+00 7	+50	8+00 8	+50	9+


					71.00'	71.00'	268	91.32	<u> </u>
71.00'	71.00'	71.00	71.00'	71.00'	/ /1.00				4+91
			267'						
			266'					267	
				\backslash					_ `,
			/				266'		
				LOT: 34-A	(LOT: 35-A)	2 LOT: 36-	A 8 264	EXIST SA ST	¶€€
LOT: 30-A 0.21 AC. 9230_00 FT ²	LOT: 31-A 9.21 AC. 9230,05 ET ²	LOT: 32-A 0.21 AC. 9230 00 FT ²	LOT: 33-A 0.21 AC 9230.00 FT ²	0.21 AC. 9230.00 FT ²	0.21 AC. 9230.00 FT ²	0.21 AC 9230.00 F		LOT: 37-A	\mathcal{M}
9230.00 FT ²	9230,00 ET2	9230.00 FT2	(9230.00 FT ²)	(9230.00 FT-) (ECT. STA	\checkmark
							2 A	Ē	
		<pre></pre>	-265'			1		[2] [3]	Ł
					SD B-2 CONSTR	4' DIA			
	10'UTILITY EASEMENT				OR 4'>	(4' D.I.)	ă,		00
			71.00	71.00'	(262) 71.00	71.00	₹ <u>₹</u>	86.51 P	ÿ~
71.00'	71.00'	263') 71.00'	71.00	\ , , , , , , , , , , , , , , , , , , ,			PHA	SELINE	_ \
(The second seco	\geq	\sim					7+42		\geq
					BRIDGER	1:00		. 00 <u>.</u>	
ц	+	<u>→</u> → →			<mark>∋ park</mark> — – 5 court				
T – Ť		4	~~~~~~~~~~~~~~~~~~~~~~~~~~~~~~~~~~~~~~			CP 33		¥	
				263'		\ ∦ ∕			\searrow
				74.00		4.00	79.16'	78.13'	R=1
74.00'	74.00'	74.00	74.00			┥──┤╡		10' UTILITY EAS	SEM
MENT				262'	SD B-1	- 7+00			
					CONSTR	x4' DIA		260	-
			_ /					B EXIST	Г
~								ଟ୍ଟ LOT: 12	2-A
						ESM			
ELOT: 19-A	5 LOT: 18-A	bo LOT: 17-A	D LOT: 16-A	B		лт: 14-А 24 AC	В Ц LOT: 13-А С О 0.24 AC.		
0.24 AC	0.24 AC. 10360.00 FT ²	LOI: 17-A 0.24 AC. 10360.00 FT ²	00 01 024 AC 10360.00 FT ²	LOI: 15-A 0.24 AC 10360.00 F		50.00 F ²	$\overset{\sim}{=} \overset{\sim}{=} \overset{\sim}{=} \underbrace{10511.29 \text{ FT}^2}_{\text{R}}$		
₹ <u>10360.00 FT</u> 2				260		140.00 140.00 140.00 140.00 140.00 150 140.00 150 140.00 150 140.00 150 140.00 150 140.00 150 140.00 150 150 150 150 150 150 150 1	MB MU MC MC MC MC MC MC MC MC MC MC	129.00'	
							2.		
						\ I		ne en e	
		262						EXIST	
		(264)		74.00'		• 74.00'	33.02' 42.61	LOT: 11-A	
74.00	74.00'	261' 74.00'	74.00'		260')	14.00			
	-			(200)			5' DRAHNAGE ESM'T	
		111			(255) (254)				
						' * * *			
FROM PIPE END TO EXI	0.5% SLOPE ISTING DETENTION POND	((/					192' x <u>30"</u> 10' DRAINAGE ESM'T @ 0.41%	
·					\sim		SD A-1 - CONSTR 4	' DIA OR 4'x4'	s
	Detention							IBOX EXIST	CO
	Detention					$ \sum $	EXISTING 38' x 30"	LOT: 10-A	
\sim	2.48 Ac	res \\\\			. /		CMP @ 0.47%		/
								,	/ .
	\sim							139.17'	\checkmark
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\rightarrow	249.97						ン川川	LOT: 9-A	
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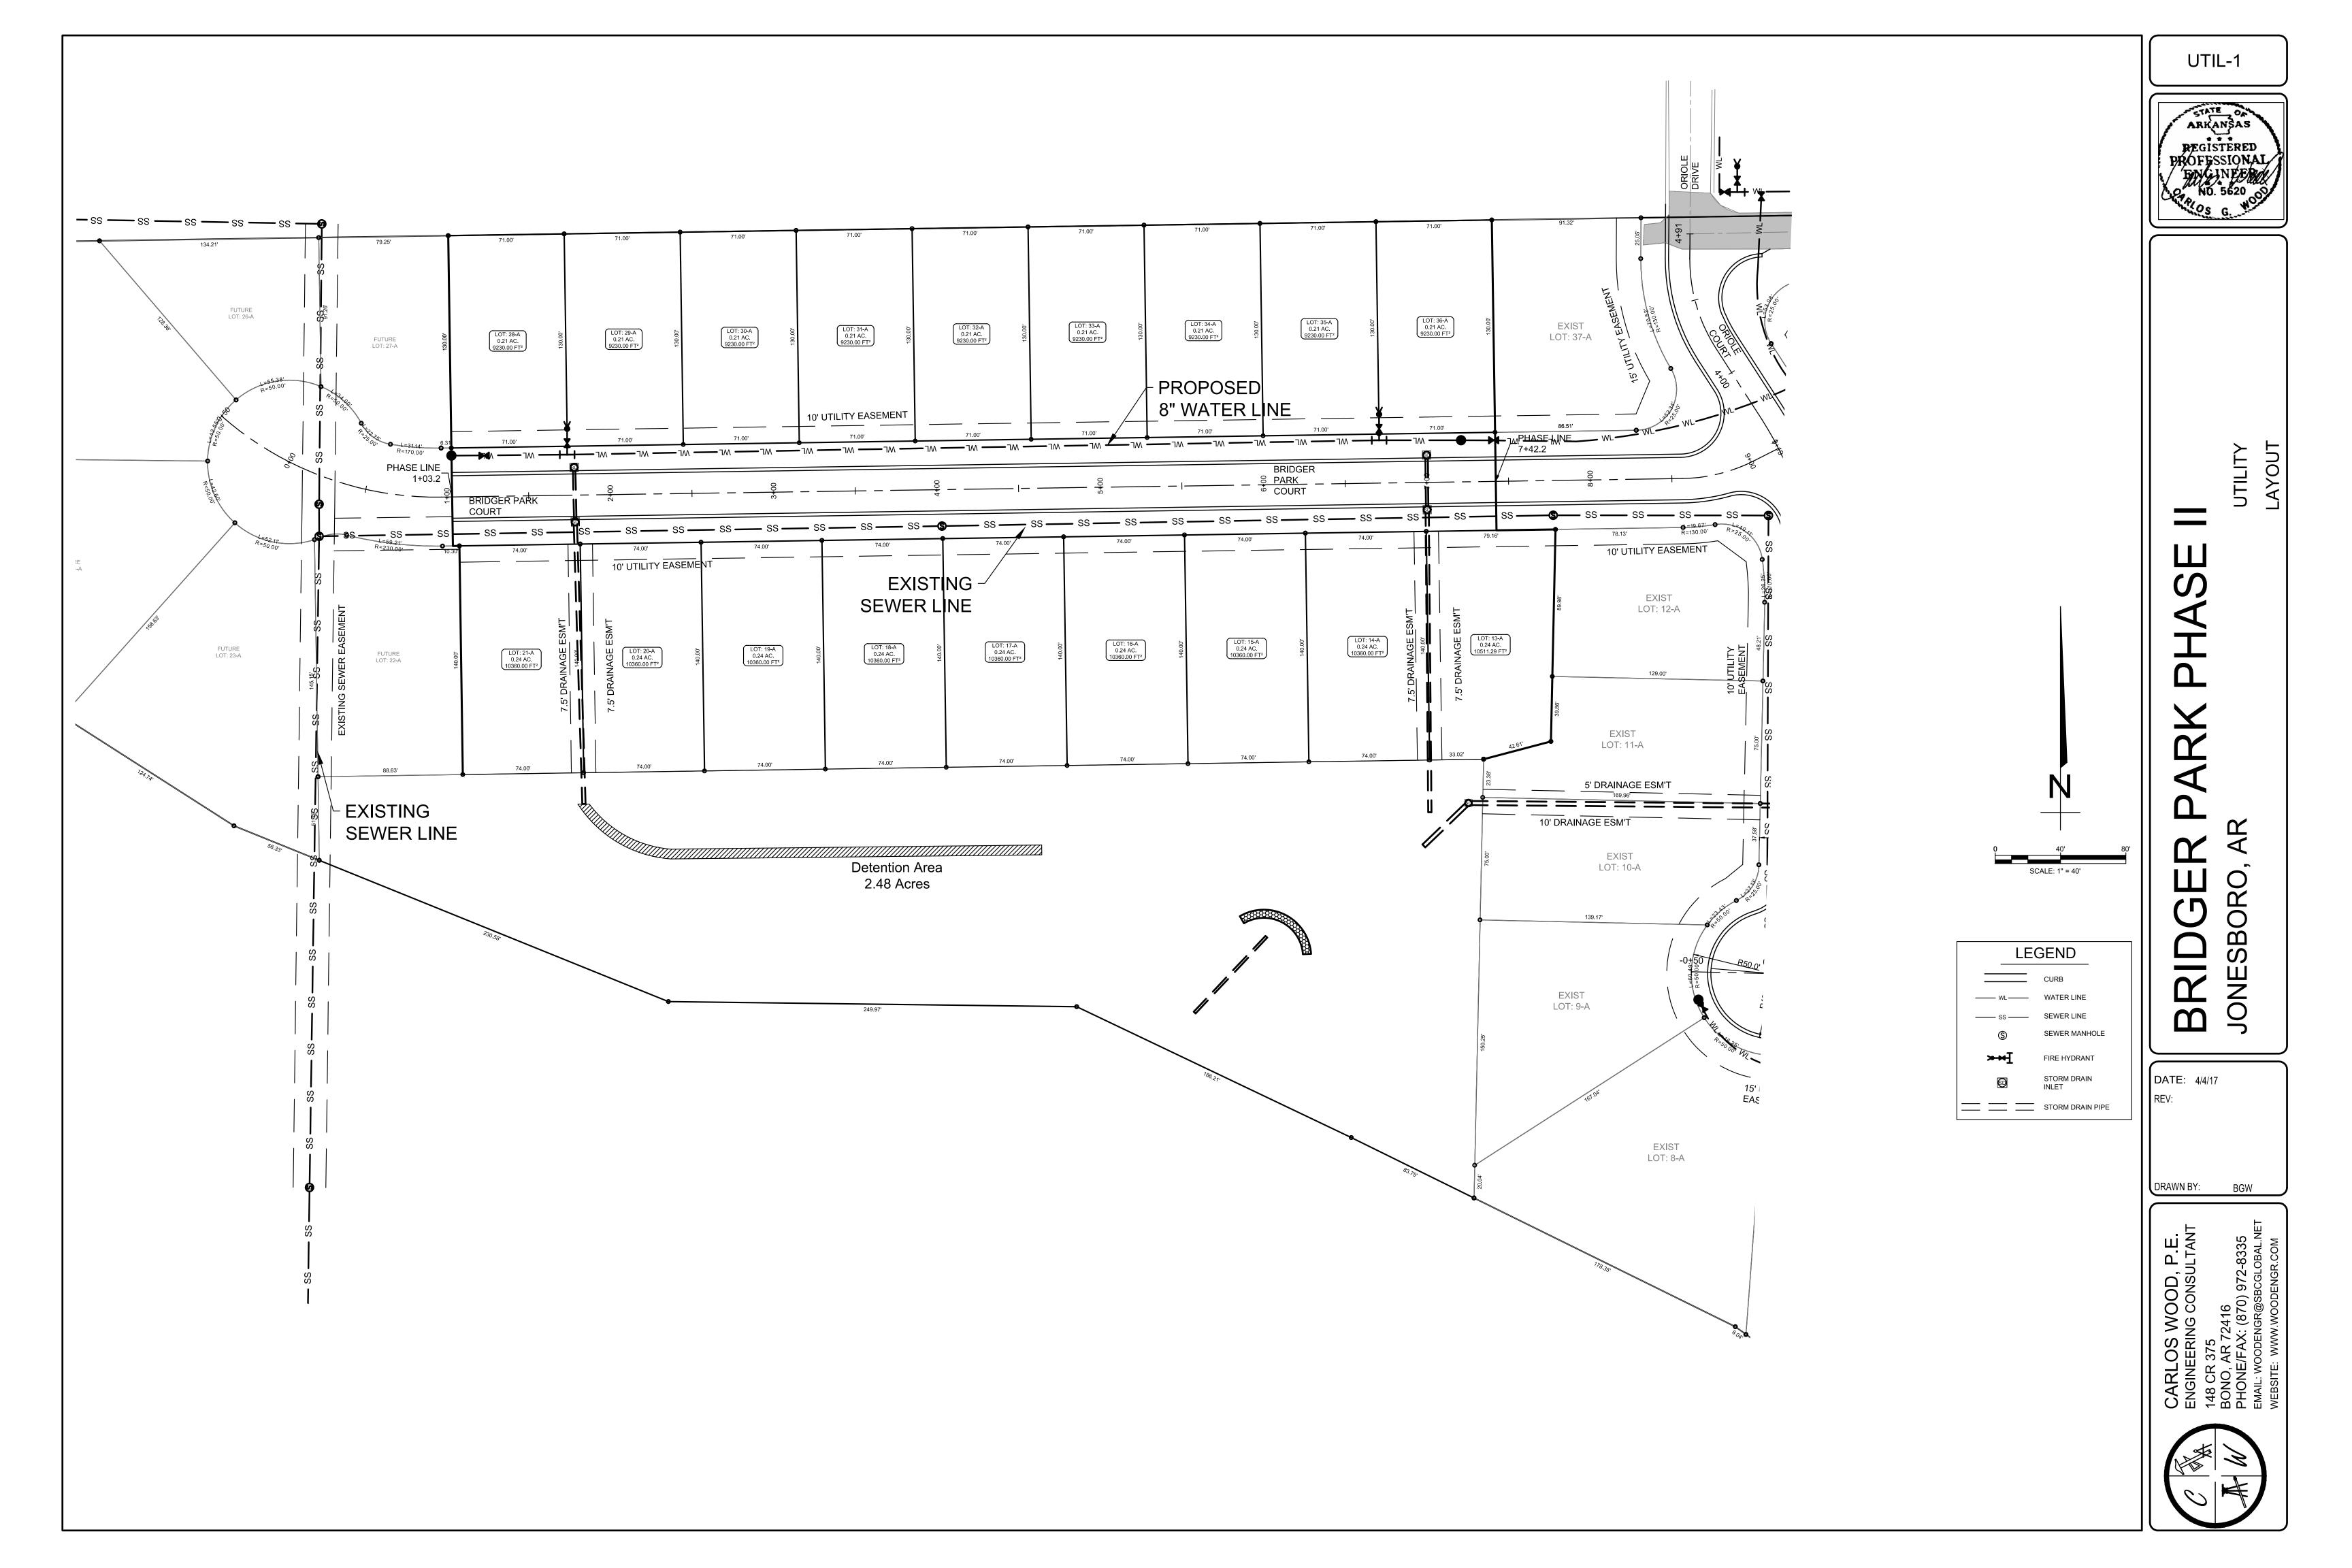
PIPE NOTE:


ALL PIPE SHALL MEET THE FOLLOWING STANDARDS.

- ALUMINIZED STEEL TYPE 2 STEEL PIPE
- •• ASTM A-929 •• ASTM A-760
- RCP CLASS III OR CLASS IV
- •• ASTM C-76
- •• ASTM C-506 •• ASTM C-507

LEC	GEND	STR-2	
 - 257' -257) 5D 	CURB EXISTING CONTOUR PROPOSED CONTOUR STORM DRAIN INLET STORM DRAIN PIPE	ARKANSAS REGISTERED PROFESSIONAL ENVEINEE NO. 5620 ACC ACC ACC ACC ACC ACC ACC AC	
		PARK PHASE II BRIDGER PARK COURT PLAN & PROFILE	
		BRDIGER PARK Jonesboro, AR	
		DATE: 4/4/17 REV:	
		DRAWN BY: BGW	
		CARLOS WOOD, P.E. ENGINEERING CONSULTANT 148 CR 375 BONO, AR 72416 PHONE/FAX: (870) 972-8335 EMAIL: WOODENGR@SBCGLOBAL.NET WEBSITE: WWW.WOODENGR.COM	



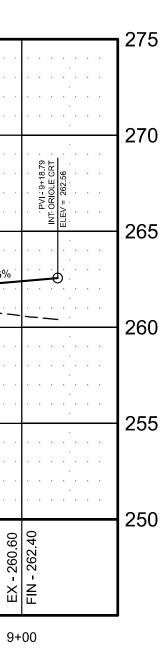

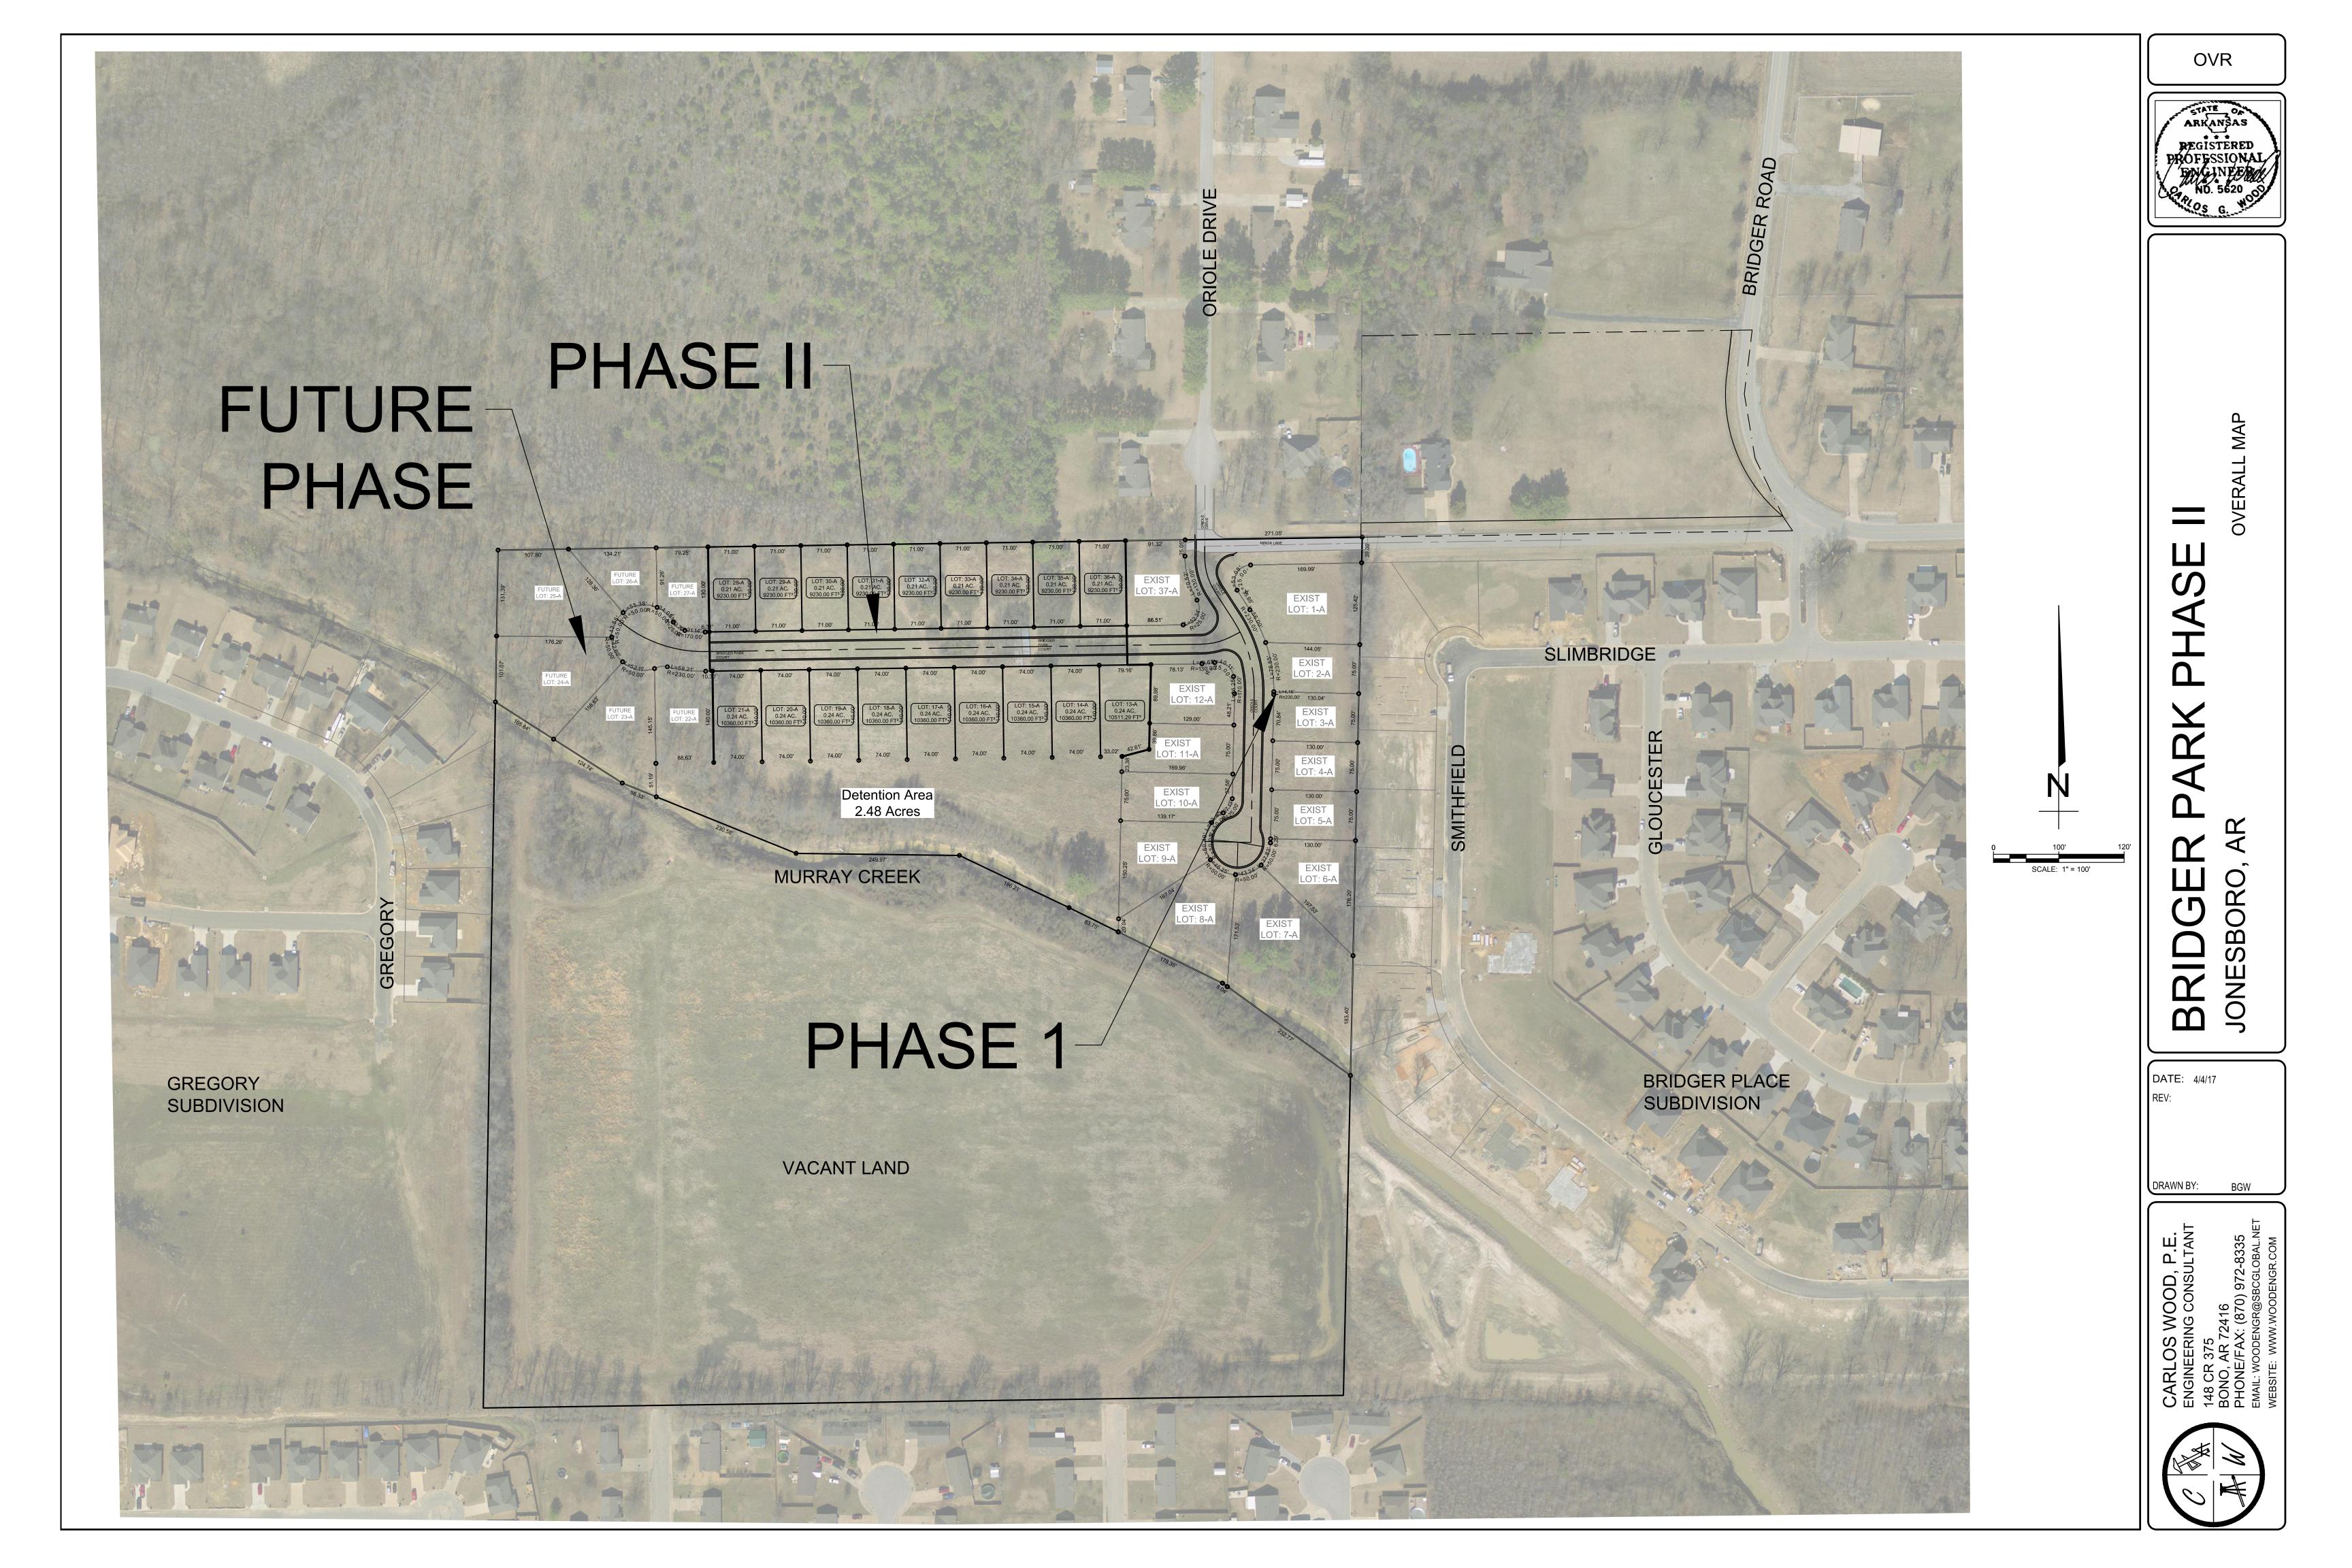

I. THIS DRAWING REPRESENTS THE SCHEMATIC MAP OF THE LOCATION AND TYPE OF THE MINIMUM EROSION CONTROL MEASURES ANTICIPATED FOR THIS SITE AND SHALL BE CONSIDERED A PART OF THE STORM

LOCATION FOR REVIEW AND INSPECTION BY THE APPROPRIATE INSPECTORS.

BE SHOWN ON THE MAP AFTER INSTALLATION 9. A TEMPORARY SANITARY SEWER CONTAINER SHALL BE PROVIDED AS NEEDED. LOCATION TO BE SHOWN ON THE MAP AFTER INSTALLATION. LOCATION TO BE SHOWN ON THE MAP AFTER INSTALLATION

LOCATIONS CONSTRUCTION VEHICLES LEAVE THE SITE TO PREVENT DUST AND MUD TRACKING ONTO NECESSARY TO MAINTAIN CLEAN STREETS AND AT A MINIMUM OF THE END OF THE DAY.

