### COMMERCIAL SITE DEVELOPMENT PLANS


# HYATT PLACE @ CENTER PARK

BROWNS LANE ACCESS

PREPARED FOR

NORTHEAST ARKANSAS HOTELS AND CONVENTION CENTER, LLC

JONESBORO, ARKANSAS MAY, 2016

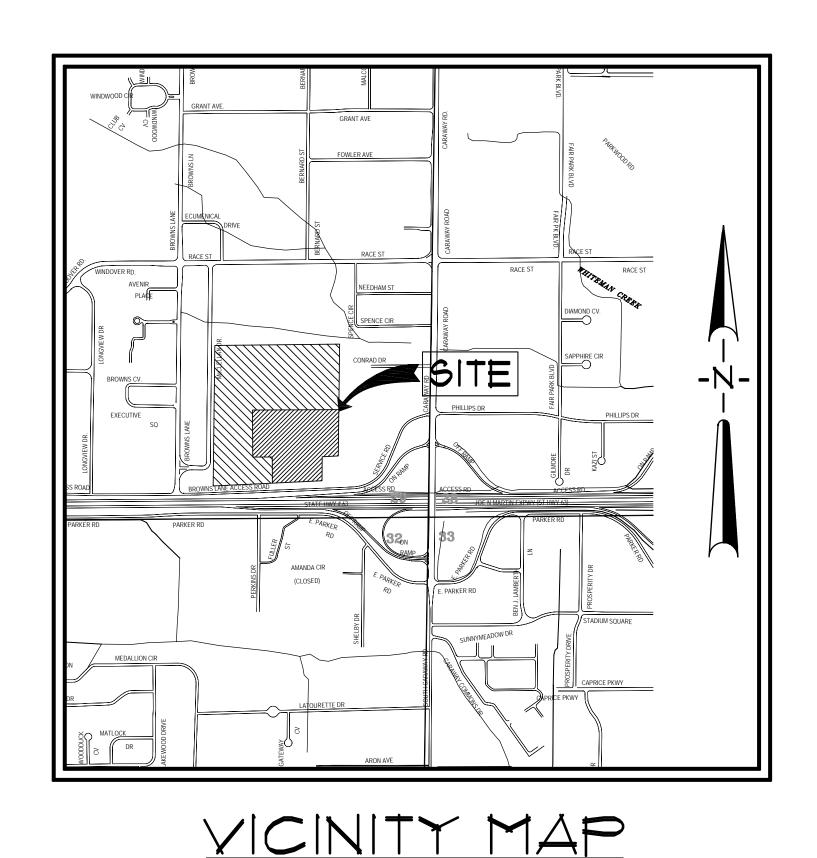


SCALE: 1" = 1,000



### INDEX TO SHEETS

INDEX SHEET GENERAL NOTES TOPOGRAPHIC SURVEY RECORD PLAT SITE PLAN - OVERALL SITE PLAN - ENLARGED UTILITY PLAN - OVERALL UTILITY PLAN - ENLARGED GRADING PLAN - OVERALL GRADING PLAN - ENLARGED EROSION CONTROL PLAN - OVERALL EROSION CONTROL PLAN - ENLARGED STANDARD DETAILS STANDARD DETAILS

EROSION CONTROL DETAILS

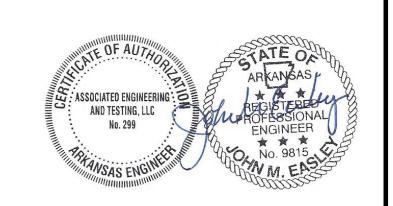


ASSOCIATED ENGINEERING AND TESTING, LLC CIVIL ENGINEERING AND LAND SURVEYING SERVICES 103 SOUTH CHURCH STREET - P.O. BOX 1462 - JONESBORO, AR 12403 PH: 870-932-3594 FAX: 870-935-1263

COYER SHEET SITE DEVELOPMENT PLANS HYATT PLACE @ CENTER PARK JONESBORO, ARKANSAS

ADD CENTERLINE LLC PHASE DIAGRAM 1 05/11/16 WEST DRIVE CONSTRUCTION NOTES C Copyright 2016 AETLLC REY DATE REVISIONS

CHECKED: JME DATE: 05/11/16

JME JME **DRAWN**: CCH DRAUN CHK'D SCALE: AS SHOWN CADD FILE: 13179-5DP-R2 DWG. 0414292.0038

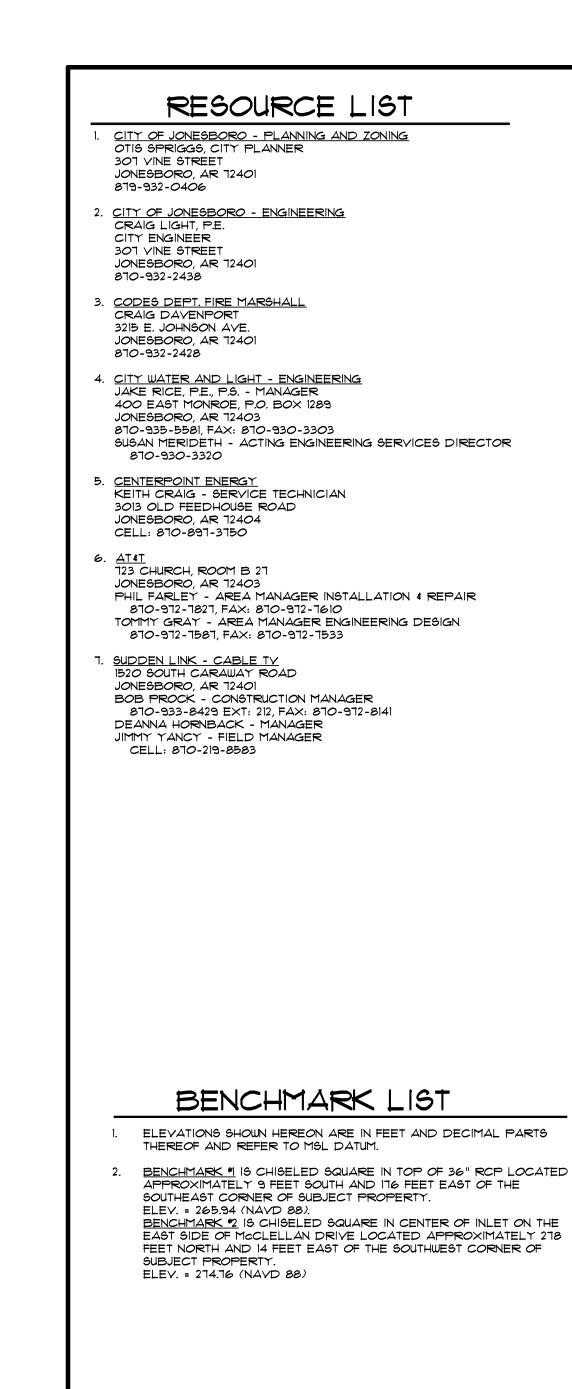

- - BOUNDARY LINE

= LOT LINES

= FOUND IRON PIPE

= FOUND REBAR

= BENCH MARK

= R/W MONUMENT

= EXISTING WATER LINE

= WATER VALVE

= EXISTING WATER METER

= PROPOSED WATER METER

= PROPOSED WATER LINE

= FOUND COTTON-PICKER SPINDLE

= FOUND IRON PIPE W/ PLS \*XXX CAP

= SET 1 1/4" IRON PIPE W/ PLS #1549 CAP

= EXISTING SANITARY SEWER LINE

= PROPOSED SANITARY SEWER LINE

= EXISTING SANITARY SEWER MANHOLE

= EXISTING SANITARY SEWER CLEANOUT

= PROPOSED SANITARY SEWER MANHOLE

= PROPOSED SANITARY SEWER CLEANOUT

= PROPOSED SANITARY SEWER SERVICE LINE

= CITY OF JONESBORO G.P.S. MONUMENT

GENERAL NOTES

REVISION DATE - JUNE 25, 2007.

3. EASEMENTS ARE AS SHOWN.

SUBJECT PROPERTY.

OTHERWISE NOTED.

2. SCREENING AND BUFFERING ARE AS SHOWN.

SUBJECT PROPERTY IS LOCATED WITHIN "X", AREAS DETERMINED TO BE OUTSIDE 150-YEAR FLOOD, PLAIN AS

AGENCY FLOOD INSURANCE RATE MAPS FOR JONESBORO,

DESIGNATED BY FEDERAL EMERGENCY MANAGEMENT

COMMUNITY PANEL 05031C0132C (PANEL 132 OF 200). EFFECTIVE DATE - SEPTEMBER 27, 1991.

4. NO KNOWN HISTORICAL STRUCTURES ARE LOCATED ON

5. DIMENSIONS SHOWN ARE TO THE FACE OF CURB UNLESS

LEGEND

= FIRE HYDRANT

= VALVE BOX

= POWER POLE

= FIRE PROTECTION

= EXISTING OVERHEAD ELECTRICAL LINE

= POWER JUNCTION, COMM. BOX

= SIGN LIGHTS/FLOOR LIGHTS

= LIGHT POLE (BACK-BACK)

= LIGHT POLE (SINGLE))

= LIGHT POLE (3 @ 90°)

= TRAFFIC LIGHT CONTROL

= TRAFFIC SIGNAL W/ POLE

= TELEPHONE PEDESTAL

= EXISTING STORM WATER MANHOLE

= EXISTING GAS LINE

= GAS METER

= EXISTING OVERHEAD COMMUNICATION LINE

= EXISTING UNDERGROUND COMMUNICATION LINE

= TRAFFIC SIGN

= TRAFFIC SIGNAL

000

= EXISTING UNDERGROUND ELECTRICAL LINE

= ELECTRIC TRANSFORMER/ELECTRIC METER

= GRATED INLET

= SPRINKLER CONTROL

= TRASH COMPACTOR

= DOWNSPOUT

= MAILBOX

= COLUMN

= BOLLARD

= HANDICAP SIGN

= EXISTING FENCE LINE

= EXISTING TREE/SHRUB

= GENERAL DRAINAGE FLOW

= SWALE FLOW DIRECTION

= ROCK CHECK DAM

= INLET PROTECTION

= ROCK CHECK DAM

= RIP RAP AREA


BASIN BOUNDARY


= DRAINAGE FLOW


= SILT FENCE


= EXISTING GROUND CONTOUR


FINISHED GROUND CONTOUR

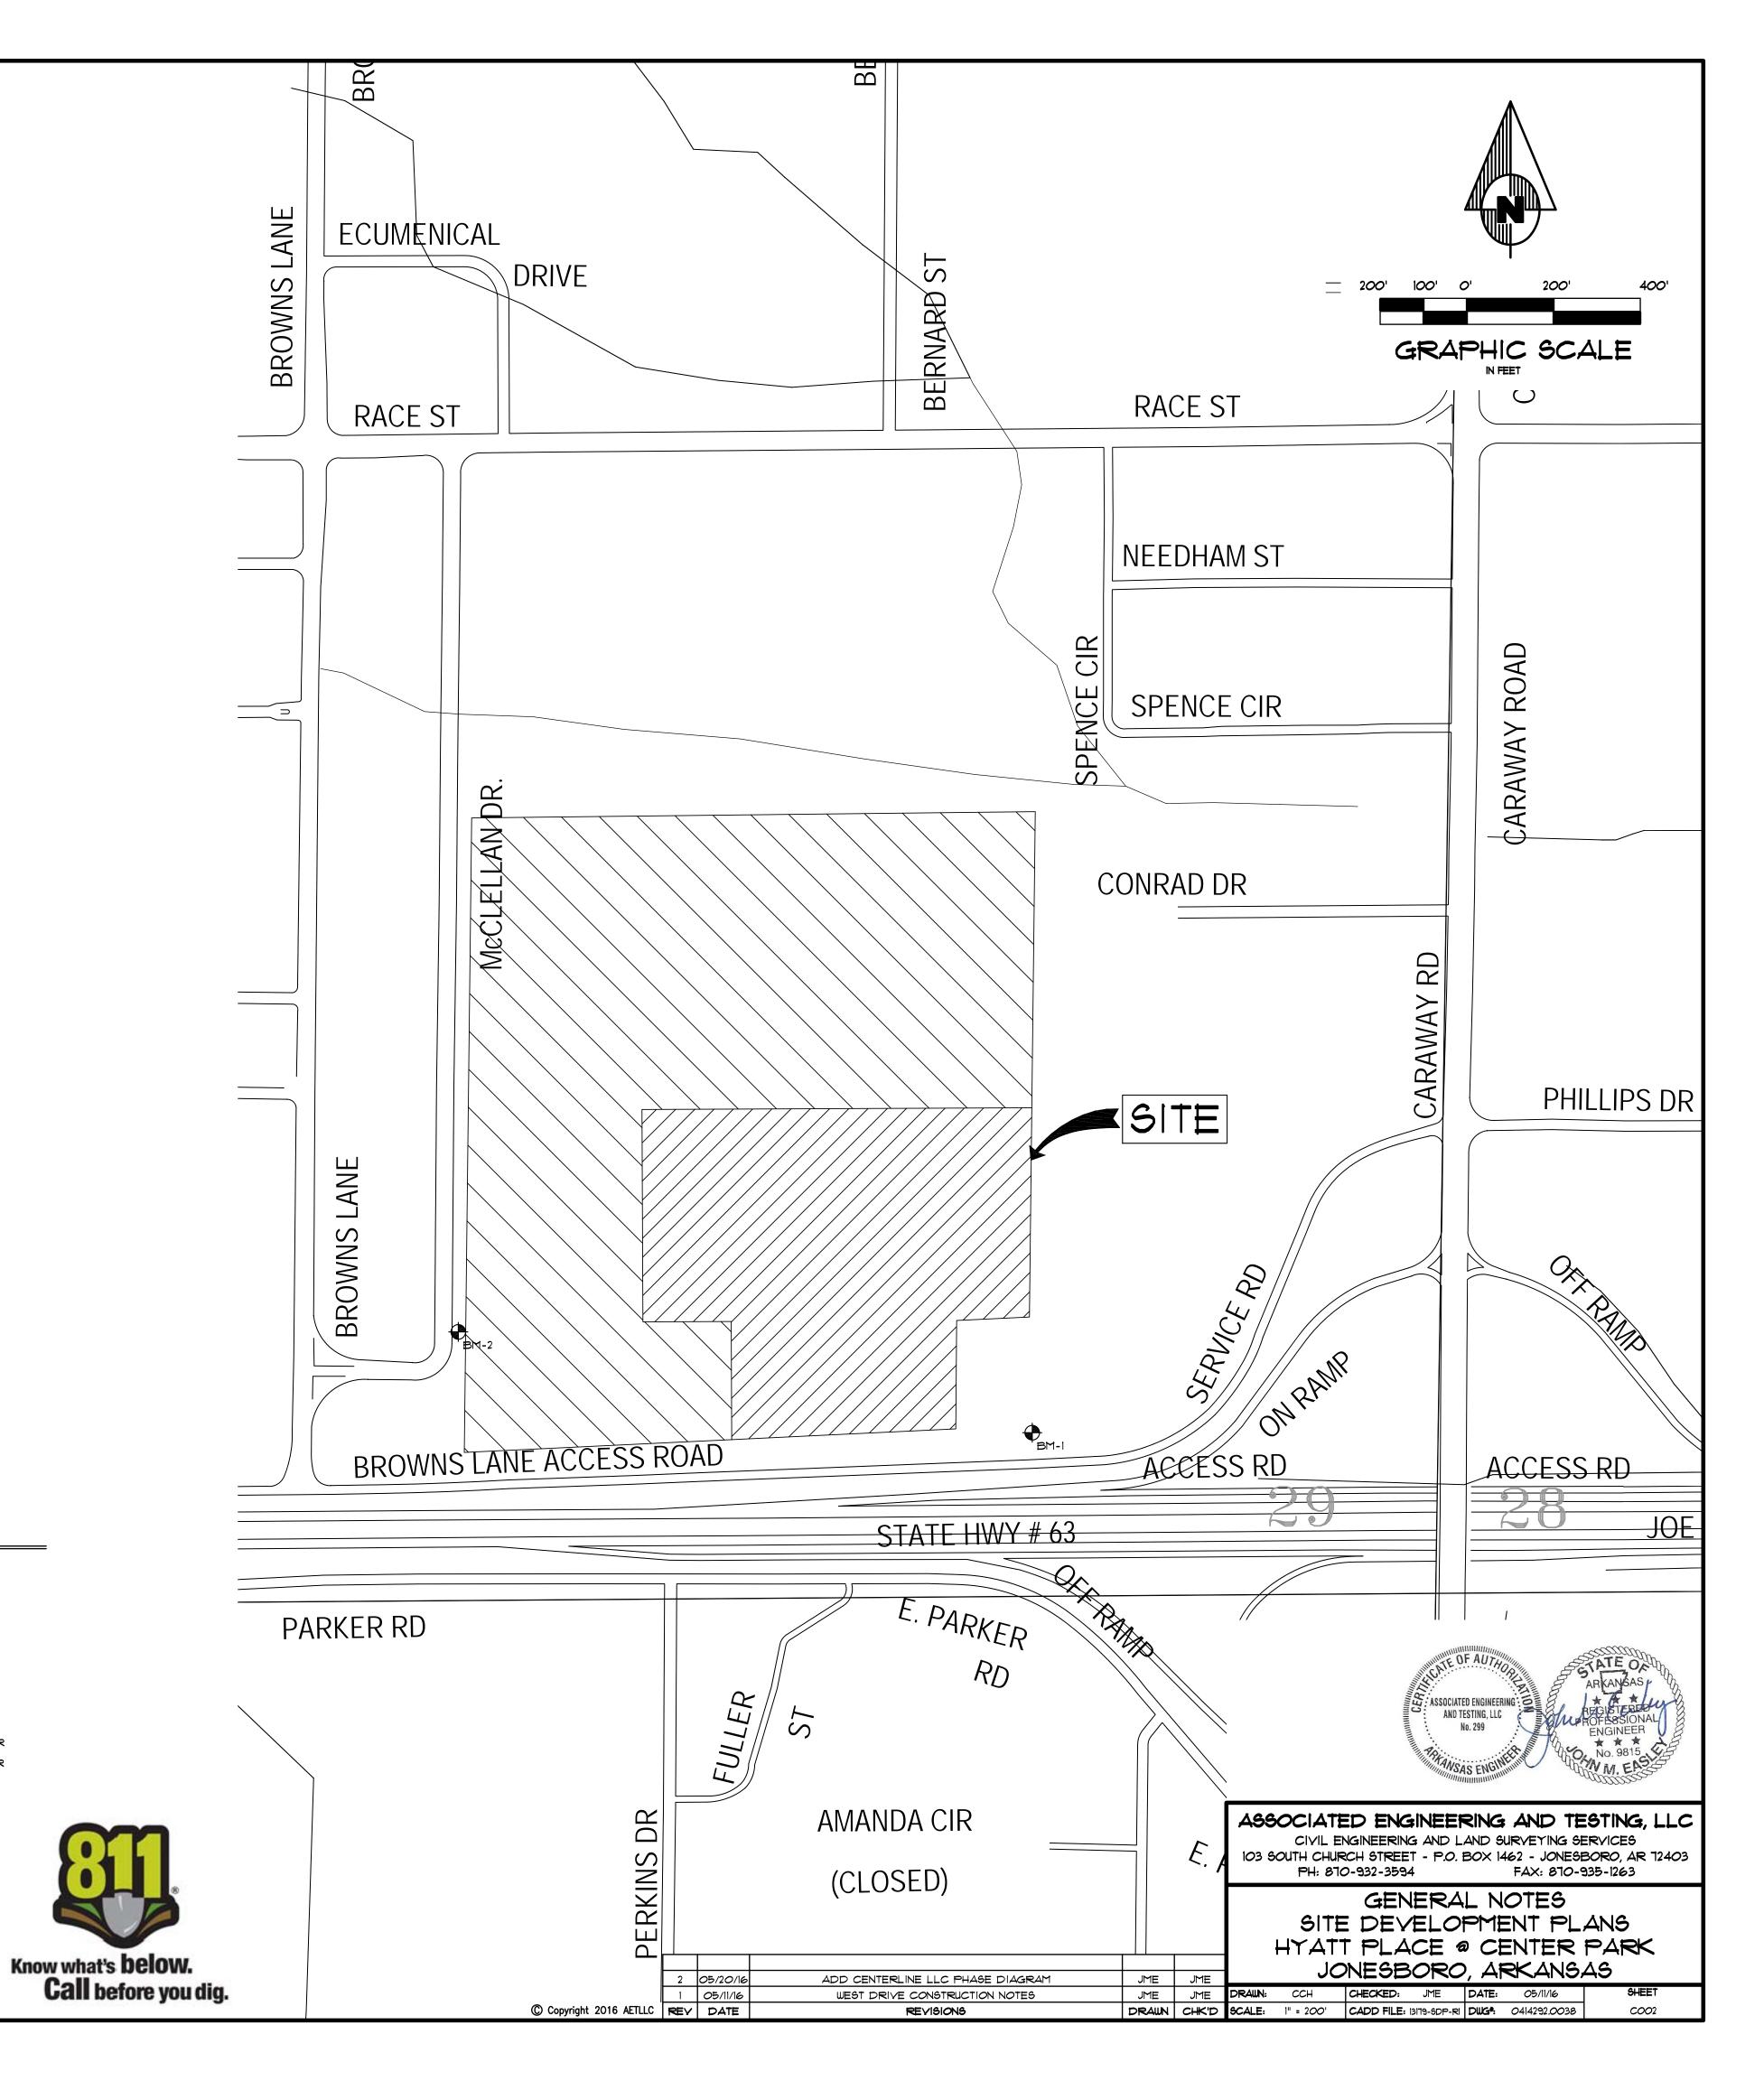


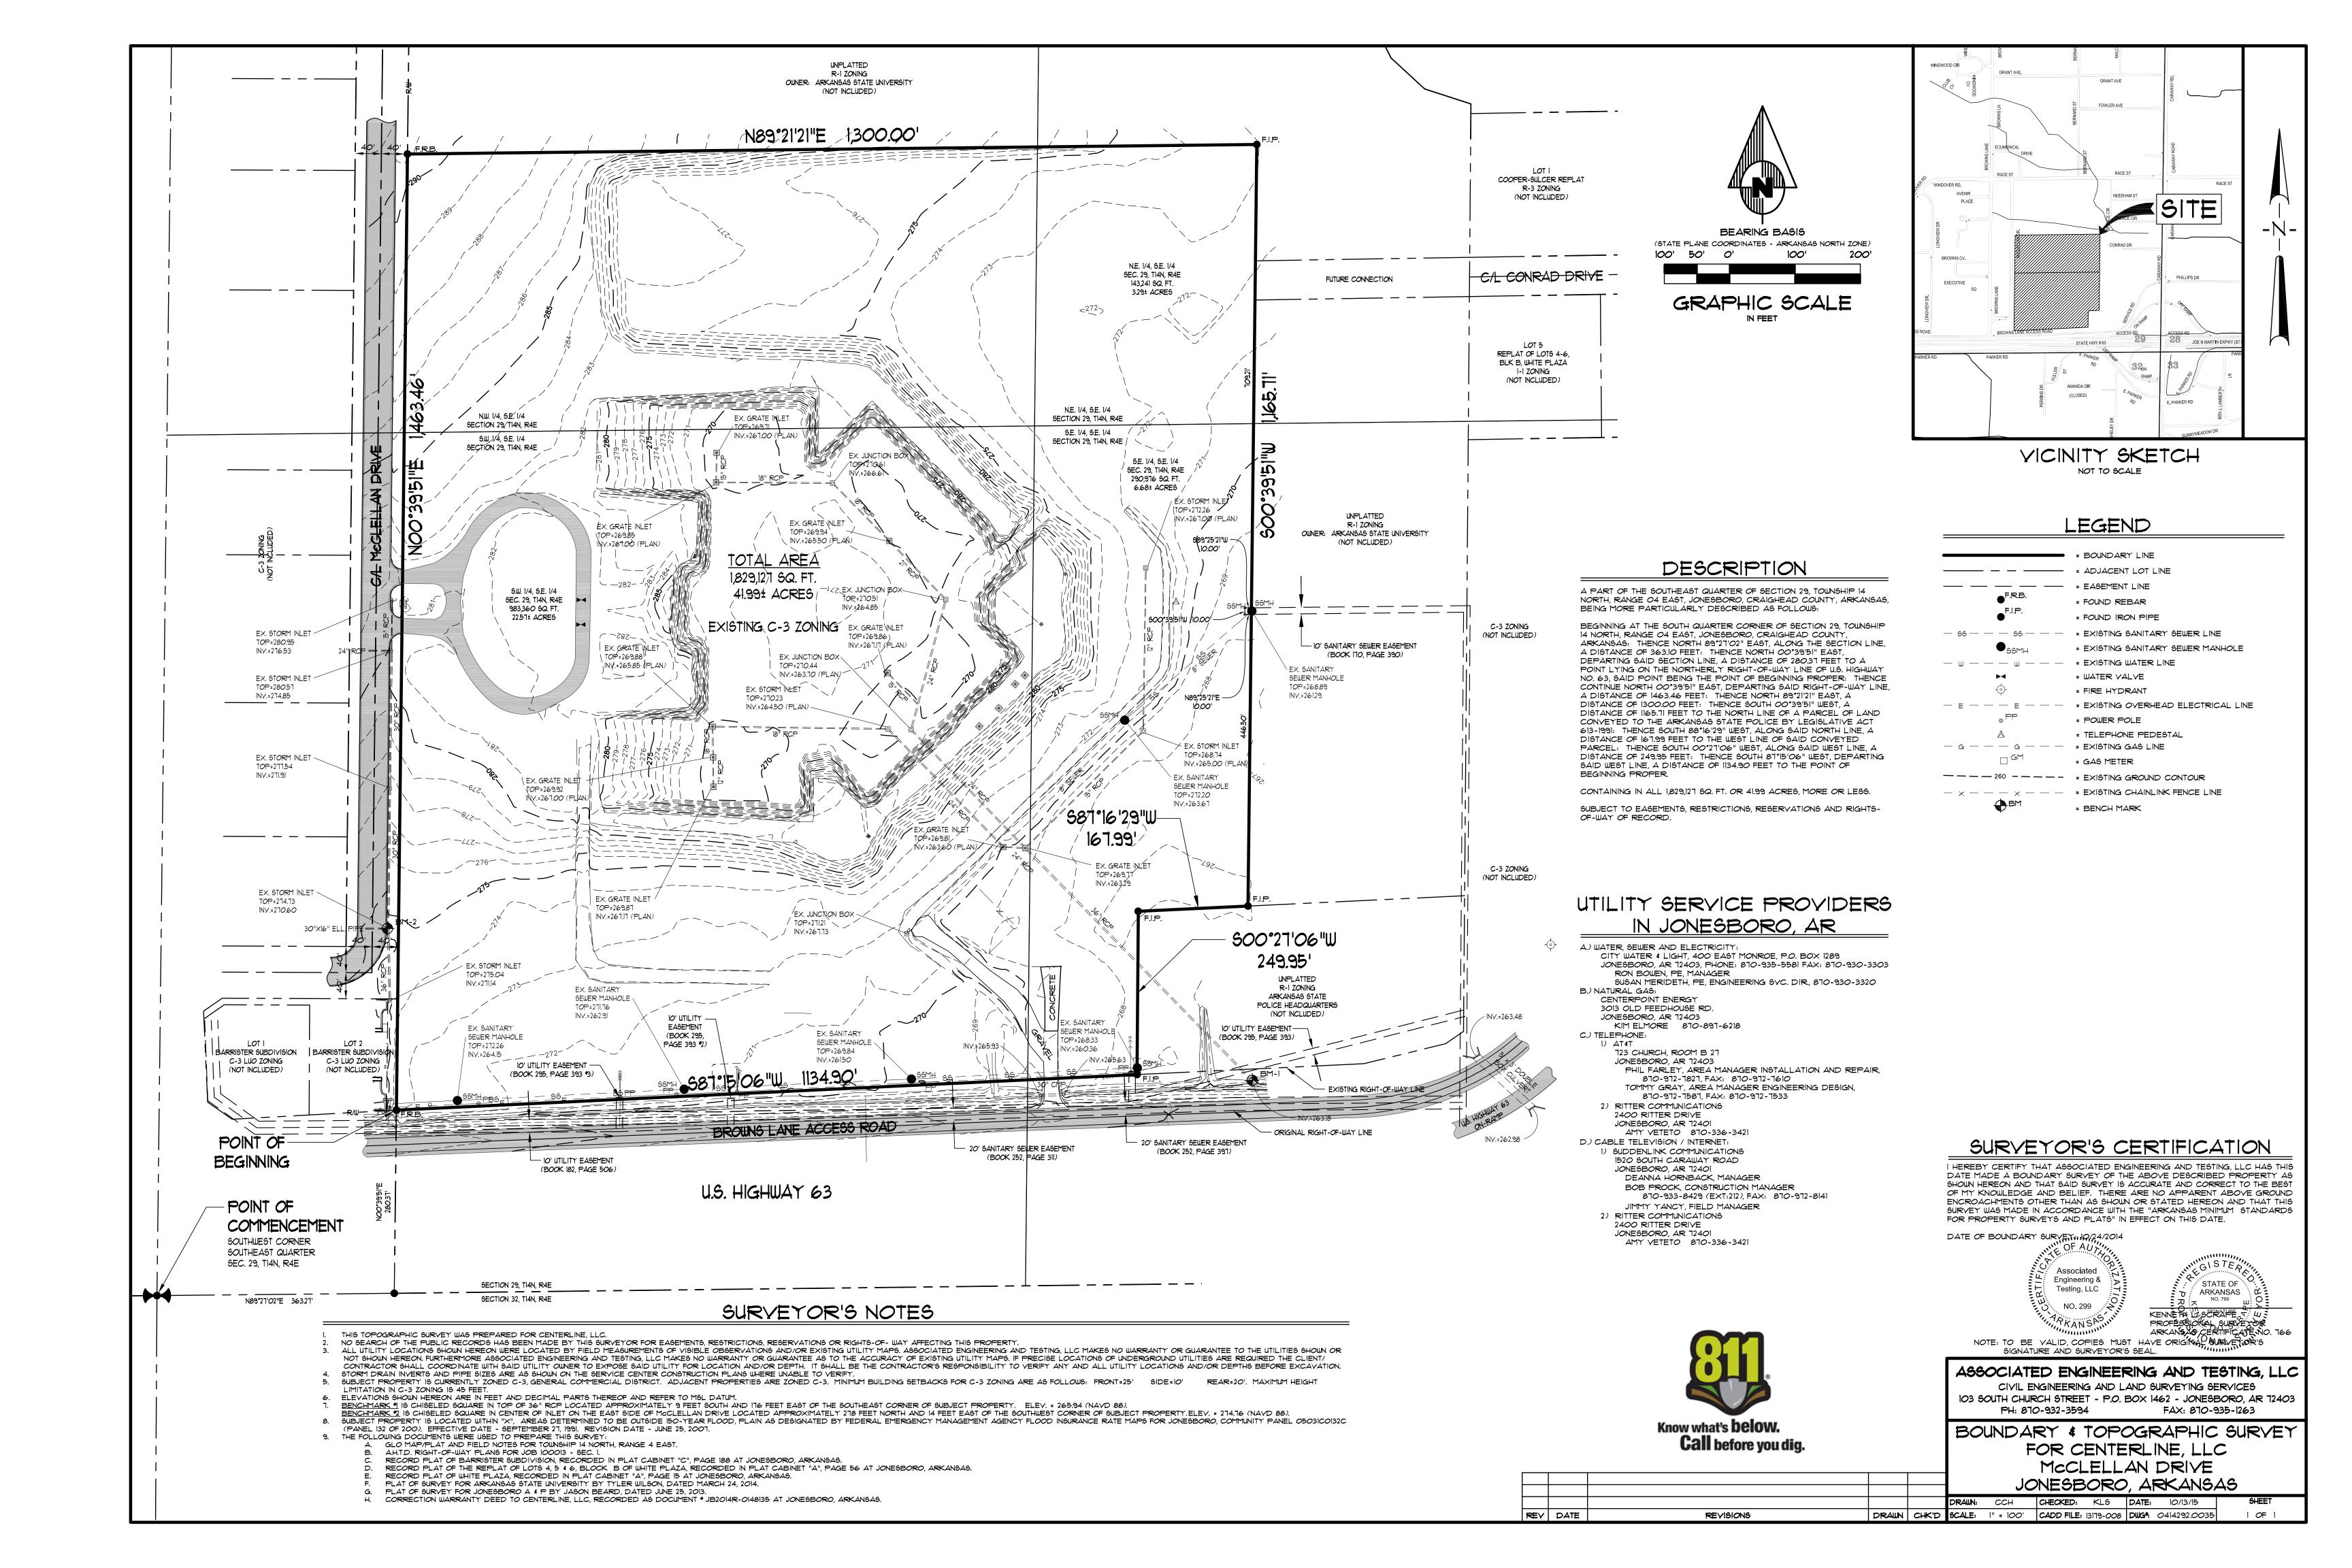


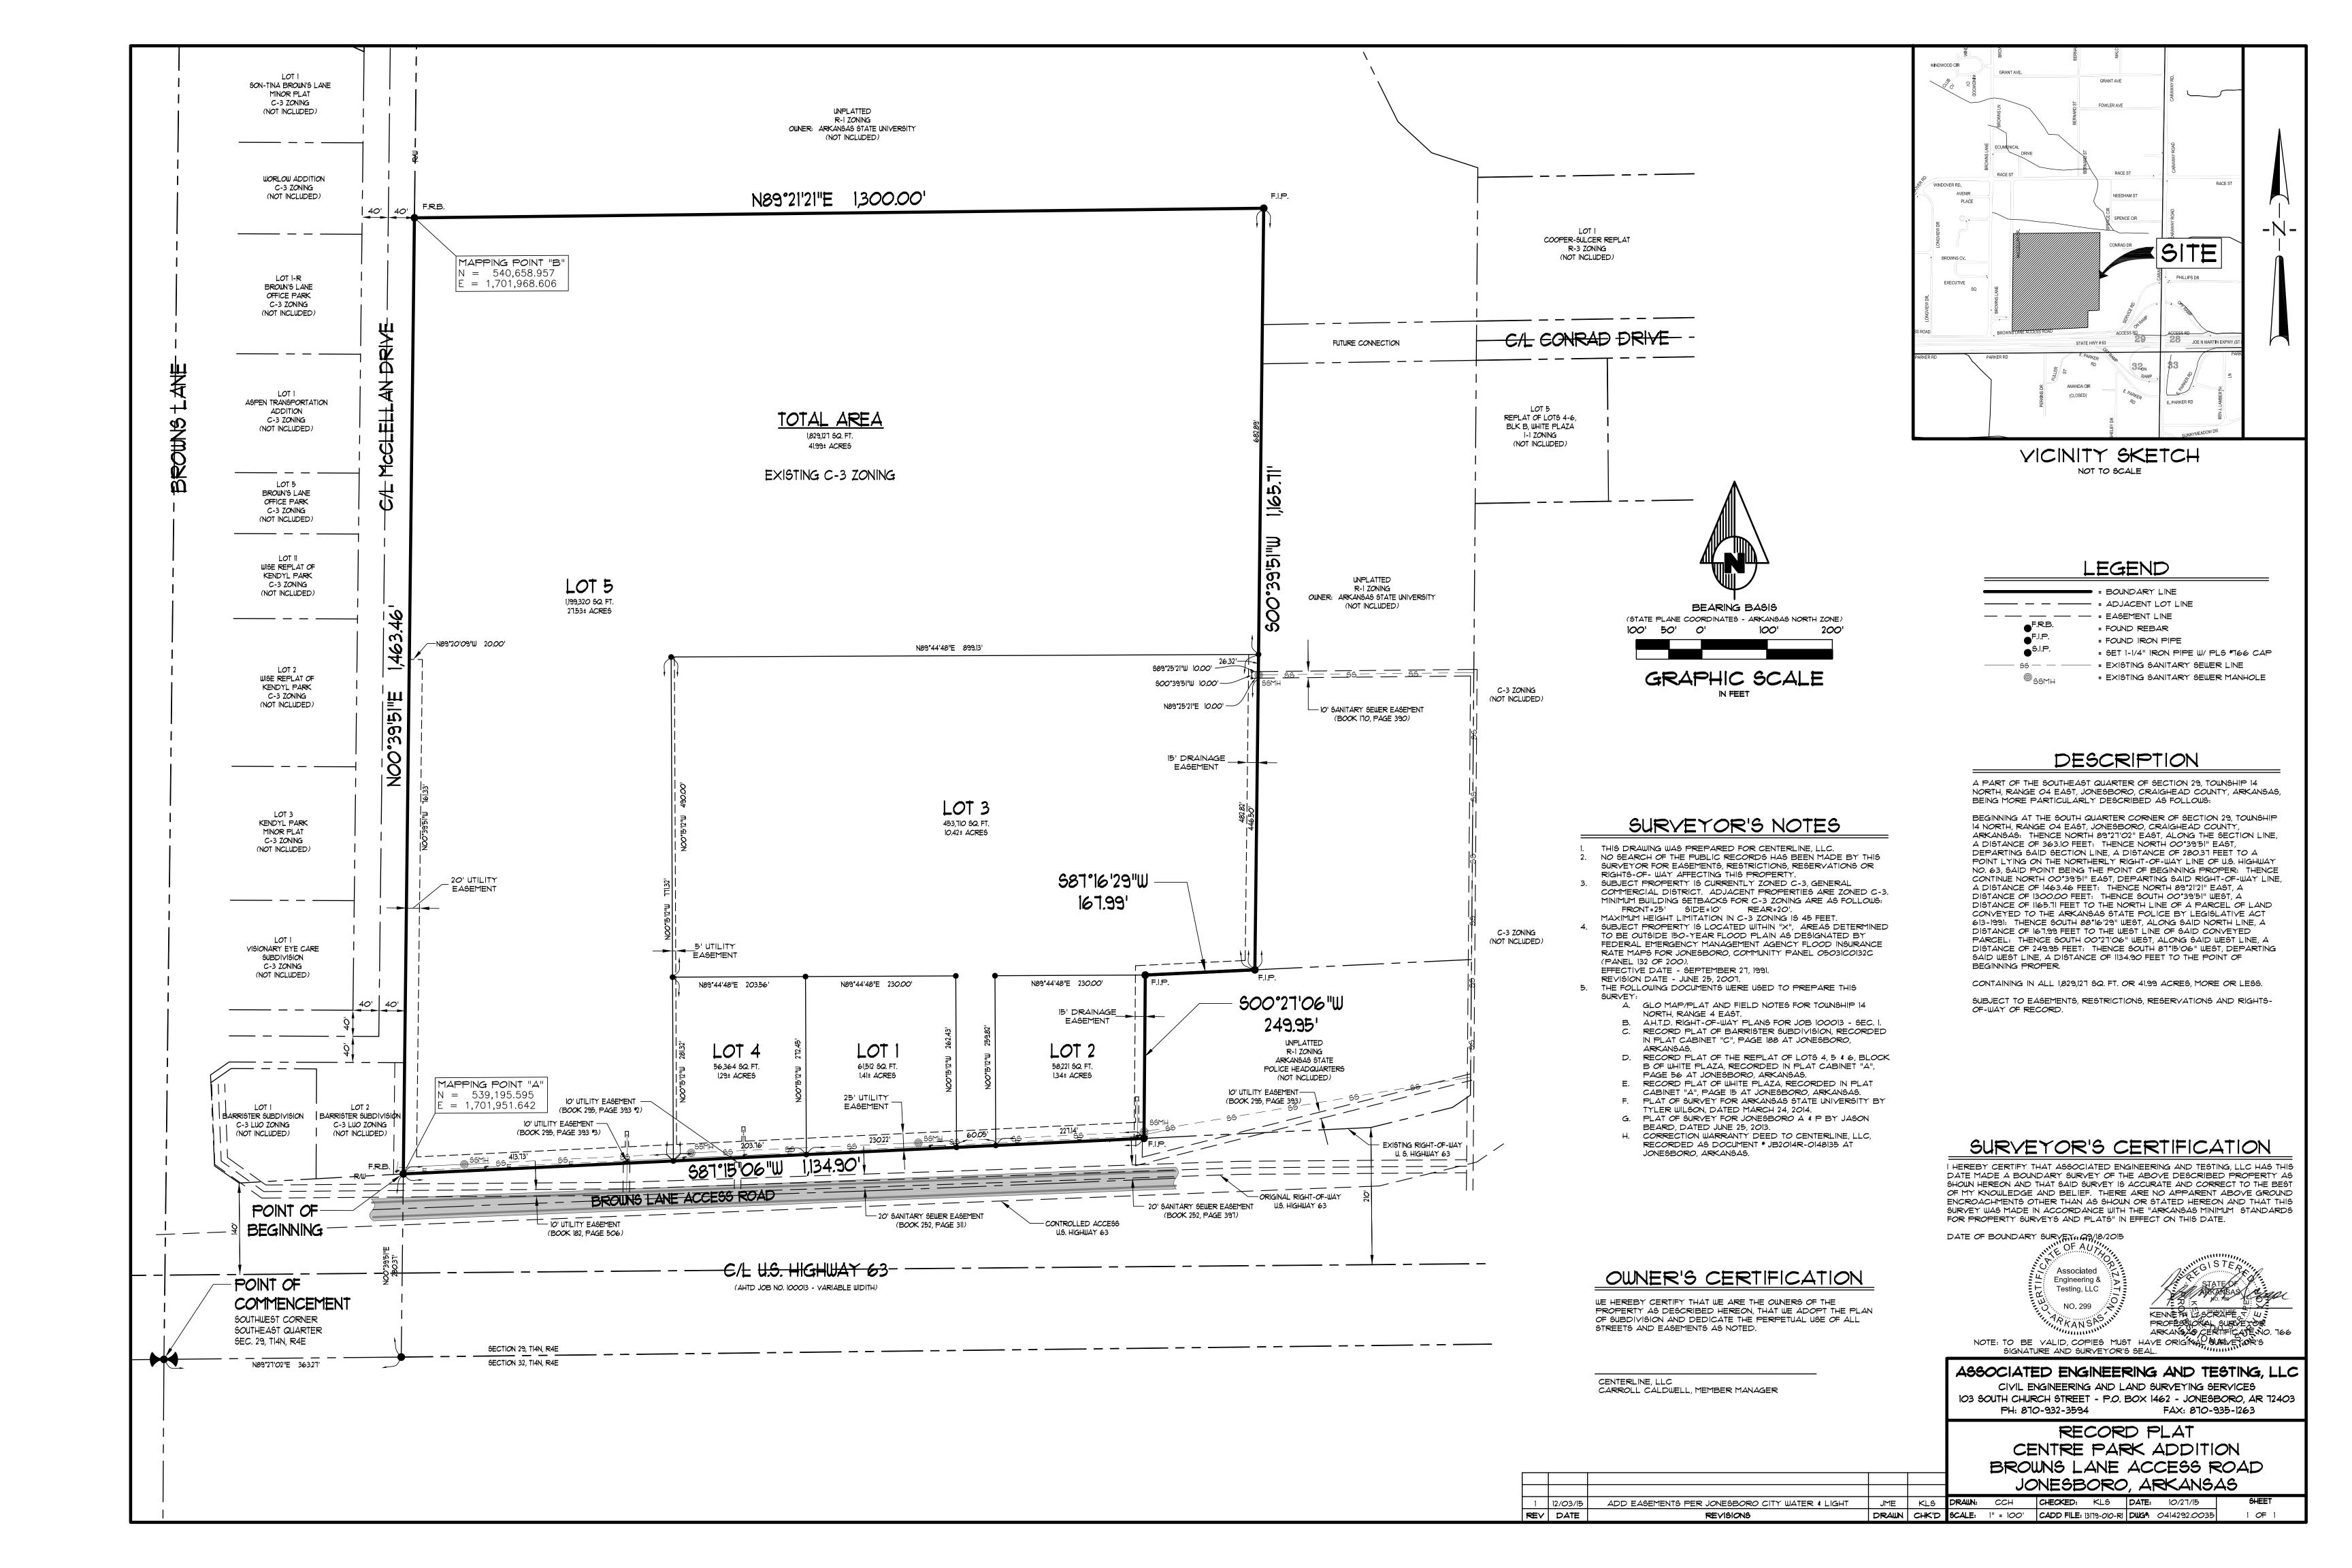


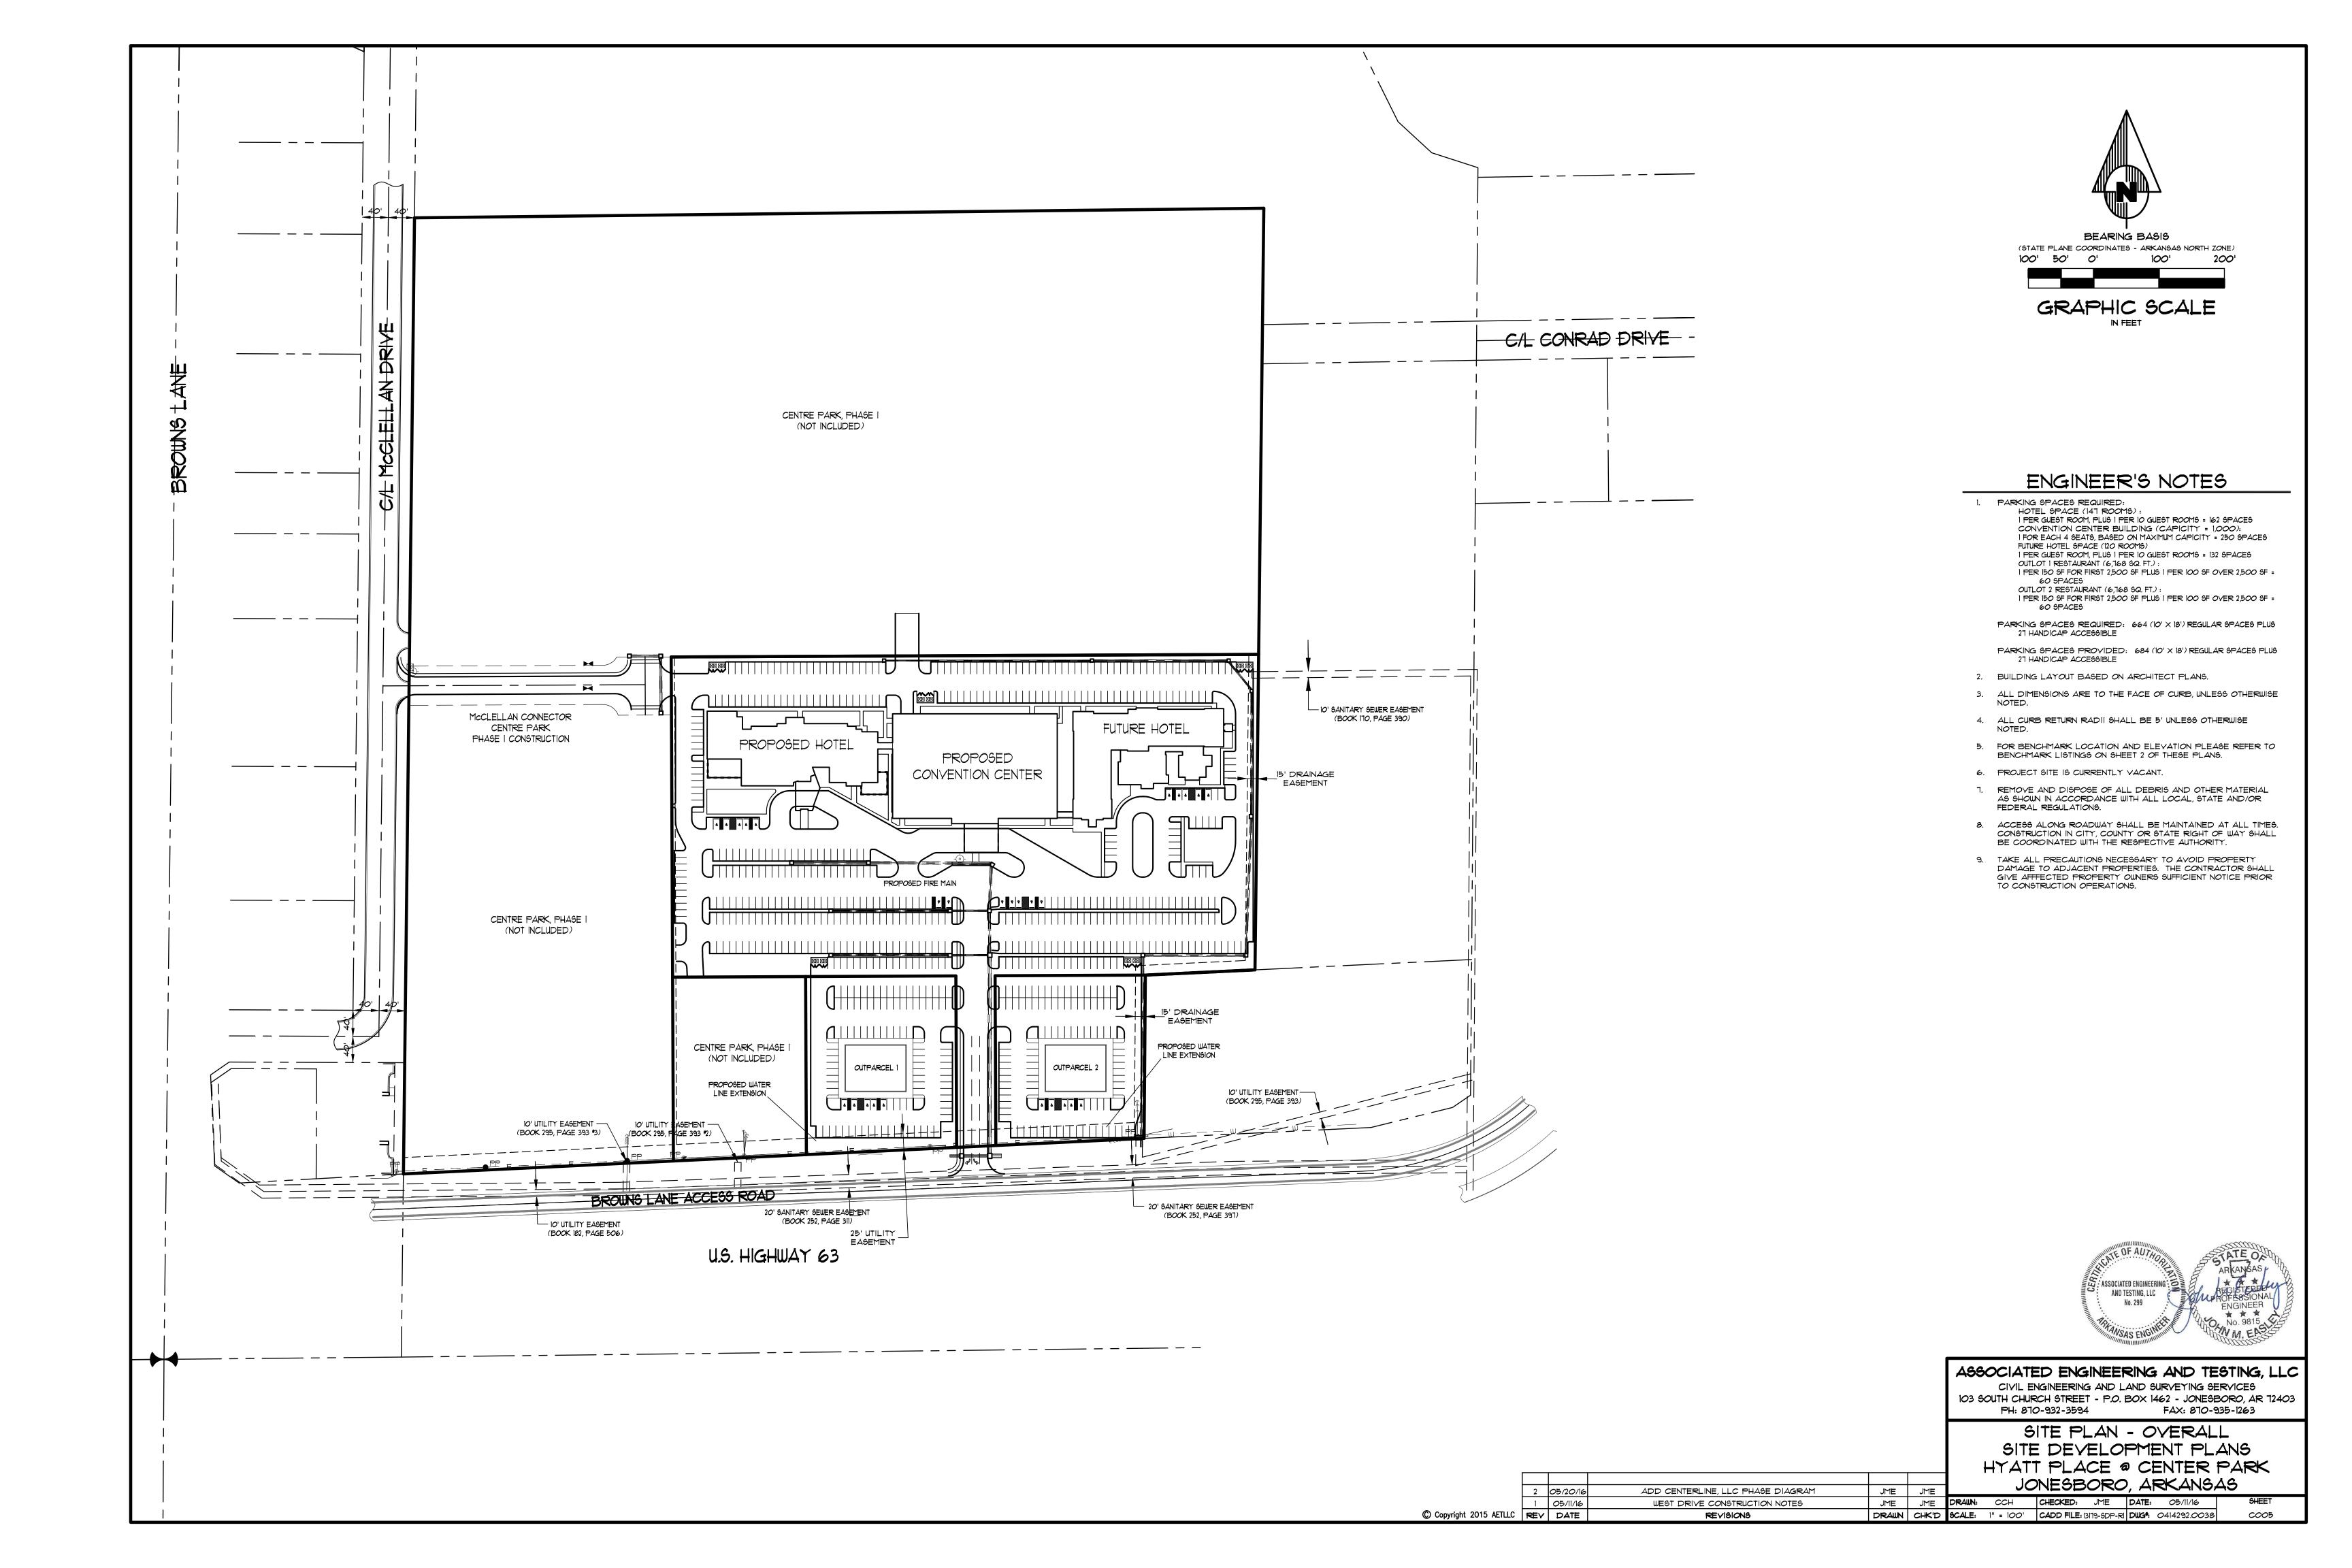


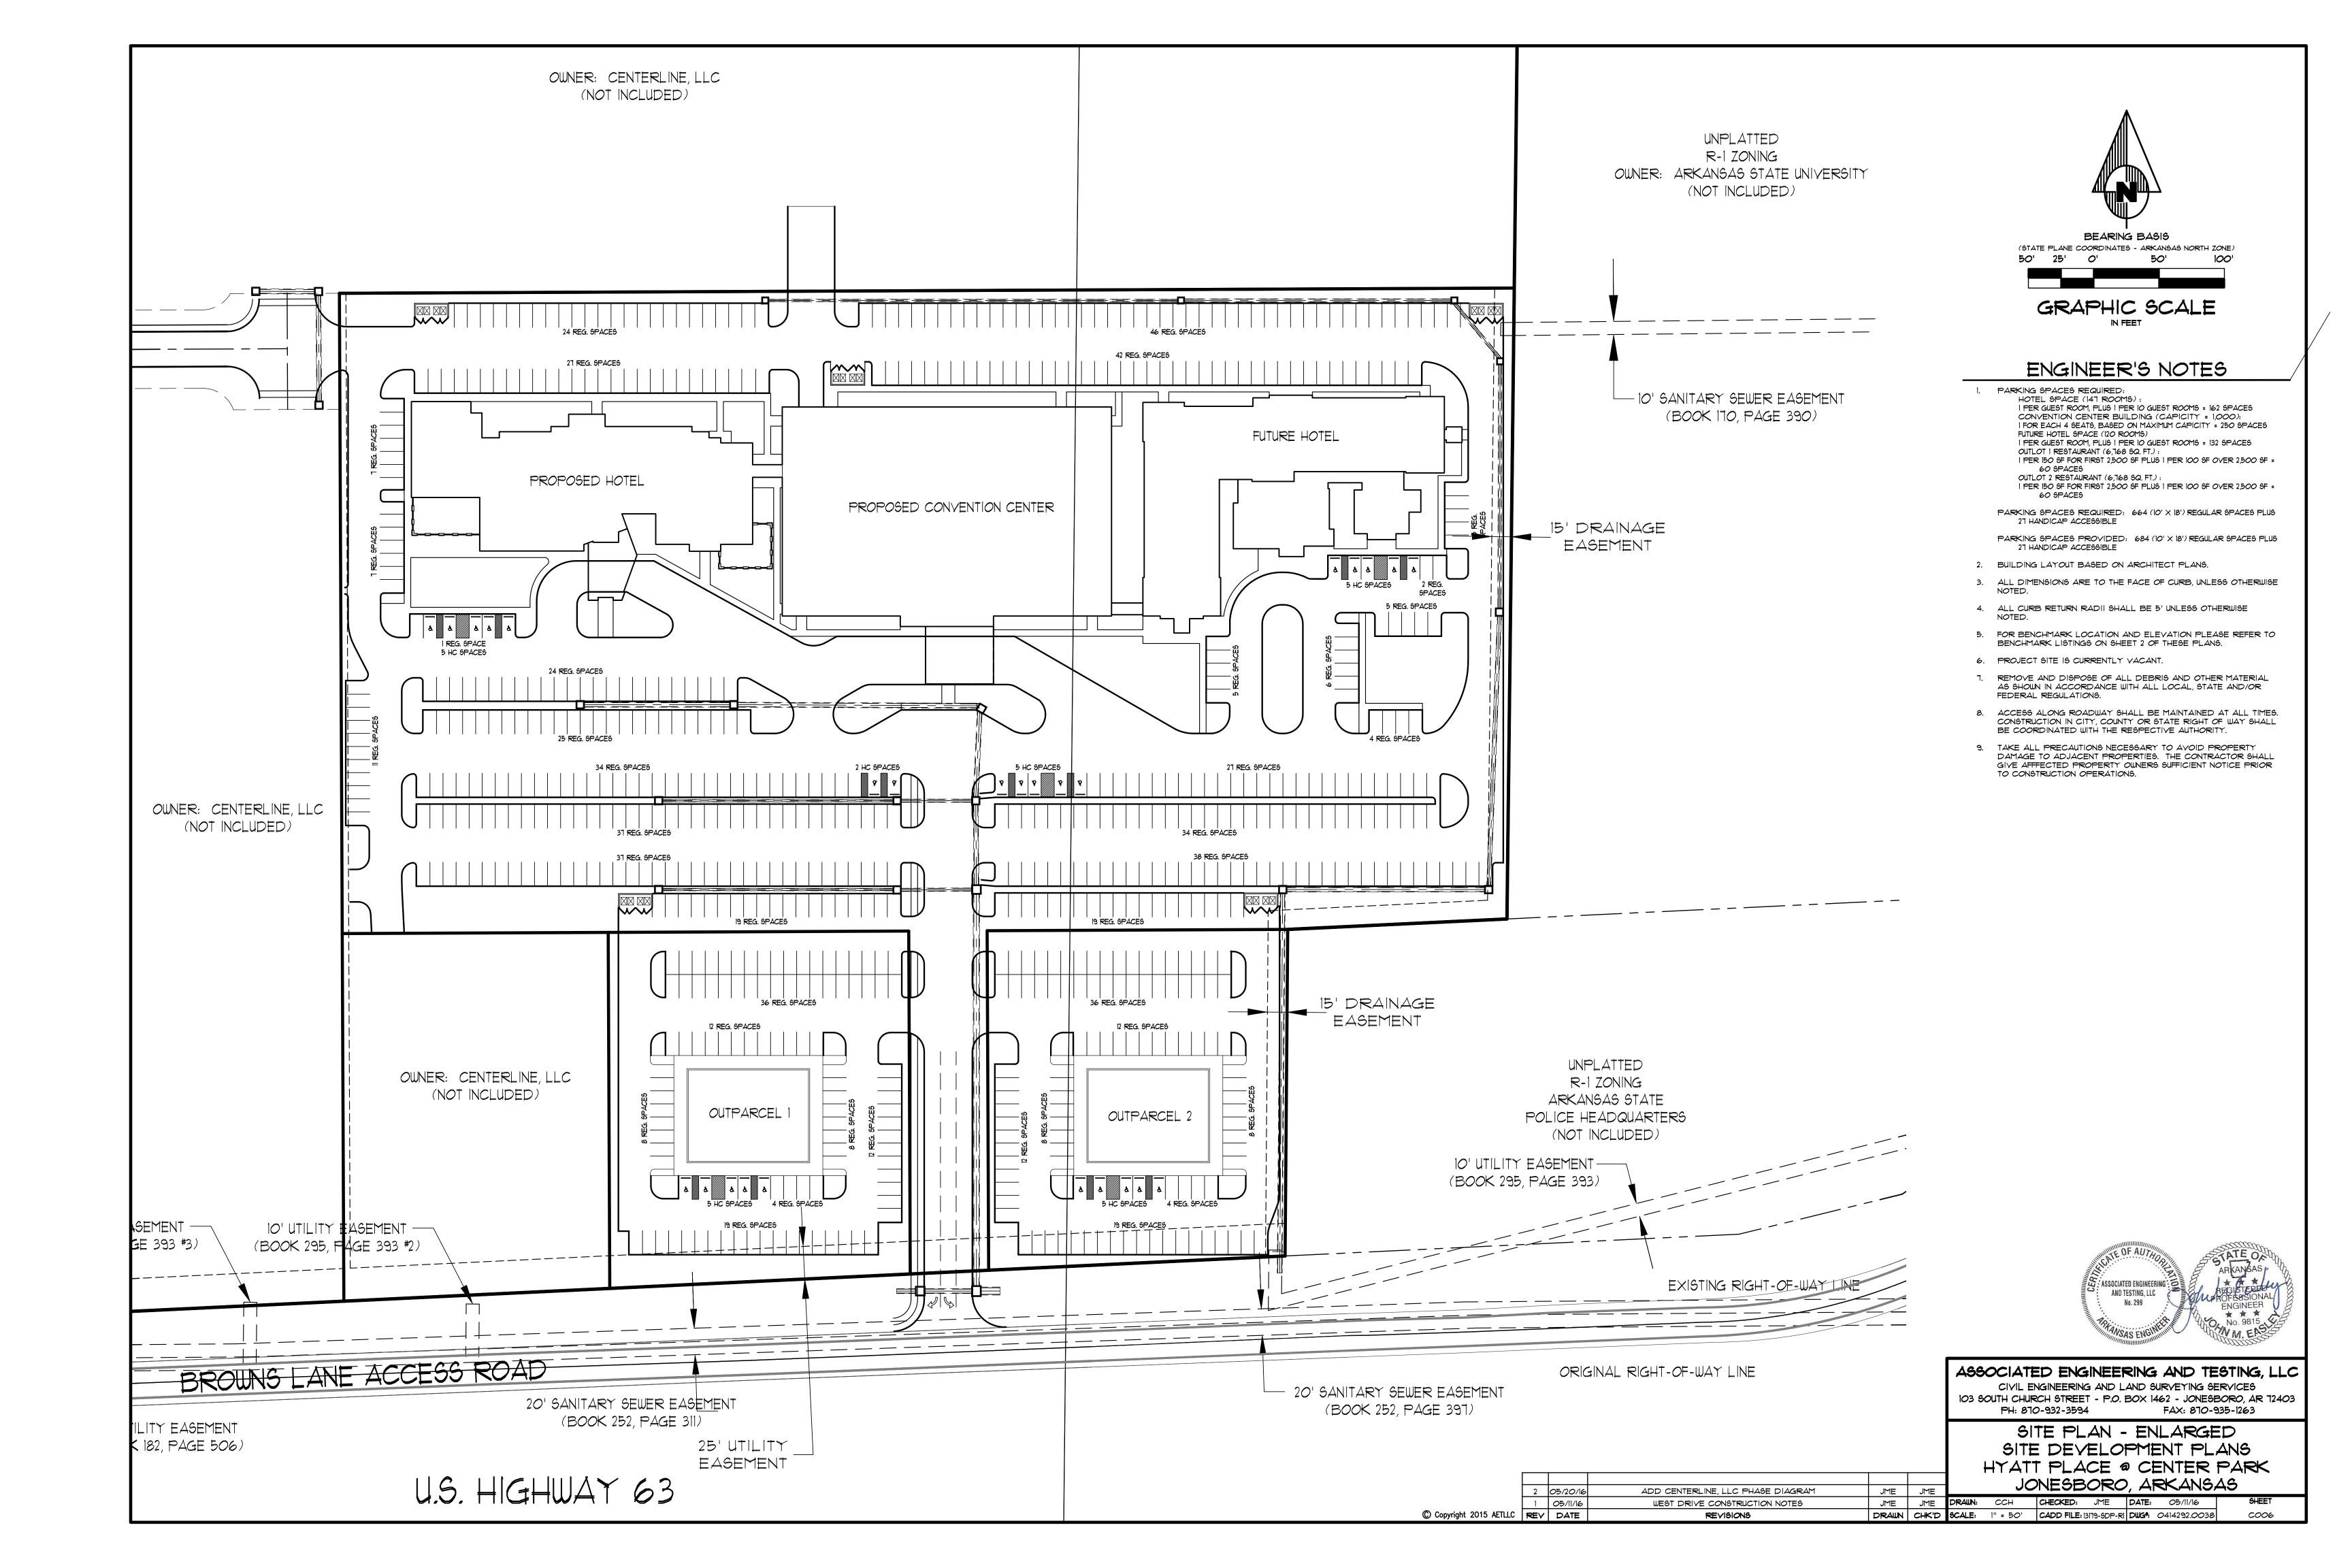


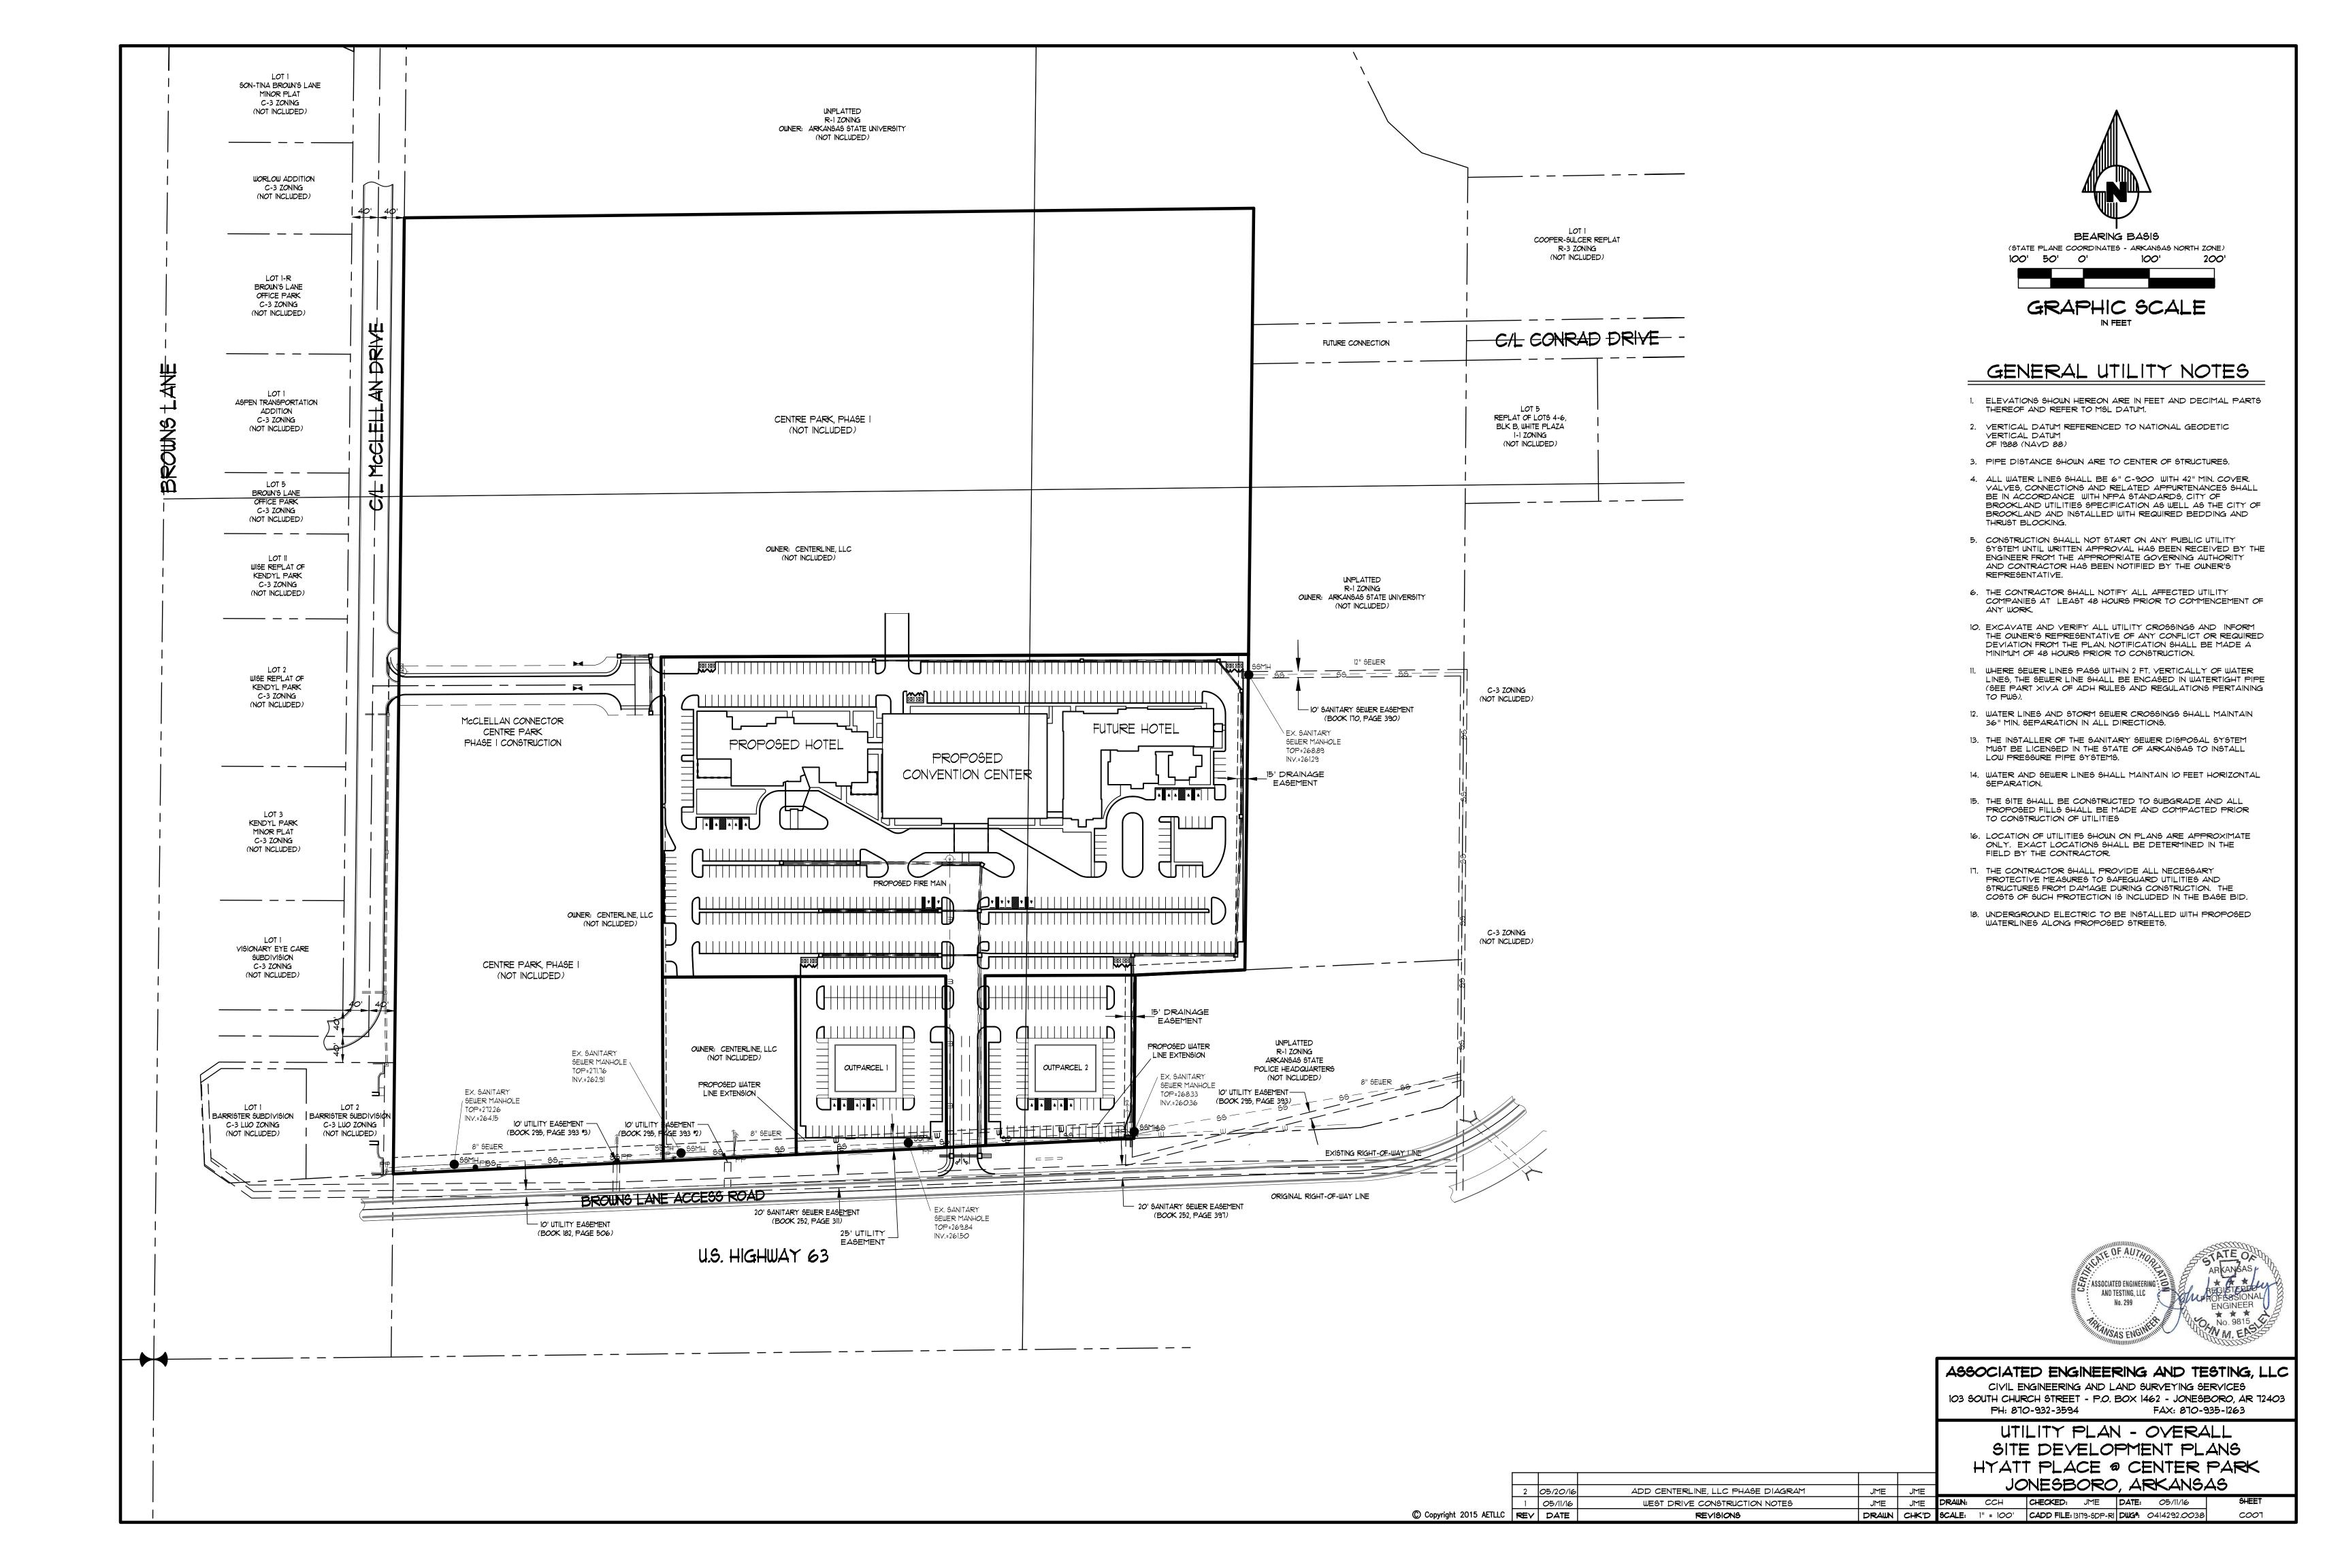

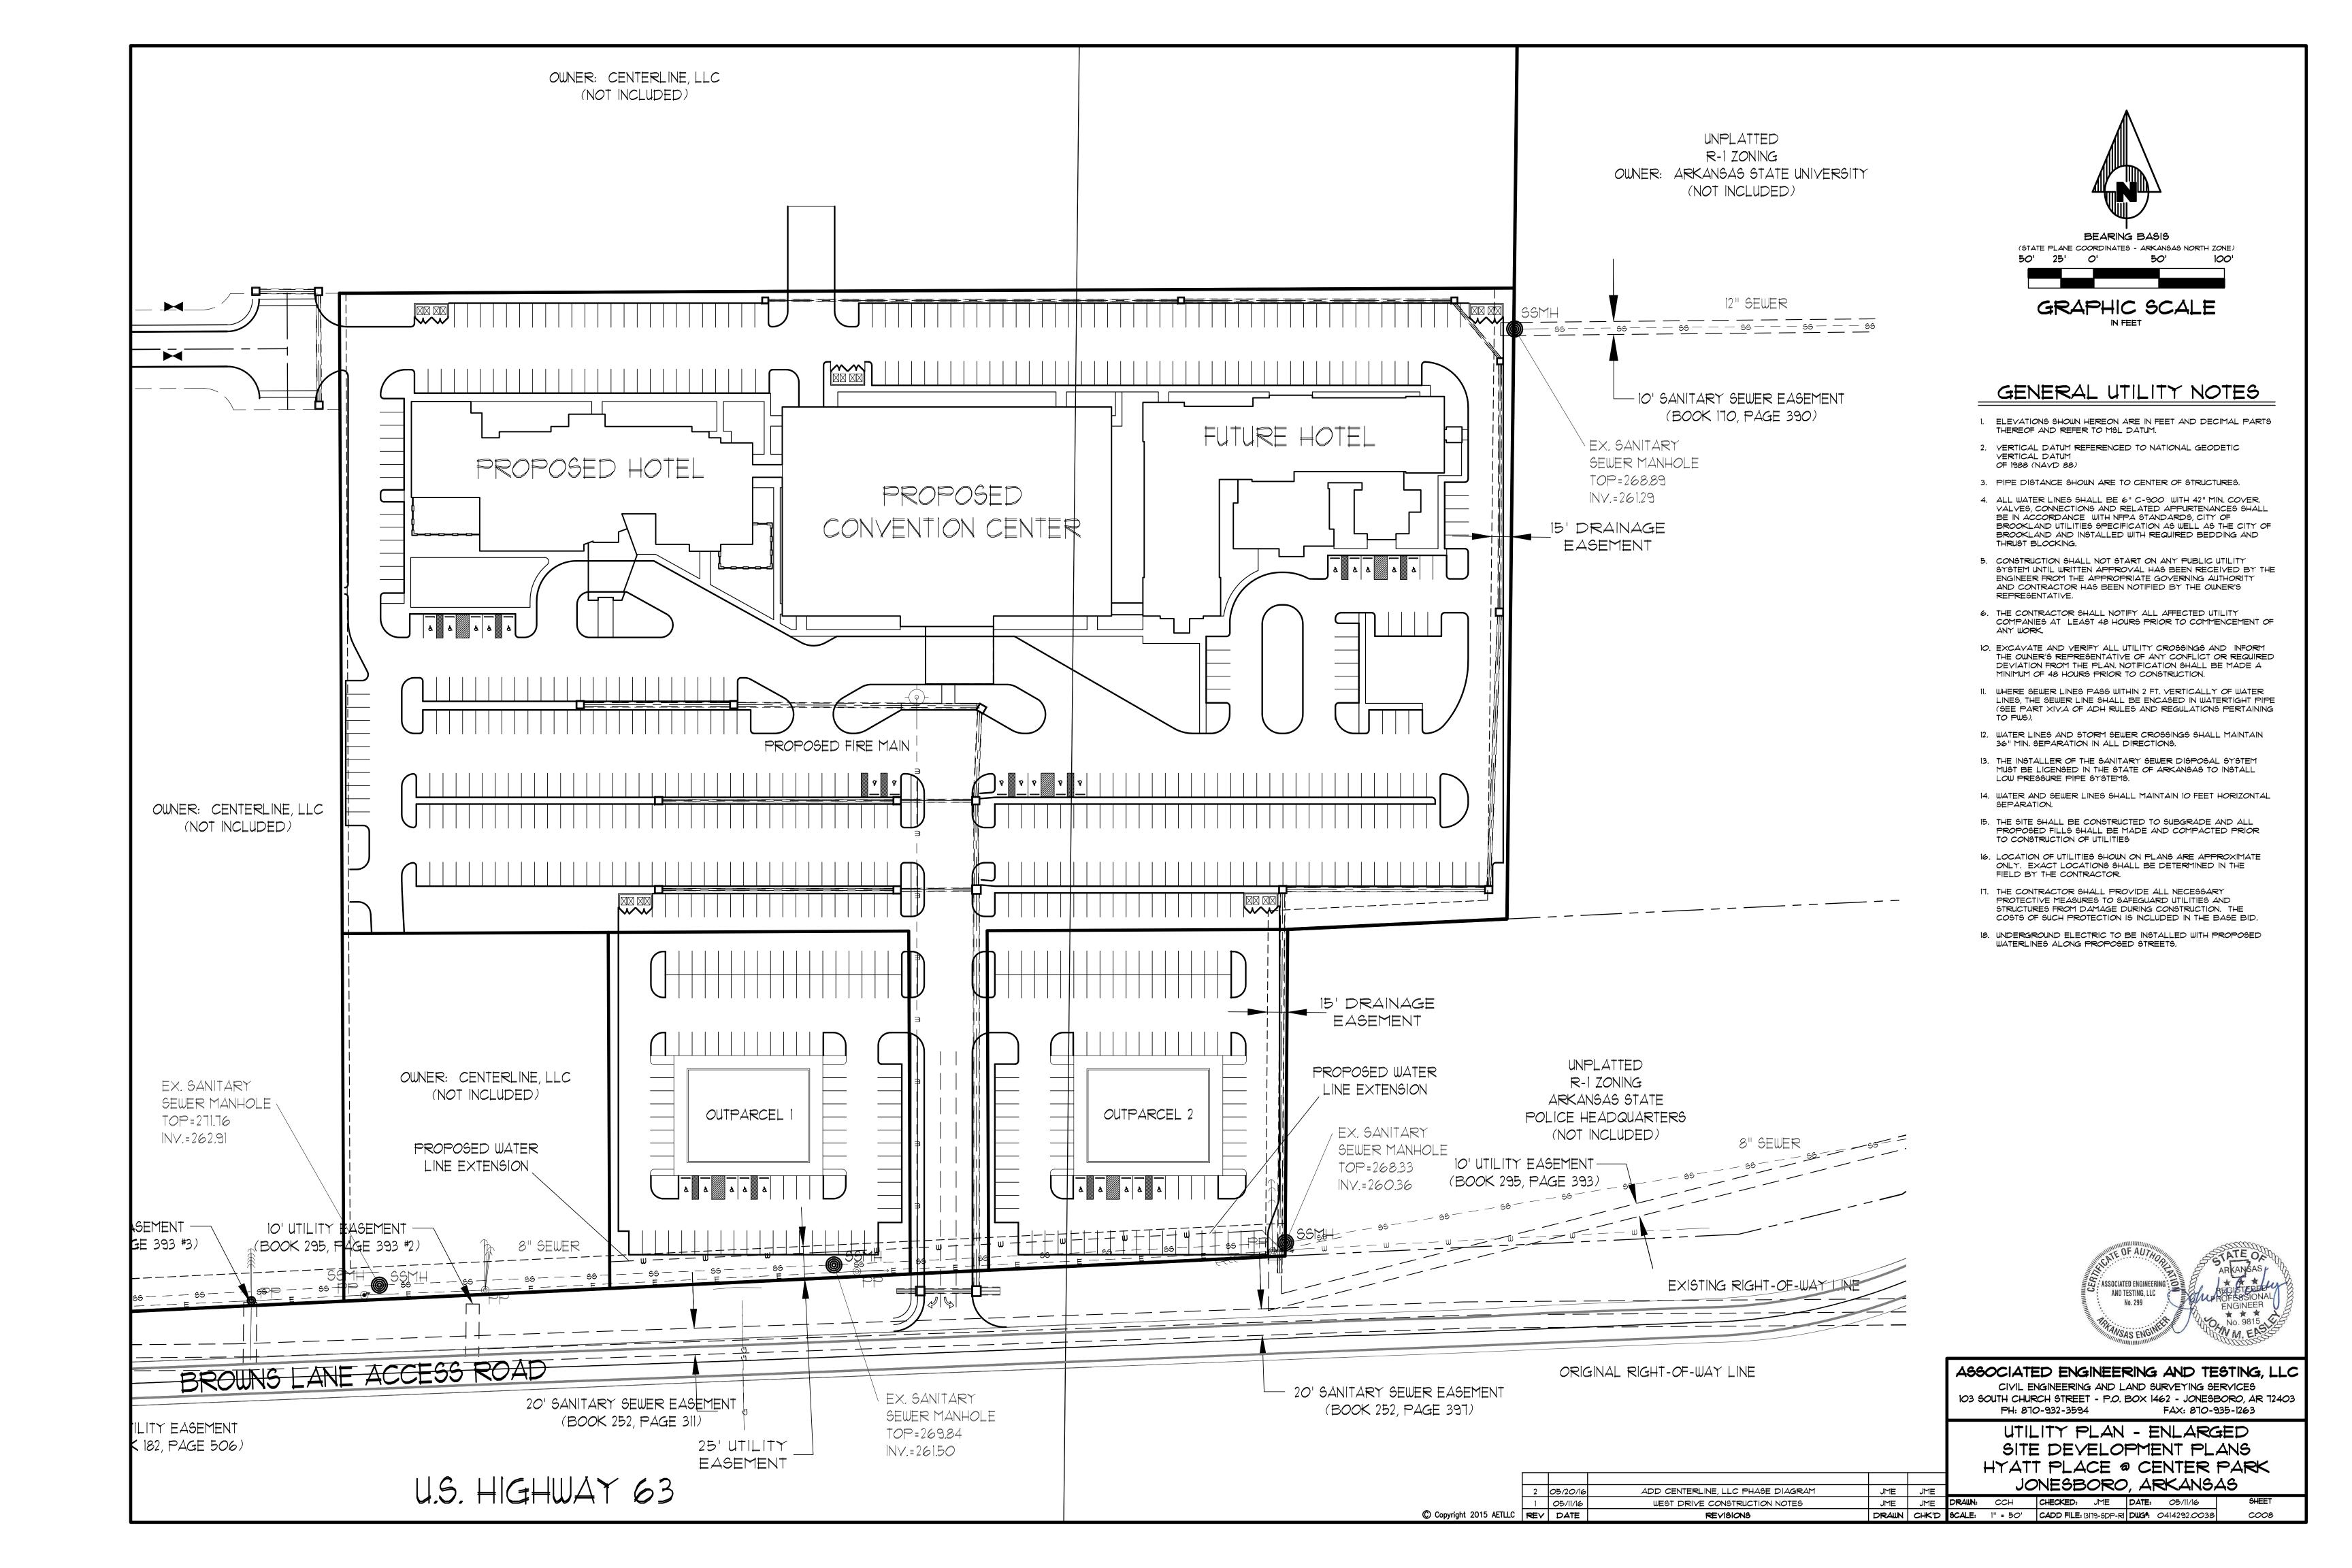

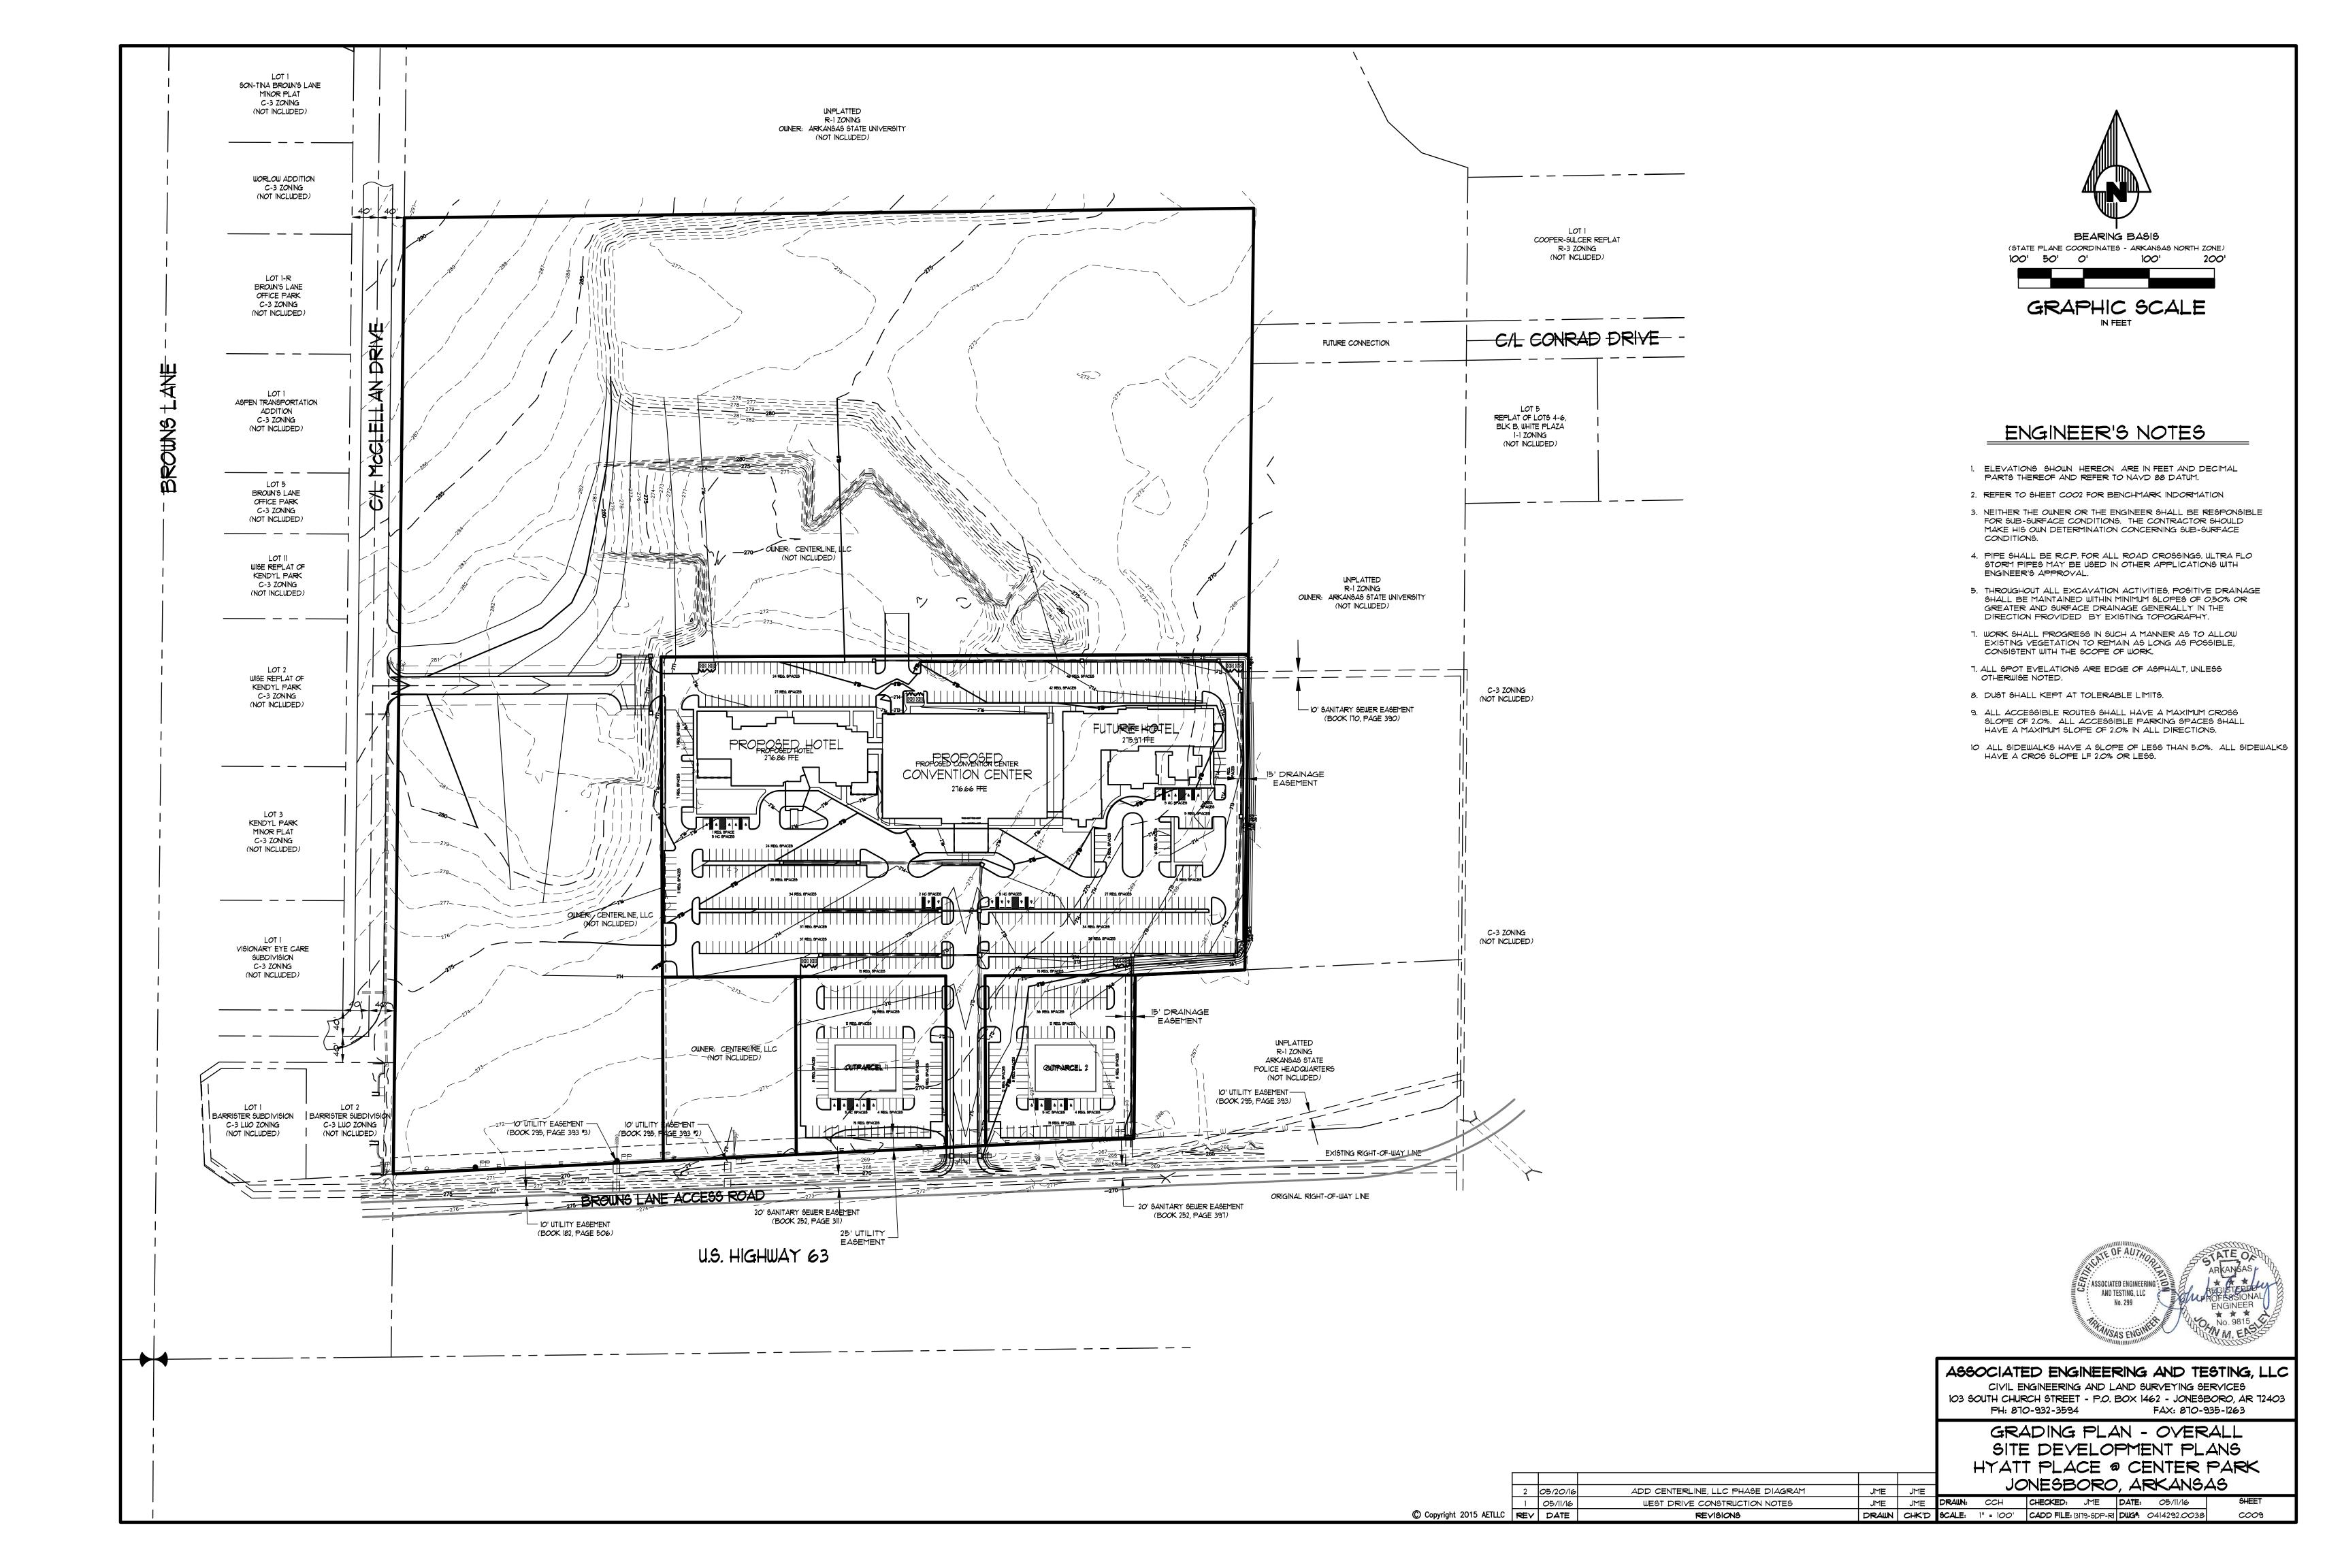

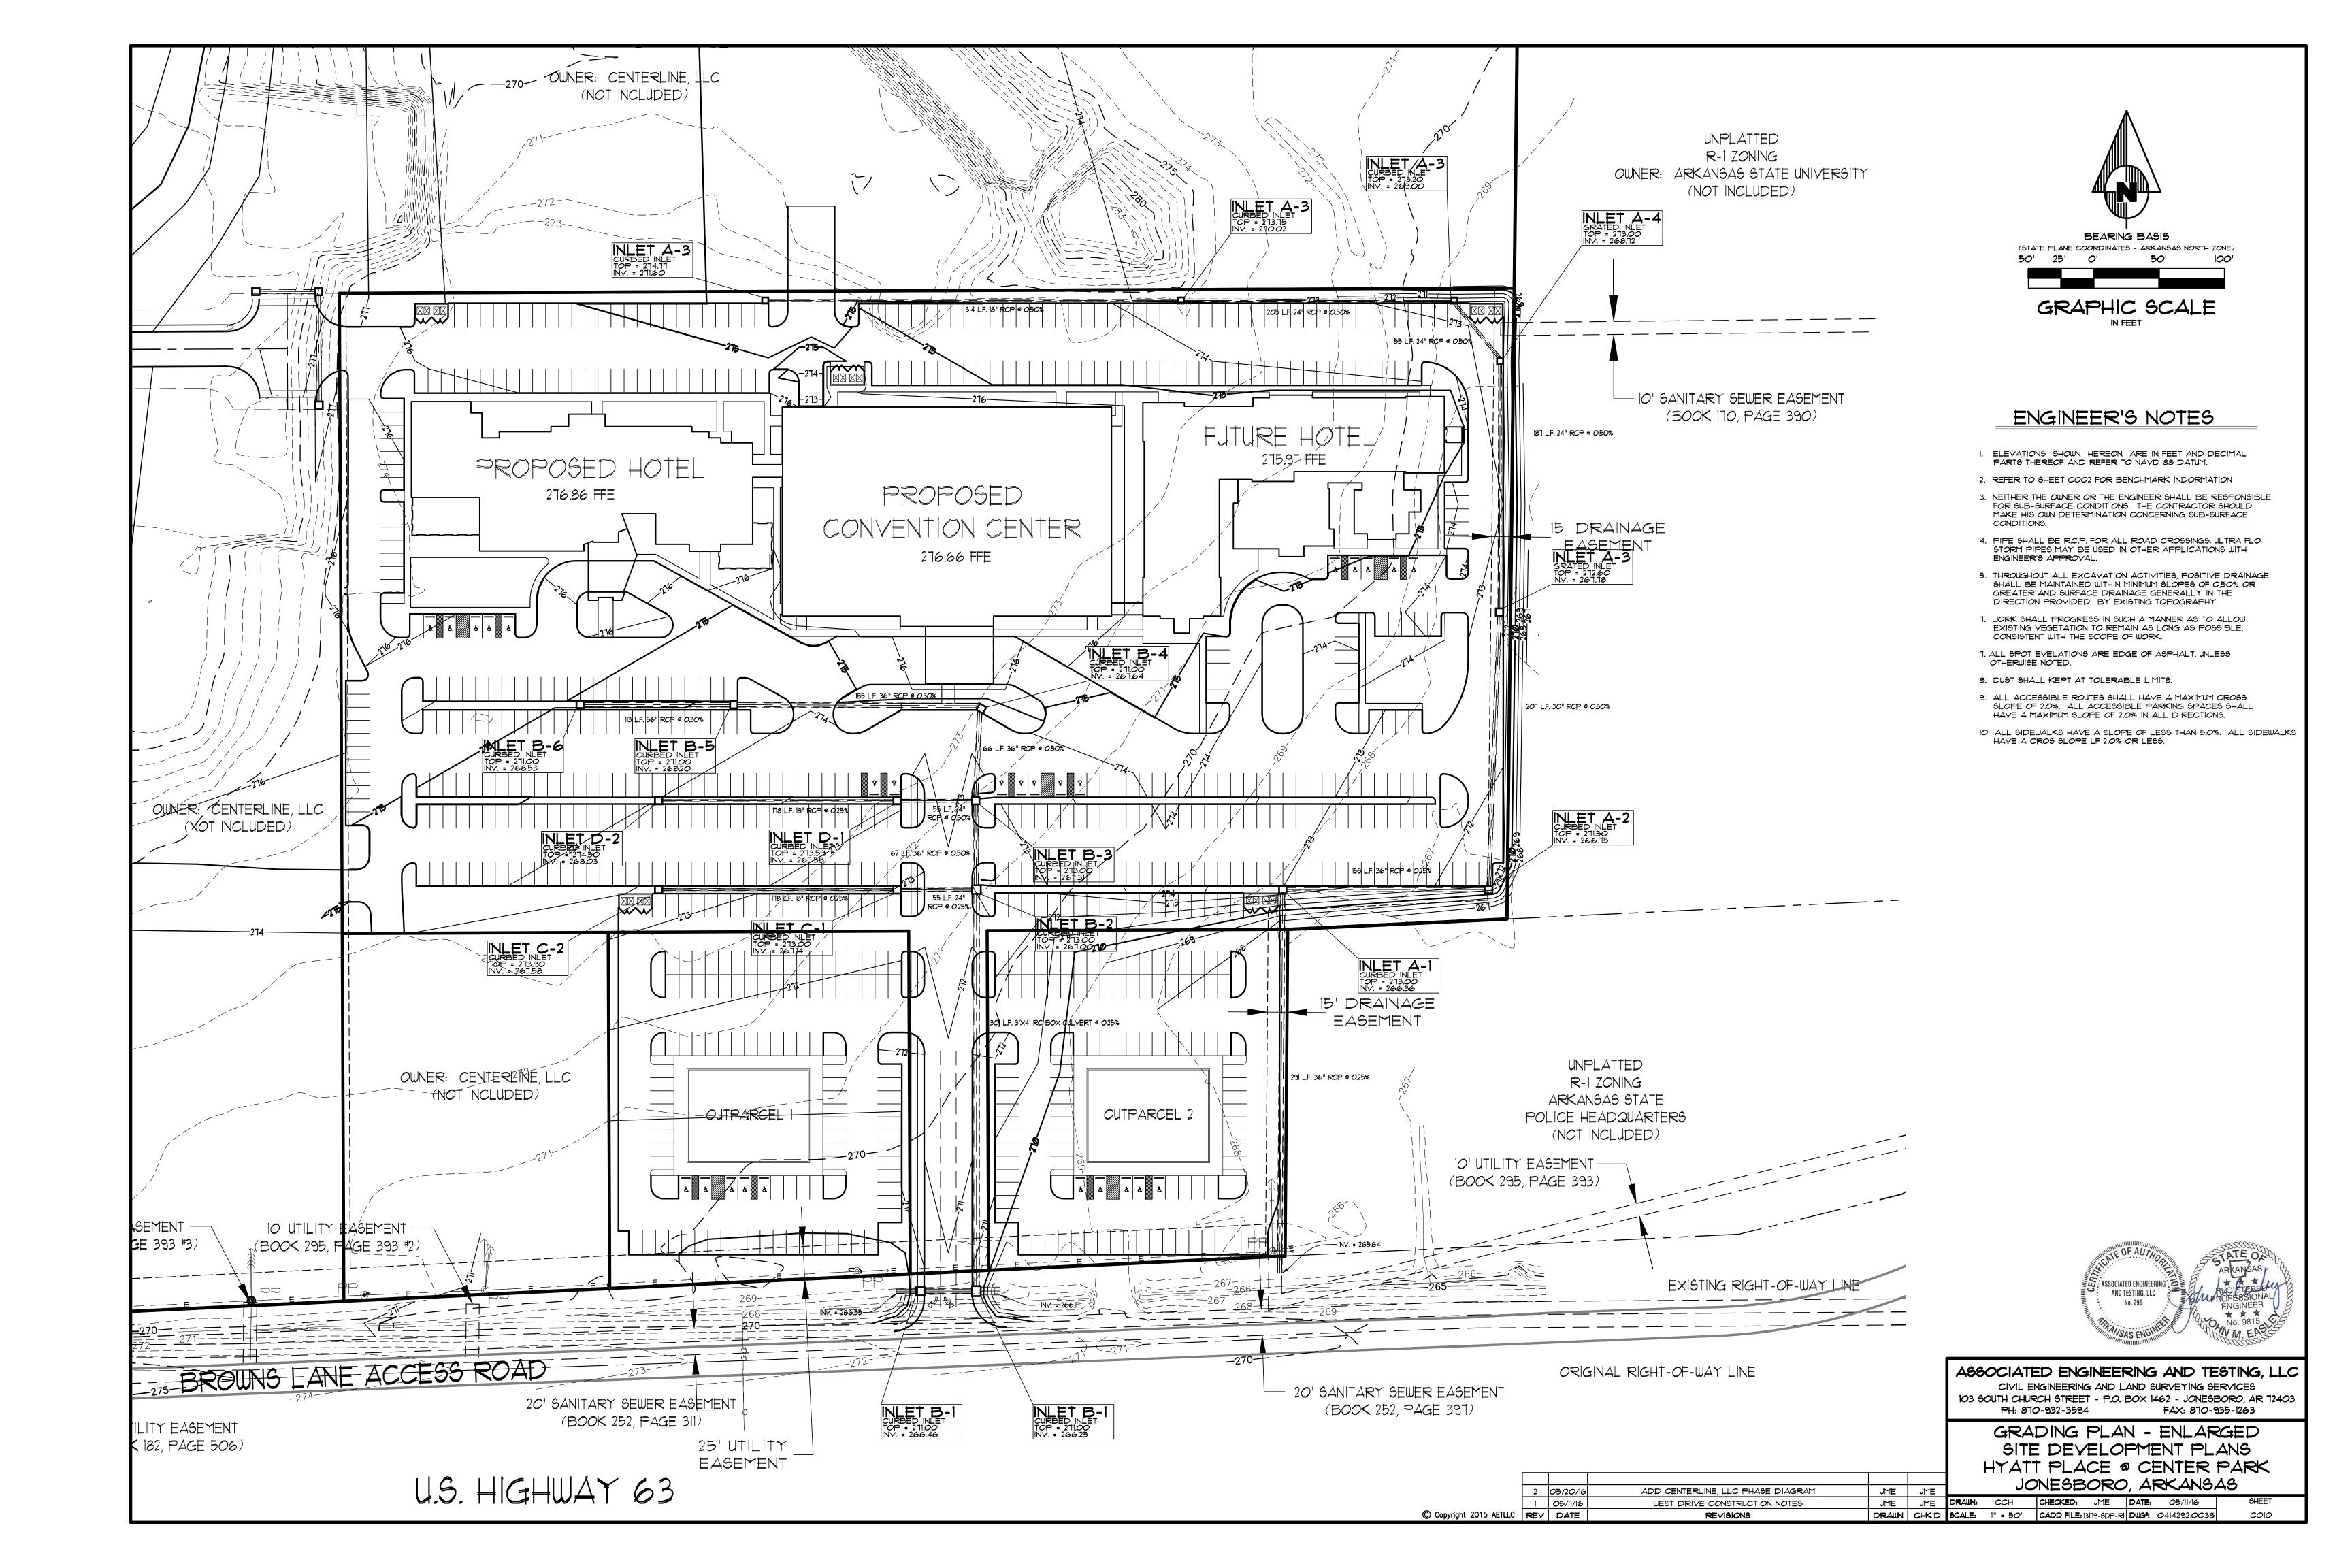

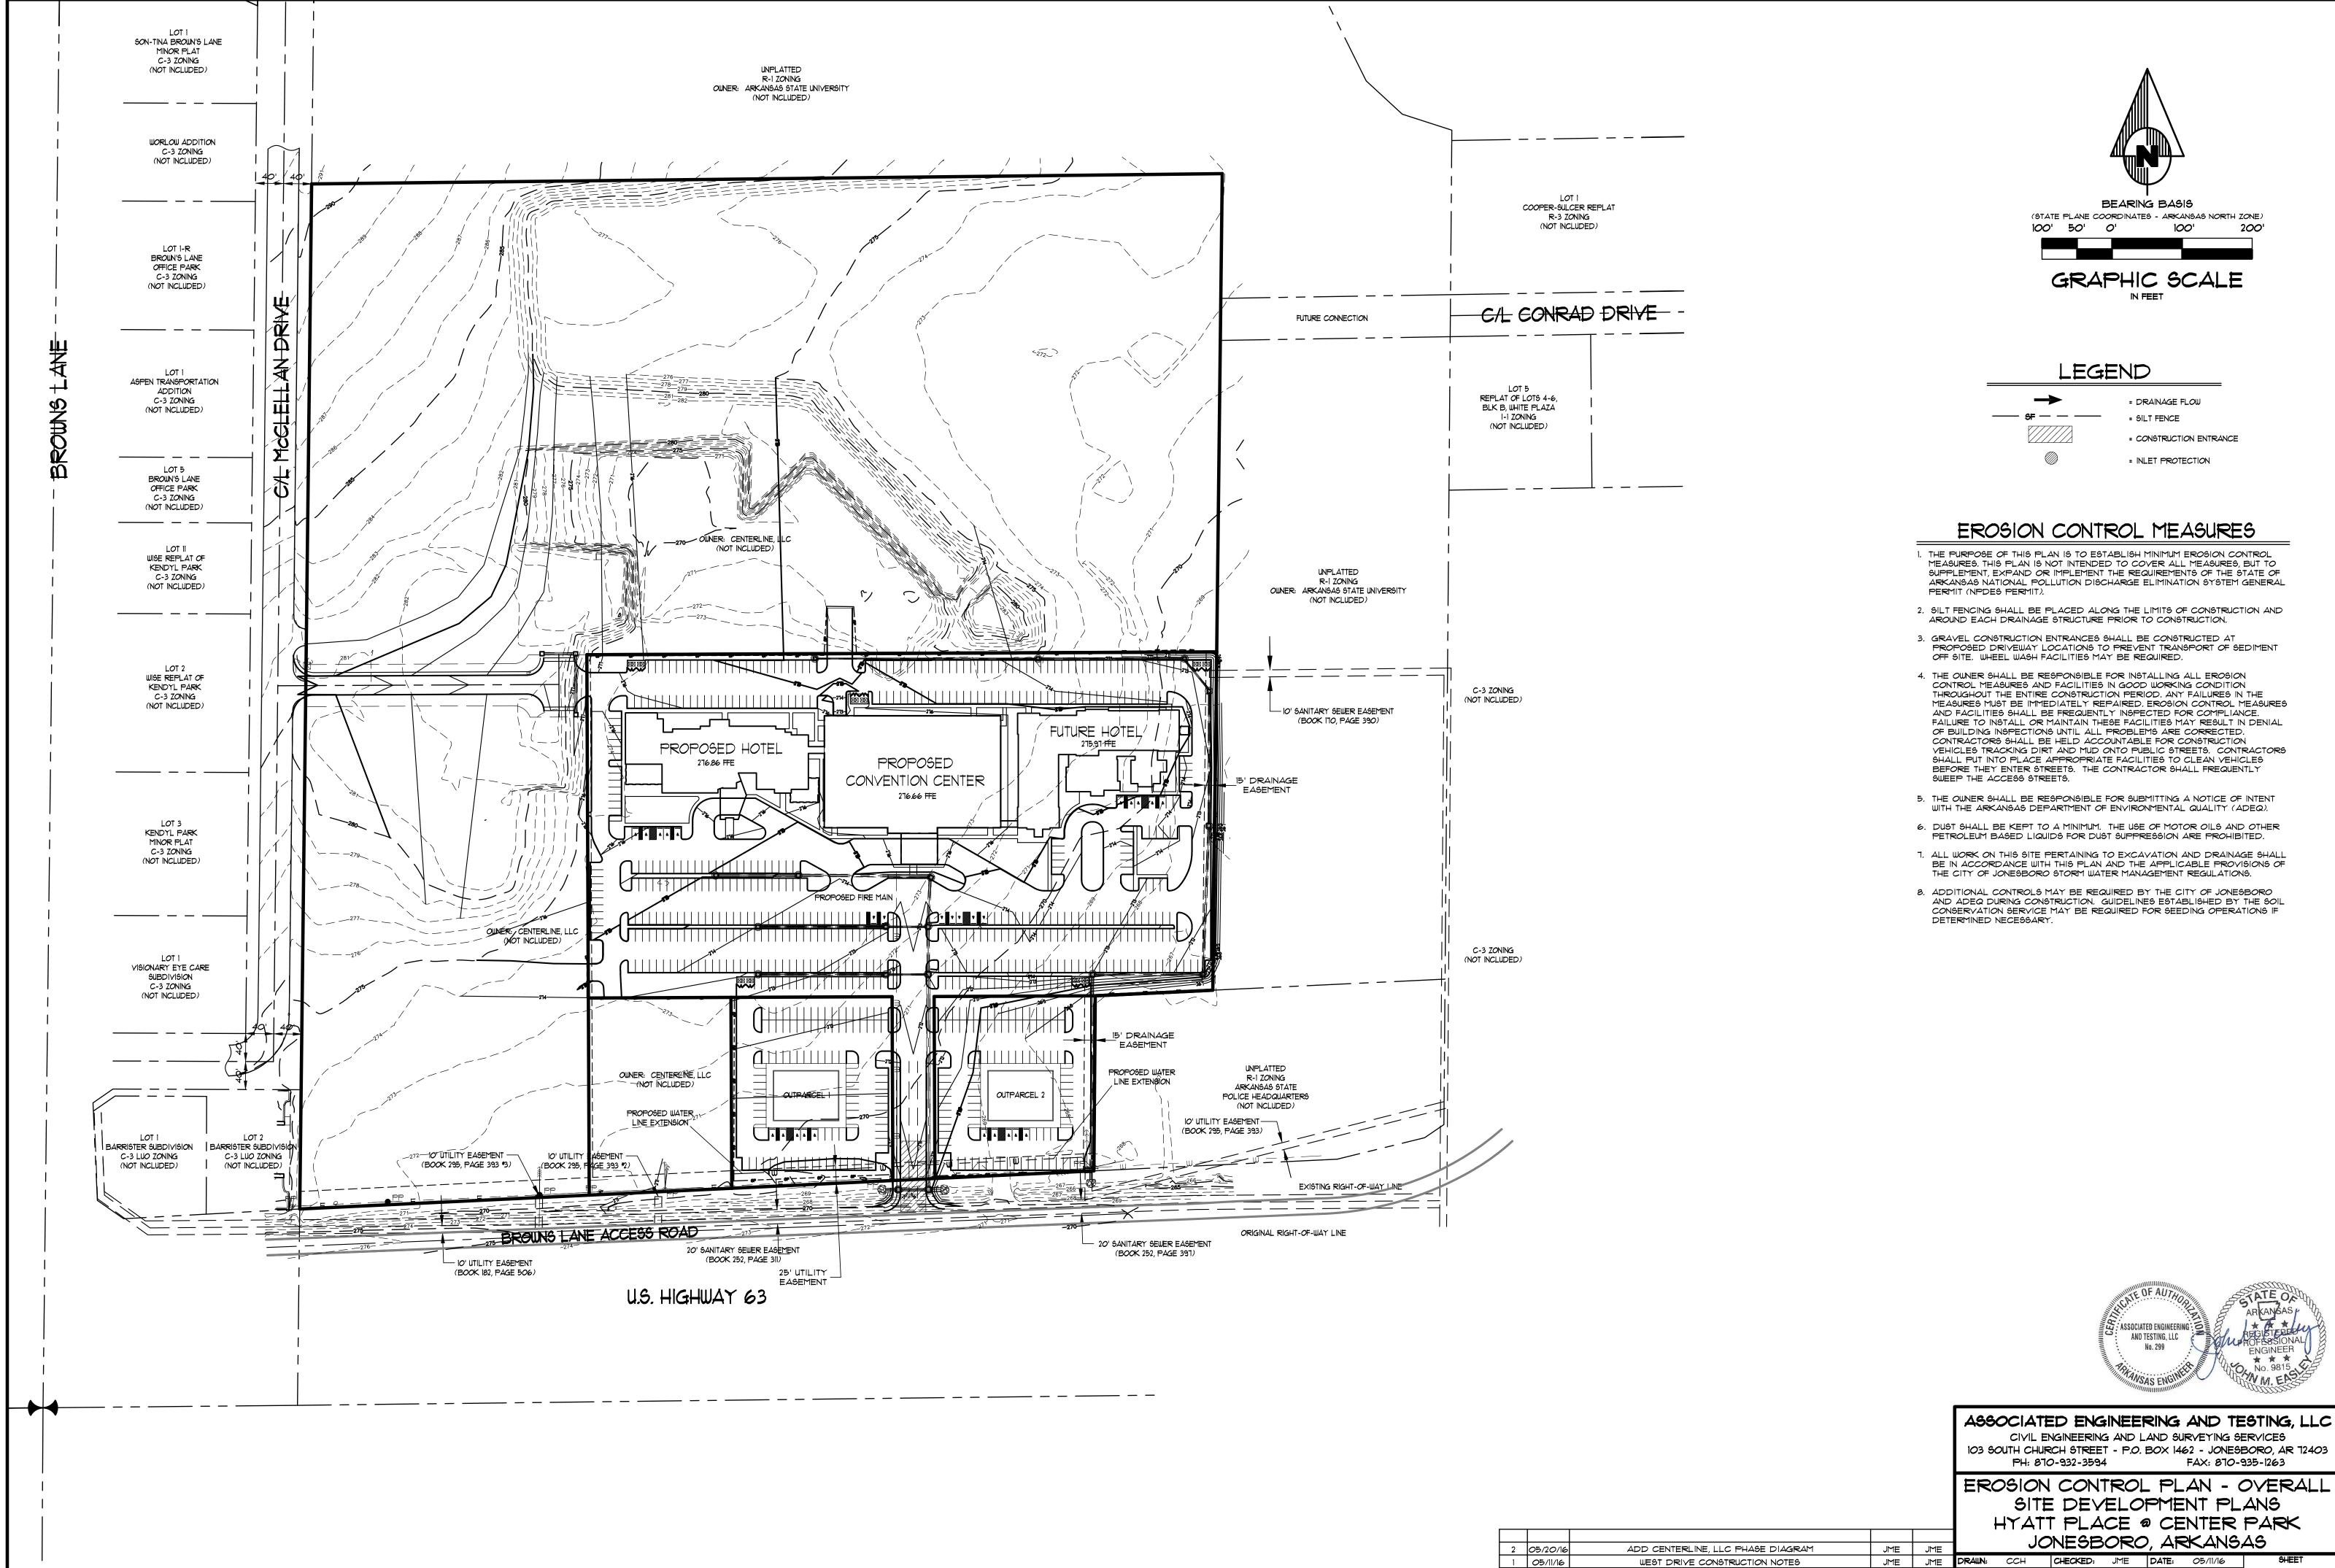


1 05/11/16


© Copyright 2015 AETLLC REY DATE

WEST DRIVE CONSTRUCTION NOTES


REVISIONS


DRAWN | CHK'D | SCALE: 1" = 100' | CADD FILE: 13179-5DP-R1 | DWG\*: 0414292.0038

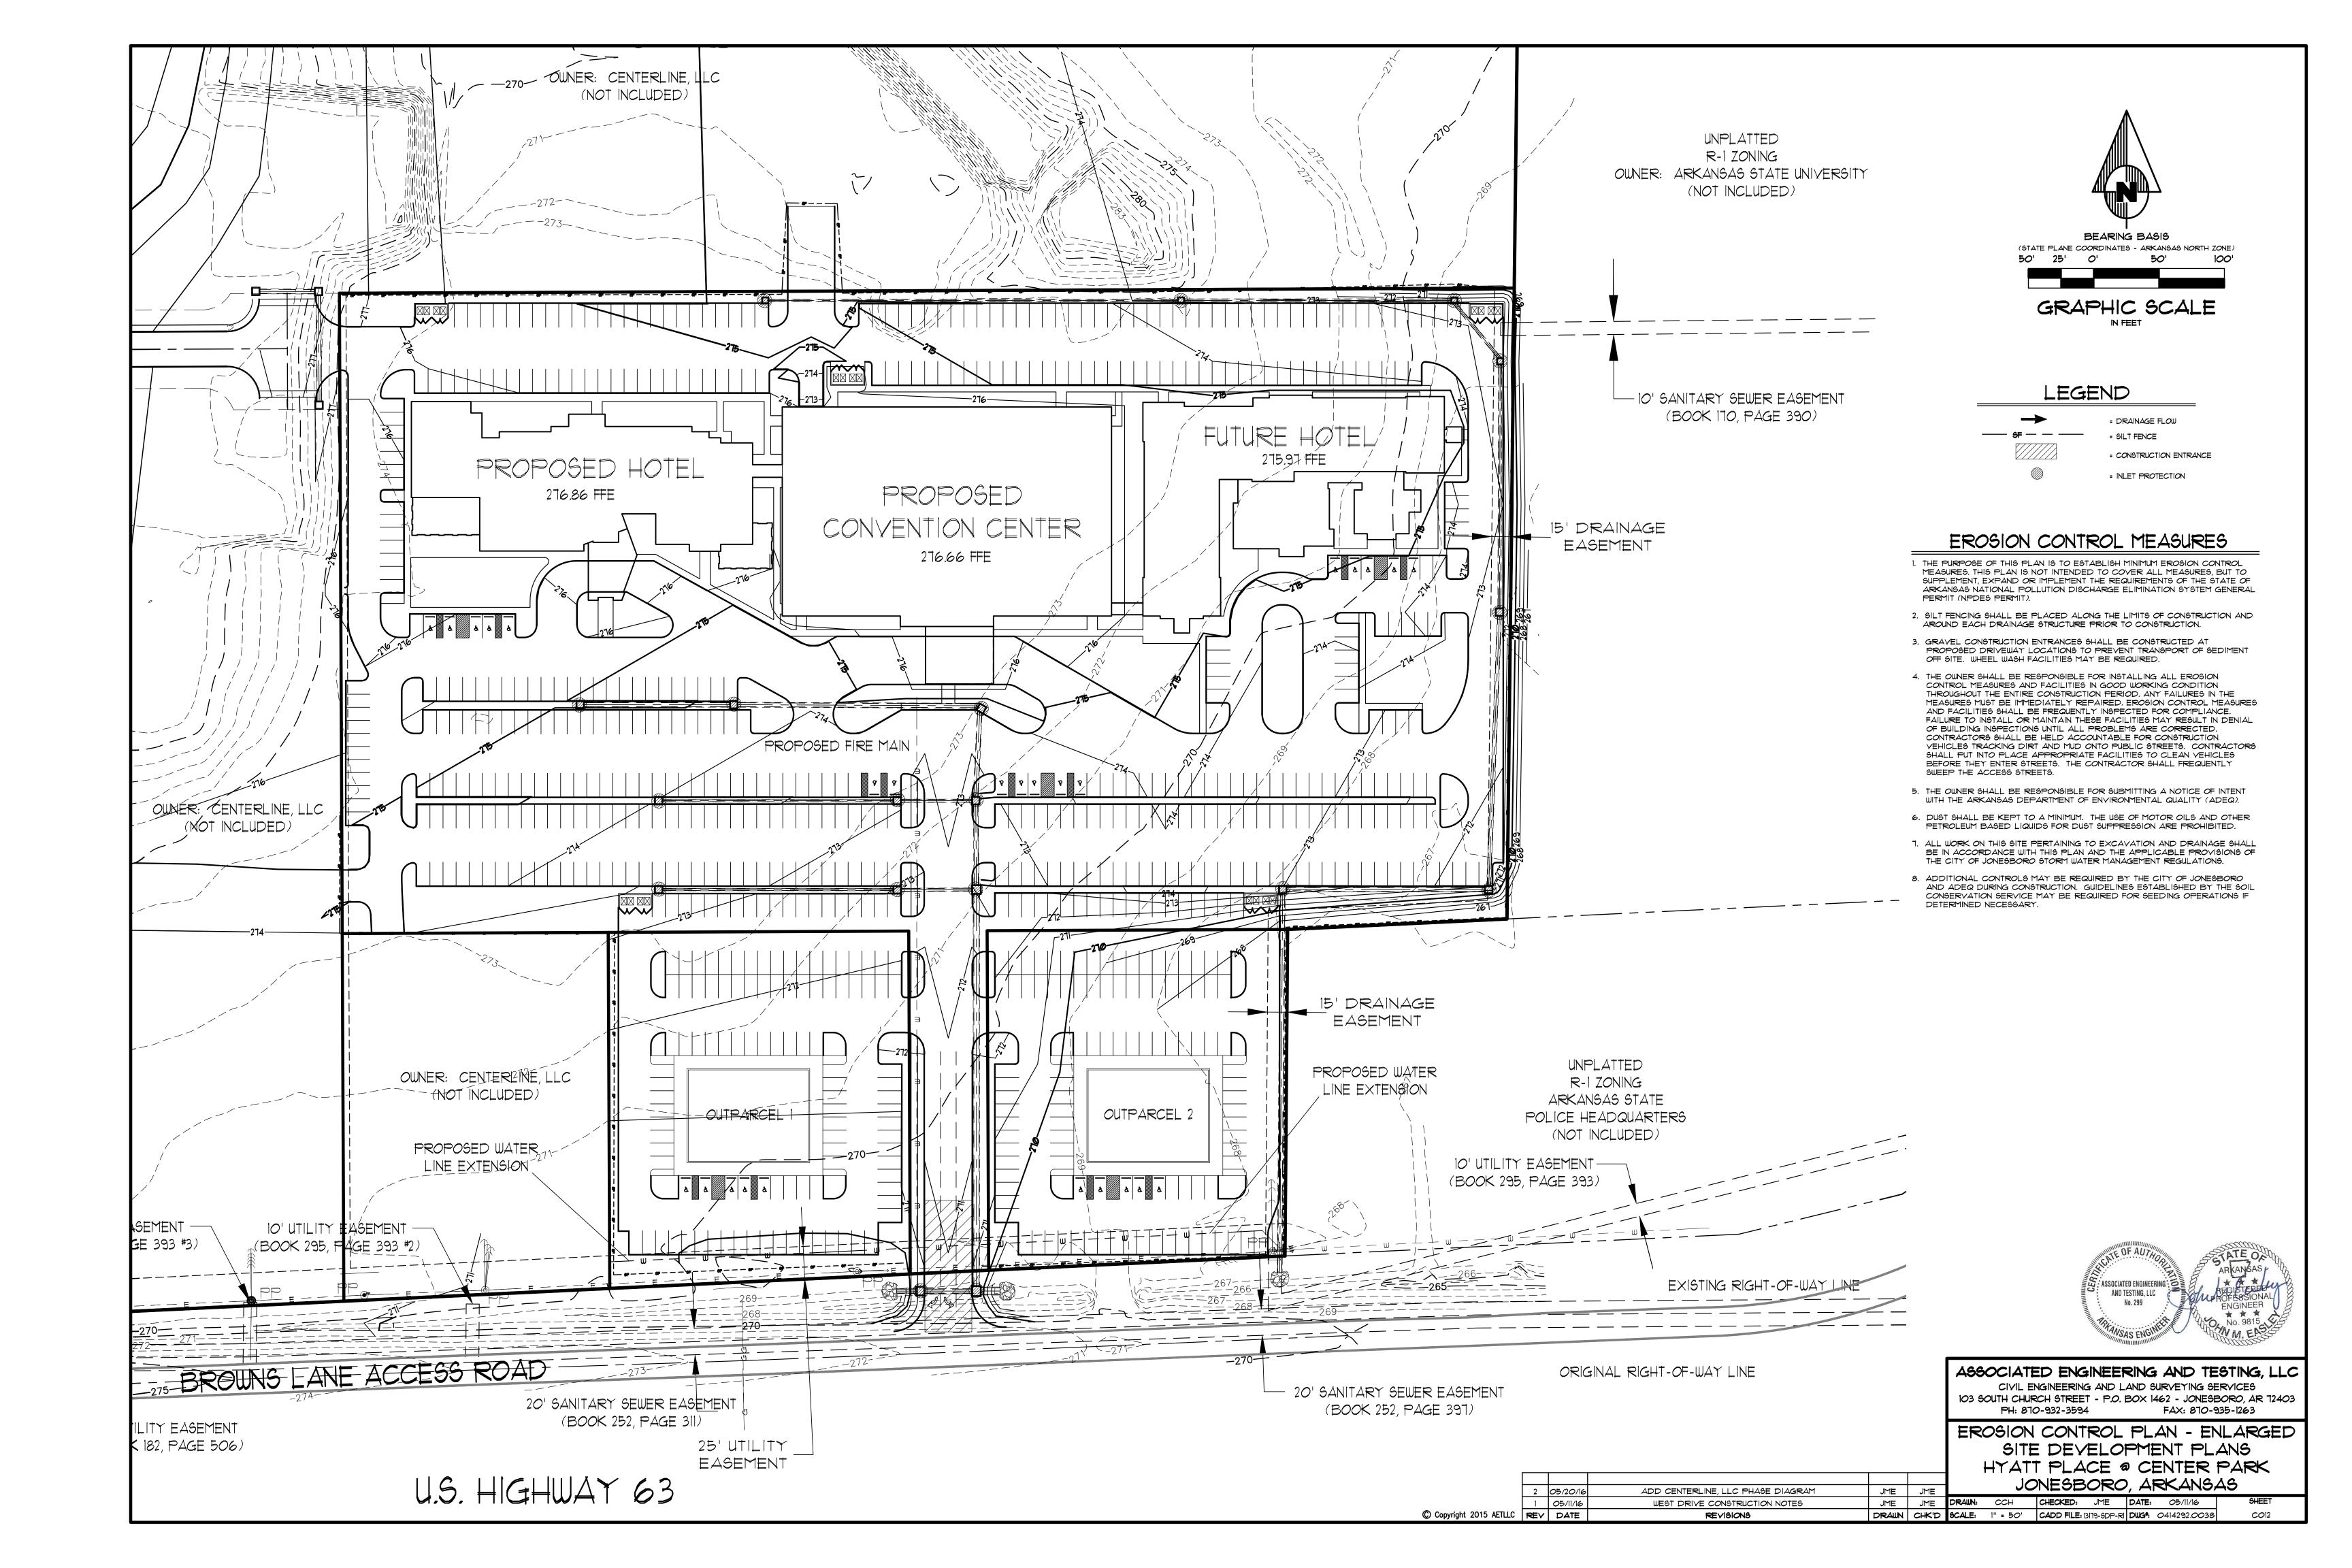

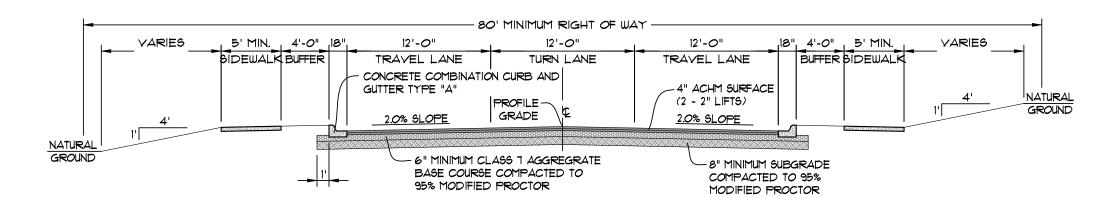


"WEST" STREET SECTION (COLLECTOR 2 STREET - MASTER STREET PLAN PREFERRED DESIGN) SCALE: NONE

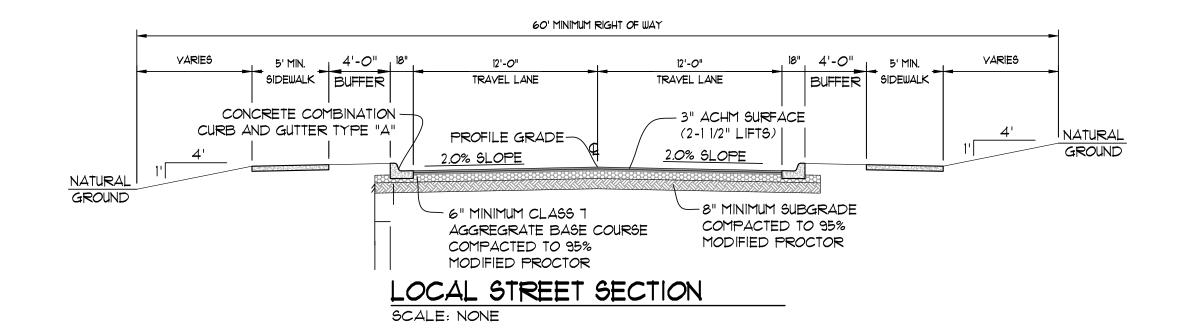


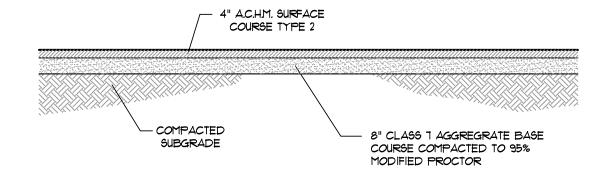


SECTION - ASPHALT PARKING - HEAVY

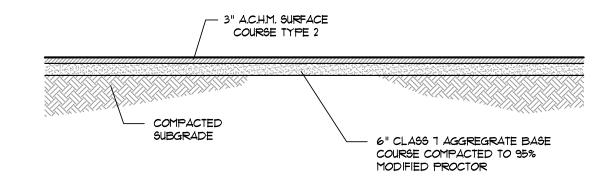

SECTION - ASPHALT PARKING - LIGHT

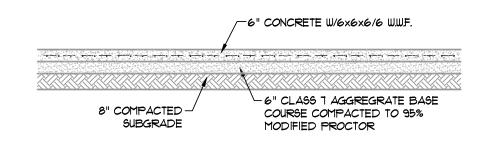


SECTION - CONCRETE PAYING - LIGHT

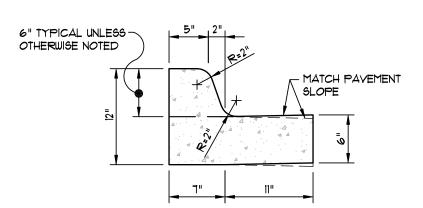


NOTE: CONTRACTION AND EXPANSION JOINTS SHALL BE CONSTRUCTED IN ACCORDANCE WITH THE PLANS AND SPECIFICATIONS.

(NOT TO SCALE)

## TYPICAL CURB & GUTTER TYPE "A-18"

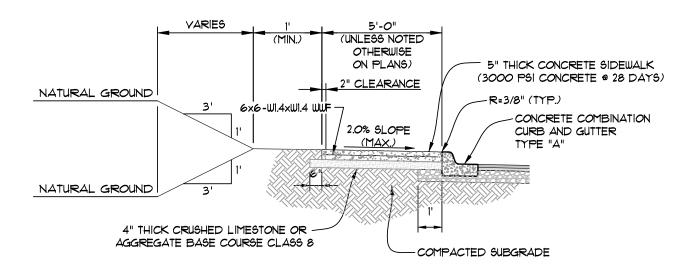



TYPICAL SECTION - SIDEWALK AT CURB

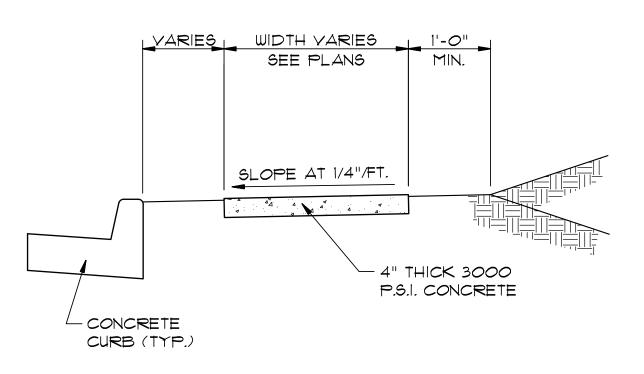

TYPICAL SECTION - SIDEWALK


\* MINIMUM WIDTH FOR SIDEWALK ADJACENT TO CURB IS 5' FOR CITY STREETS AND 6' FOR STATE OR U.S. HIGHWAYS.

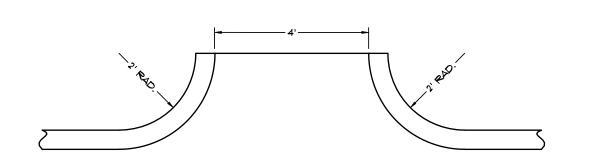

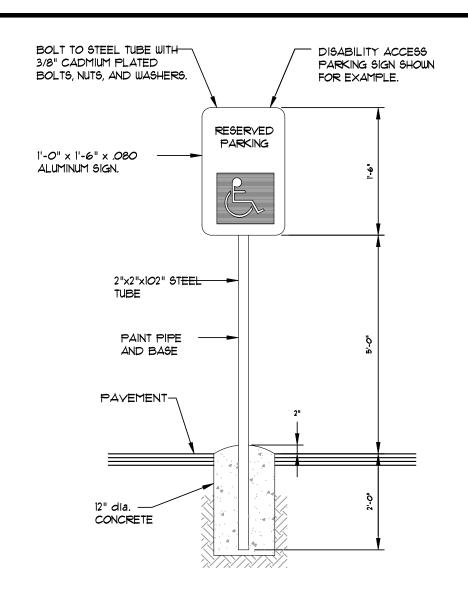


NOTE: ALL SIGNS SHALL CONFORM TO MUTCD AND SHALL BE HIGH INTENSITY.

#### SIGN DETAIL SCALE: 1/2" = 1'-0"

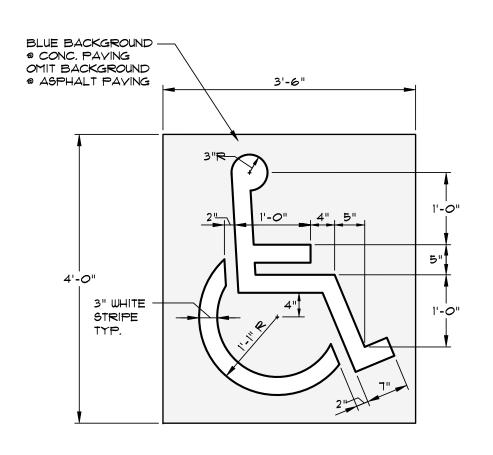

PARKING STALL SYMBOL SCALE: 3/4" = 1'-0"

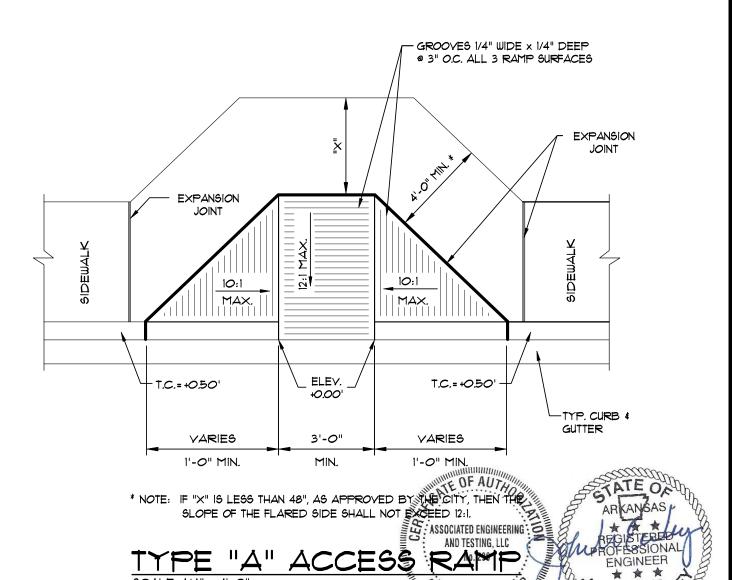


ASSOCIATED ENGINEERING AND TESTING, LLC CIVIL ENGINEERING AND LAND SURVEYING SERVICES 103 SOUTH CHURCH STREET - P.O. BOX 1462 - JONESBORO, AR 72403 PH: 870-932-3594 FAX: 870-935-1263


STANDARD DETAILS SITE DEVELOPMENT PLANS HYATT PLACE @ CENTER PARK

CURB CHANNEL 2 05/20/16

ADD CENTERLINE, LLC PHASE DIAGRAM JME JME JME JME **DRAWN**: CCH 1 05/11/16 WEST DRIVE CONSTRUCTION NOTES C Copyright 2015 AETLLC REY DATE REVISIONS DRAWN CHK'D SCALE: AS SHOWN CADD FILE: 13179-SDP-RI DWG. 0414292.0038

JONESBORO, ARKANSAS CHECKED: JME DATE: 05/11/16

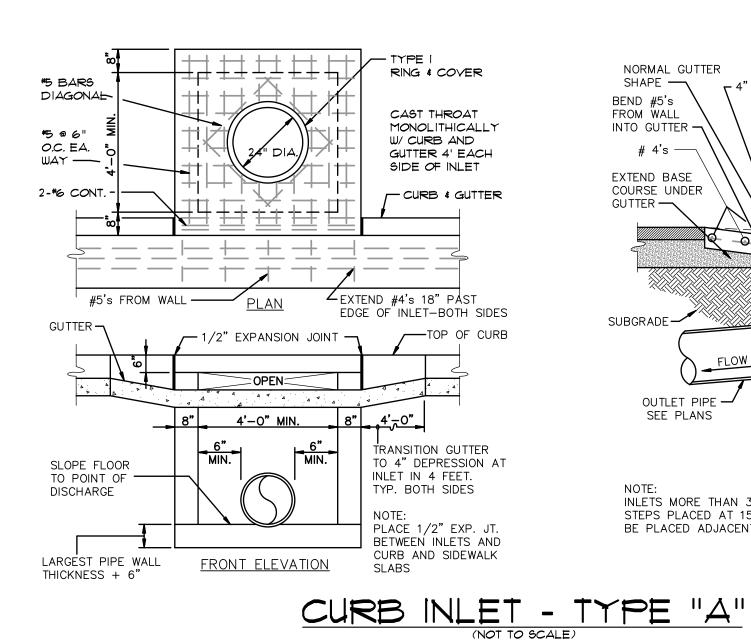

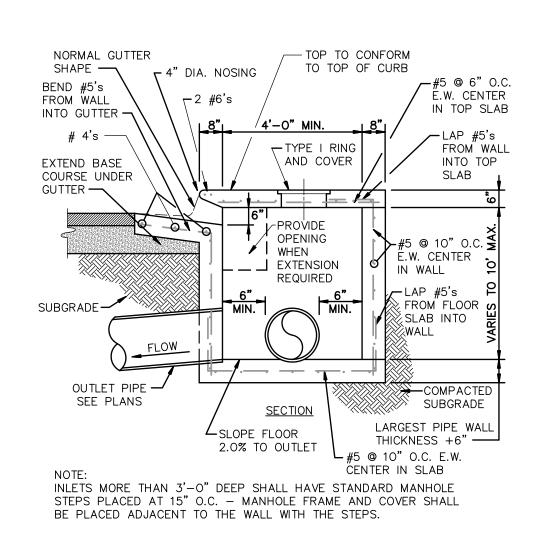

3 - \*6 BARS IN
BOTTOM (12 TOTAL)

\*5 BARS • 10" O.C.


\*5 BARS • 10" O.C.

\*6 BARS • 6"
O.C. EACH WAY
IN BOTTOM OF
TOP SLAB

\*5 BARS • 6" IN TOP
OF TOP SLAB NOT
SHOWN IN THIS VIEW

WIDTH VARIES




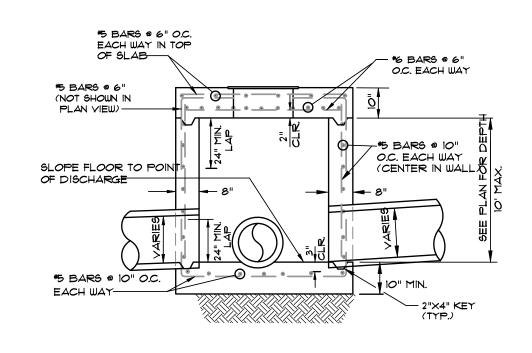

SECTION - JUNCTION BOX - HEAVY

NOTES:


- 1. SHOULD BE USED TO ACCOMMODATE VEHICULAR TRAFFIC.
- 2. JUNCTION BOXES MORE THAN 3 FEET DEEP SHALL HAVE STANDARD MANHOLE STEPS PLACED @ 15" O.C.
- 3. SEE REINFORCING DETAIL FOR OPENING IN WALL OR SLAB.

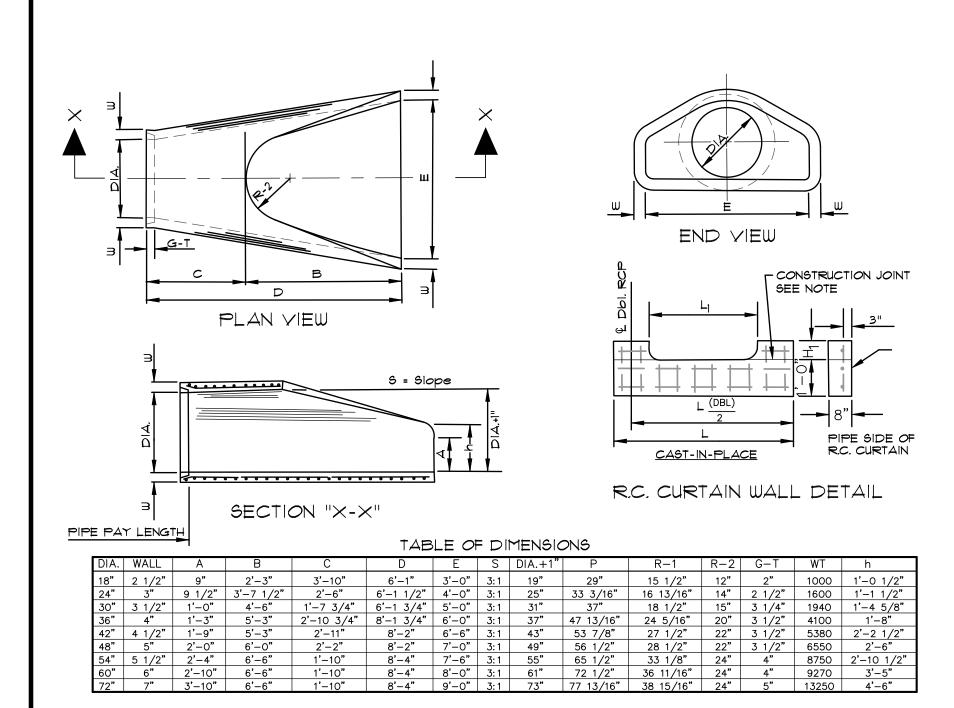


#### \\ **0** + = \$

- 1. THE PORTION OF THE R.C. CURTAIN WALL BENEATH THE FLARED END SECTION (LOWER 1'-O") SHALL BE PLACED MONOLITHICALLY. THE FLARED END SECTION SHALL THEN BE SET IN PLACE AND THE REMAINING PORTIONS OF THE R.C. CURTAIN WALL PLACED.
- 2. ALL REINFORCING STEEL ARE #4 BARS AT 6" O.C.
- 3. NO SEPARATE PAYMENT WILL BE MADE FOR THE CURTAIN WALLS. THEY SHALL BE CONSIDERED SUBSIDIARY TO THE FLARED END SECTIONS.
- 4. TONGUE END ON UPSTREAM SECTION, GROOVE END ON DOWNSTREAM SECTION.

FLARED END SECTION DETAILS FOR REINFORCED CONCRETE PIPE CULVERT

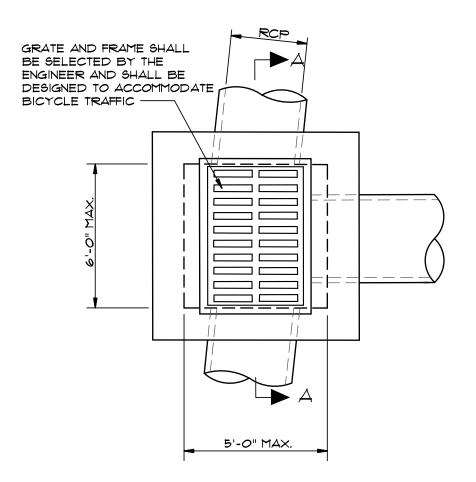




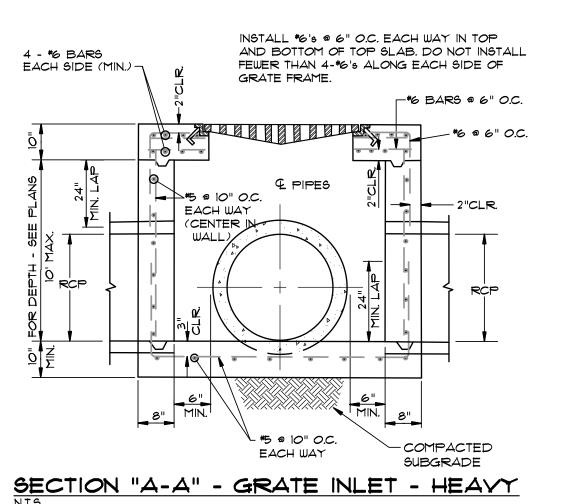


NOTES:


- 1. SHOULD BE USED TO ACCOMMODATE VEHICULAR TRAFFIC.
- 2. JUNCTION BOXES MORE THAN 3 FEET DEEP SHALL HAVE STANDARD MANHOLE STEPS PLACED @ 15" O.C.
- 3. SEE REINFORCING DETAIL FOR OPENING IN WALL OR SLAB

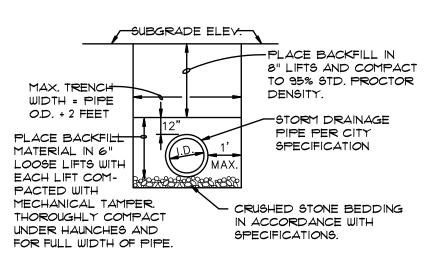



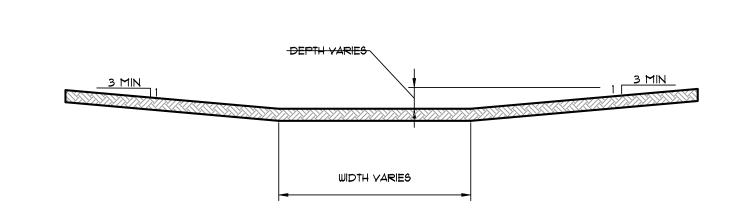

DETAIL - DRAINAGE SWALE - FLAT BOTTOM

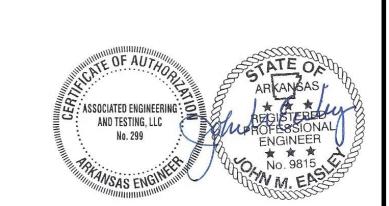

ASSOCIATED ENGINEERING AND TESTING, LLC

CIVIL ENGINEERING AND LAND SURVEYING SERVICES

103 SOUTH CHURCH STREET - P.O. BOX 1462 - JONESBORO, AR 12403

PH: 870-932-3594

FAX: 870-935-1263

STANDARD DETAILS SITE DEVELOPMENT PLANS HYATT PLACE @ CENTER PARK JONESBORO, ARKANSAS

2 05/20/16 ADD CENTERLINE, LLC PHASE DIAGRAM JME JME JME JME JME JME DATE: 05/11/16 UEST DRIVE CONSTRUCTION NOTES JME JME DRAWN: CCH CHECKED: JME DATE: 05/11/16 COpyright 2015 AETILLC REV DATE REVISIONS DRAWN CHK'D SCALE: AS SHOWN CADD FILE: 13179-5DP-RI DWG\*: 0414292.0038

