
CWC MECHANICAL

NESTLE ROAD JONESBORO, ARKANSAS

MARCH 29, 2010

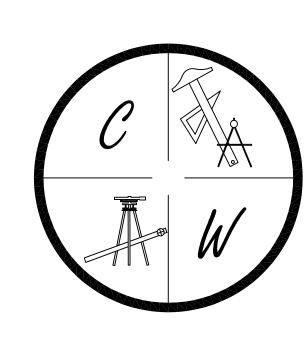


CARLOS WOOD, P.E.
ENGINEERING CONSULTANT
PMB 261
2704-L S. CULBERHOUSE
JONESBORO, AR 72401
PHONE/FAX: (870) 972-8335

EMAIL: WOODENGR@SBCGLOBAL.NET WEBSITE: WWW.WOODENGR.COM



STREET VICINITY MAP

SCALE: 1" = 1000'

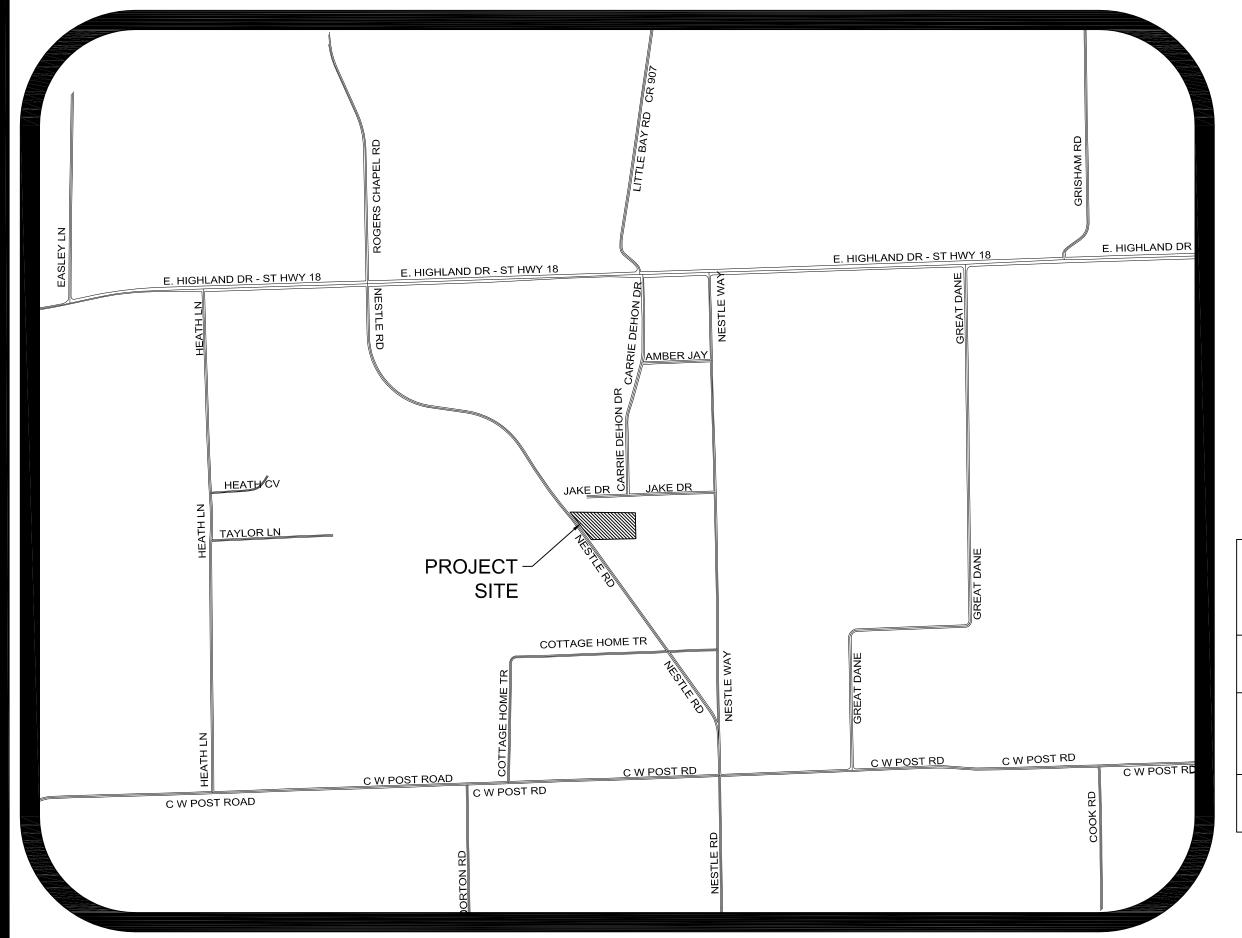





SHEET LAYOUT	
PLAT	
SITE DEVELOPMENT PLAN	SP-1
EROSION CONTROL MAP	ECM-1

PARCEL VICINITY MAP


NOT TO SCALE

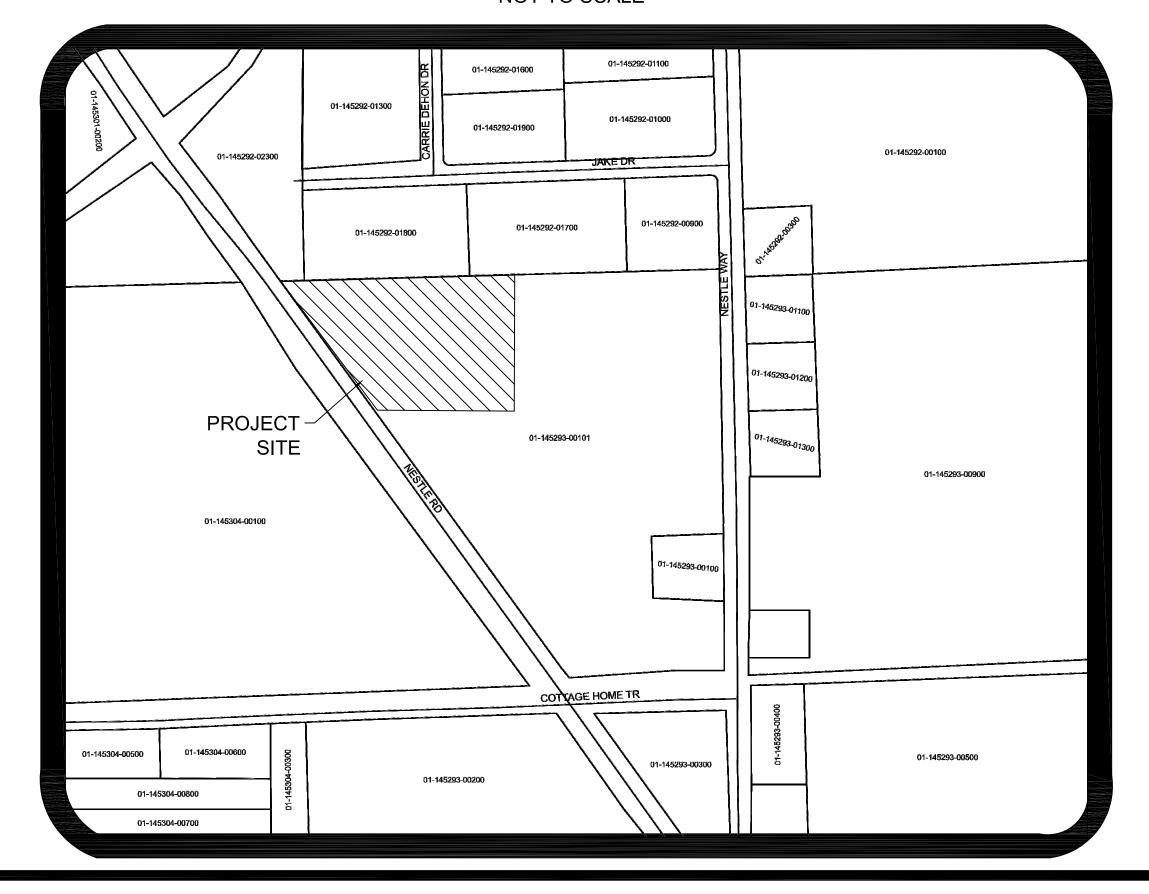

C MECHANICAL SITE PLAN

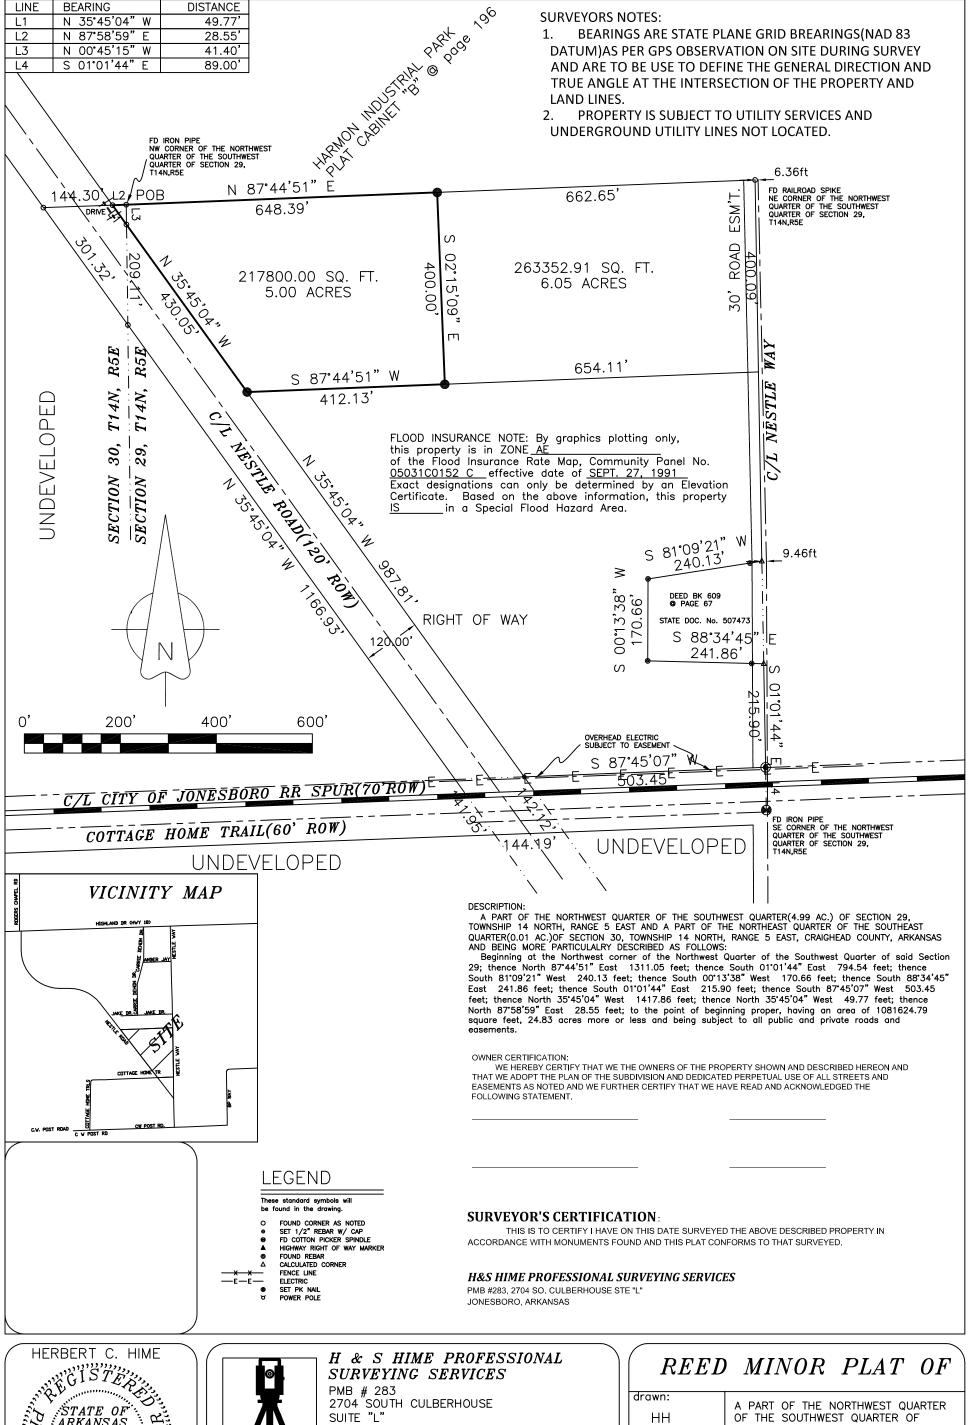



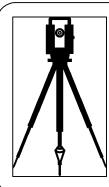

JONESBORO, ARKANSAS 72401

PHONE: 870 972 1288 870 972 1011 FAX:

l		
l	drawn:	A PART OF THE NORTHWEST QUARTER
	HH	OF THE SOUTHWEST QUARTER OF SECTION 29, T14N, R5E AND A PART OF
	date:	THE NORTHÉAST QUARTER OF THE SOUTHEAST QUARTER OF SECTION 30.
	2-15-2010	
l	scale:	client:
	1"=200'	TERRY L. REED ETAL

500-14N-05E-0-29-340-16-1142 500-14N-05E-0-30-210-16-1142 1. LOCATION MAP DRAWN TO A MINIMUM SCALE OF ONE INCH (1") EQUALS ONE THOUSAND FEET (1000') AND CLEARLY SHOWING CITY LIMITS AND STREETS WITHIN ONE-HALF (1/2) MILE RADIUS OF THE

3. DRAWN TO A MINIMUM SCALE OF ONE INCH (1") EQUALS FIFTY

5. DATE OF PLAN OR PLANS (IF THE SITE DEVELOPMENT PLAN CONSISTS OF MORE THAN ONE SHEET, THE SAME DATE SHOULD BE SHOWN ON ALL SHEETS FOR EASE OF REFERENCE)

7. NAME, ADDRESS, TELEPHONE NUMBER AND FAX NUMBER OF ALL

8. SEAL OF THE APPROPRIATE PROFESSIONAL REGISTERED IN THE

10. MINIMUM REQUIRED STREET, SIDE, AND REAR SETBACKS AS SET OUT IN THE JONESBORO ZONING OR BY PRIVATE REQUIREMENTS. IF ANY EXIST, AND IF THEY ARE MORE RESTRICTIVE THAN THE

11. FLOODWAY AND FLOODPLAIN BOUNDARIES WITH ELEVATIONS REFERENCED TO, AND SHOWING THE EXACT LOCATION OF, THE NEAREST BENCHMARK. IF THE PROPERTY IS NOT AFFECTED BY A FLOODWAY OR IS NOT WITHIN A FLOODPLAIN, AN ENGINEER SHALL

BFE = 235.00 (NVGD 29) - 235.24 (NVGD 88)

13. NAMES AND ADDRESSES OF ALL OWNERS OF ADJOINING

SOUTH: TERRY REED, 2919 DACUS LN, JONESBORO

14. LENGTH OF SITE BOUNDARIES MEASURED TO THE NEAREST 1/10

15. VALUE OF ALL TRUE BEARINGS AND ANGLES AS DIMENSIONED IN

MEASURED FROM THE OUTSIDE WALLS OF ALL EXISTING AND

SITE. IF A PROPOSED BUILDING IS MORE THAN ONE STORY IN

HEIGHT, THE GROSS FLOOR AREA OF THE ENTIRE STRUCTURE

PROPOSED BUILDINGS AND STRUCTURES LOCATED ON SUBJECT

17. ALL PROPOSED IMPROVEMENTS IN THEIR EXACT RELATIONSHIP TO

EXISTING CONTOURS AND OTHER TOPOGRAPHIC FEATURES

IMPOUNDMENT DATA

CFS

PRE FLOW POST FLOW

FL = 234.00

IMPOUNDMENT

(REQUIRED) AC-FT

IMPOUNDMENT

(PROVIDED) AC-FT

16. LOCATION, SQUARE FOOTAGE, AND EXTERIOR DIMENSION,

CONTOURS NO GREATER THAN TWO FEET (2')

PROPERTY.

ON PLAT.

ON PLAT

ON DRAWING.

NORTH: TROY COLEMAN

EAST: TERRY REED

DEGREES AND MINUTES

SHOULD BE SHOWN ON THE PLAN

12. EXISTING AND PROPOSED LAND CONTOURS SHOWING VERTICAL

ON PLAT 19. LOCATION, SIZE, & TYPE OF EXISTING AND PROPOSED UTILITIES: THIS PROPERTY DOES LIE IN A FLOOD PLAIN AREA A. WATER MAINS & SERVICE LINES (ON & OFF SITE), NEAREST FIRE AS SHOWN ON CRAIGHEAD COUNTY, ARKANSAS AND HYDRANT (CHECK W/ FIRE MARSHALL AT 870-932-2428 & NOTE INCORPORATED AREAS FLOOD INSURANCE RATE MAP RESULTS ON PLANS) PANEL NUMBER 05031C0152C DATE SEPTEMBER 27,1991.

NEAREST FIRE HYDRANT IS LOCATED APPROX. 330' NORTH OF THE PROPERTY AT THE INTERSECTION OF JAKE DR & CARRIE DEHON DR A FIRE HYDRANT IS ALSO LOCATED ON NESTLE DR. APPROX. 730 EAST & SOUTHEAST OF THE SOUTHEAST PROPERTY CORNER.

18. EASEMENTS INDICATING LOCATION, DIMENSION, AND TYPE, IF NO

BE PLACED ON THE PLAN

EASEMENTS EXIST ON THE SITE, A NOTE TO THIS EFFECT SHOULD

B. SANITARY SEWER MAINS & SERVICE LINES (ON & OFF SITE) SEPTIC SYSTEM TO BE APPROVED BY ARK HEALTH DEPT.

C. GAS MAINS & SERVICE LINES (ON & OFF SITE) NONE

D. ELECTRICAL MAINS & SERVICE LINES NONE E. STORM DRAIN MAINS & SERVICE LINES

SPACES PROVIDED = 23 SPACES

ON DRAWING F. DUMPSTER OR REFUSE RECEPTACLE ON DRAWING

TO BE SUBMITTED BY ARCHITECT OR PLUMBER 20. DRAINAGE PLAN PREPARED & SEALED BY ARK LICENSED CIVIL ENGINEER W/ EXISTING & PROPOSED STORM WATER RUNOFF FLOW CALCULATIONS. EROSION CONTROL & SWPP PLAN FOR SEDIMENT DISCHARGE CONTROL

RIP-RAP &

FABRIC

SEDIMENT BASIN

N: 541,687.1042

PK NAIL IN ASPHALT SHOULDER

ELÈVATION = 236.61(NVGD 88)

N: 541,667.177 E: 1,731,041.485

1,731,081.2204

G. DATE PLUMBING PLANS SUBMITTED TO ARK HEALTH DEPT

ON DRAWING & ENCLOSED REPORTS 21. PARKING REQUIREMENTS: OFFICE SPACE = 3,640 FT² (1 SPACE PER 300 FT²) SHOP AREA = $10,000 \text{ FT}^2$ (1 SPACE PER 1,000 FT²) SPACES REQUIRED = (3,640 ÷ 300) + (10,000 ÷ 1,000) = 12.13 + 10 = 22.13 SPACES

22. SIGN LOCATION AND TYPE ON DRAWING 23. SCREENING & BUFFERING

OUTFALL PIPE

PVC @ 1.0%

OUTSFALL STRUCTURE DETAIL

FLOW LINE

FLOOD PLAIN BOUNDARY

FLOOD PLAIN—— ZONE X

ELEV = 234.00

ON DRAWING 24. LANDSCAPING PLAN SHOWING LOCATION, SIZE, & TYPE OF EXISTING AND PROPOSED MATERIALS. LANDSCAPING MUST MEET JONESBORO ZONING ORDINANCE REQUIREMENTS.

LANDSCAPING LOCATIONS SHOWN ON DRAWING. 1 TREE OR 3 (5 GAL) SHRUBS PER 10 PARKING SPACES. 23 SPACES = 3 TREES OR 15 (5 GAL SHRUBS). PLANT QUALITY SHALL CONFORM TO THE MOST RECENT EDITION OF AMERICAN STANDARD FOR NURSERY STOCK PUBLICATION.

25. RESTRICTIVE COVENANTS, GRANTS OF EASEMENTS, OR OTHER RESTRICTIONS IN A RECORDED FORM (NOTE ON PLAN IF NOT APPLICABLE) NOT APPLICABLE

26. COMMON OPEN SPACE AND PROPOSED AMENITIES (NOTE ON PLAN IF NOT APPLICABLE) NOT APPLICABLE

27. PROPOSED LIGHTING LOCATION, TYPE, DIRECTION & INTENSITY ALL EXTERIOR LIGHTING FIXTURES SHALL BE LOCATED & DIRECTED SO THAT LIGHT DOES NOT "SPILL" ONTO ADJOINING PROPERTIES. UNIT LIGHT FIXTURES LOCATED ADJACENT TO FRONT & REAR ENTRANCES.

28. LOCATION & CHARACTERISTICS OF ANY HISTORICAL STRUCTURES & SITES NOT APPLICABLE

OP LEVEE

ELEV = 236.00

FLOW LINE

ELEV = 233.75

29. OWNER'S SIGNATURE AND STATEMENT INDICATING DEVELOPMENT OWNER IS IN AGREEMENT WITH SITE DEVELOPMENT PLANS ON DRAWING

NAME OF THE DEVELOPMENT CWC MECHANICAL ADDRESS AND LOT NUMBER OF THE PROPERTY

REED MINOR PLAT NAME, ADDRESS, TELEPHONE NUMBERS, FAX NUMBERS, AND SIGNATURES FOR ALL OWNERS OF THE PROPERTY AND THE

ADDRESS SIGNATURE SIGNATURE

I acknowledge my understanding that all site improvements shall conformto this approved Site Development Plan. The City Planner for the City of Jonesboro must approve, in writing, any deviations, variances, or changes from this approved Site Development Plan. All construction shall be in compliance with the Zoning Ordinance and with the conditions of the Zoning Permit, and with all lawsand ordinances governing this type of work. The design professional (architect, engineer, or landscape architect) sealing the approved Site Development Plan shall periodically inspect the installation and construction of all site improvements shown on and required by the Site Development Plan. Upon completion of all site improvements and prior to issuance of a Certificate of Occupancy,the design professional shall submit a letter to the City Planner verifying that construction has been completed in accordance with the approved Site Development Plan.

CONTRACTOR DATE

DATE

6" THICK 3500PSI MIN. AT 28 DAYS

PAVEMENT W/ 6% TO 8% AIR

0.45 WATER-CEMENT RATIO

(HEAVY DUTY)

COMPRESSIVE STRENGTH CONCRETE

ENTRAINMENT W/ MAX. 5" SLUMP AND -

DESIGN PROFESSIONAL

SURVEY CONTROL REFERENCE MARKS: • JONESBORO GPS MONUMENT # 14 JONESBORO GPS MONUMENT # 01 VERTICAL CONTROL IS NAVD 88 HORIZONTAL CONTROL IS NAD 83

FLOODPLAIN ELEVATION REFERENCE MARK: NGS PID: FF0815, DESIGNATION: G 33 ELEVATION = 235.02 (NAVD 29)235.26 (NAVD 88)

NORTHING: 543,437.124 EASTING: 1,732,141.236


DEVELOPER SHALL OBTAIN GRADING PERMIT FROM THE CITY OF JONESBORO ENGINEERING DEPARTMENT PRIOR TO COMMENCING EARTHWORK AND/OR CLEARING OPERATIONS.


DEVELOPER SHALL OBTAIN REQUIRED ADEQ PERMIT PRIOR TO COMMENCING WORK ON THE SITE, PREPARE A SWPP PLAN. AND DISPLAY THEM FOR PUBLIC ACCESS AT THE SITE.


LEGEND CURB HEAVY DUTY PAVEMENT AREA SB-2 PAVEMENT AREA DRAIN FLOW BENCHMARK FIRE HYDRANT —— 257' —— EXISTING CONTOUR PROPOSED CONTOUR PROPOSED SPOT ELEVATION TC=236.25 TW = TOP WALK TC = TOP CURB FG = FINISHED GROUND PVT = PAVEMENT EXISTING SPOT ELEVATION WATER LINE —— SANITARY SEWER LINE — OVERHEAD ELECTRIC SANITARY SEWER **MANHOLE**

POWER POLE


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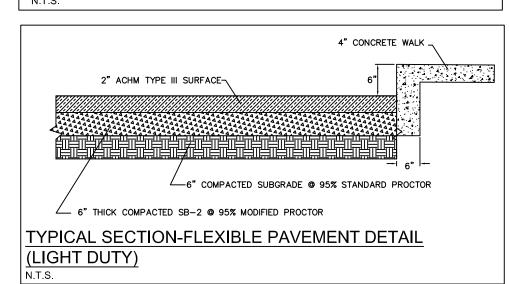


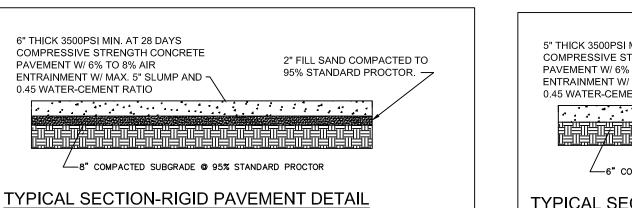


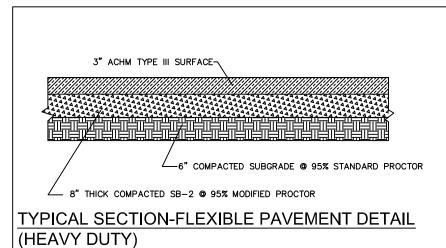


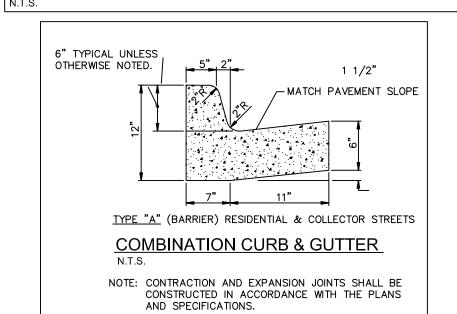
HANDICAP PARKING DETAIL




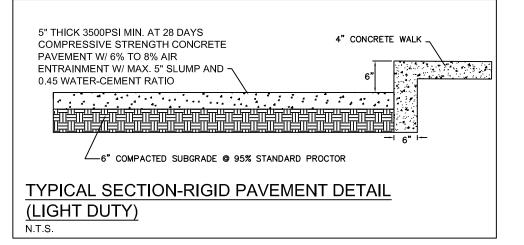

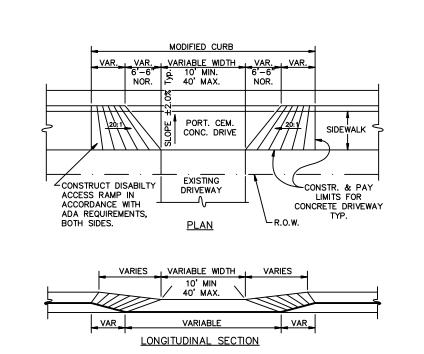

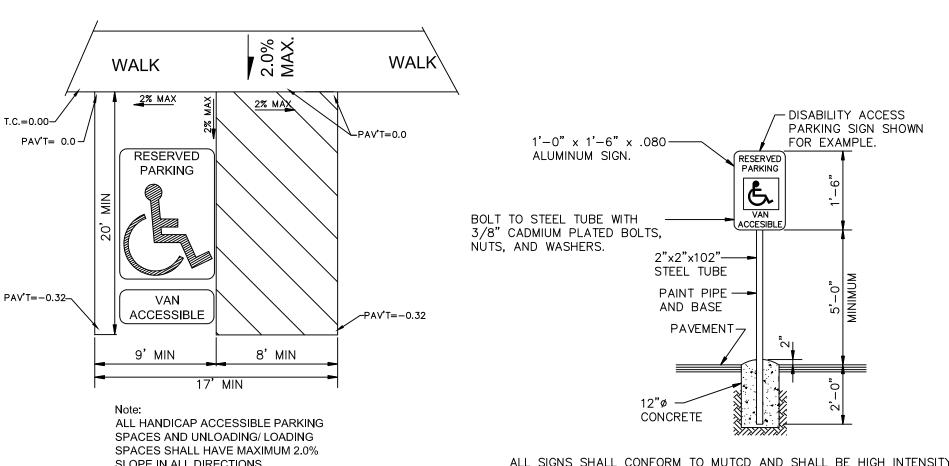

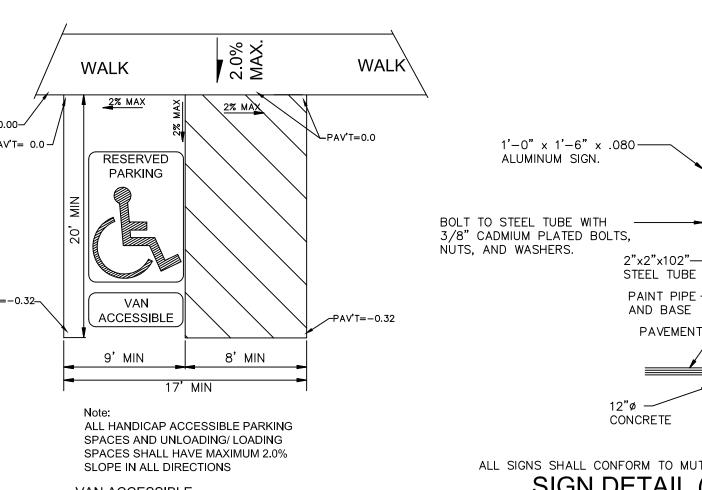

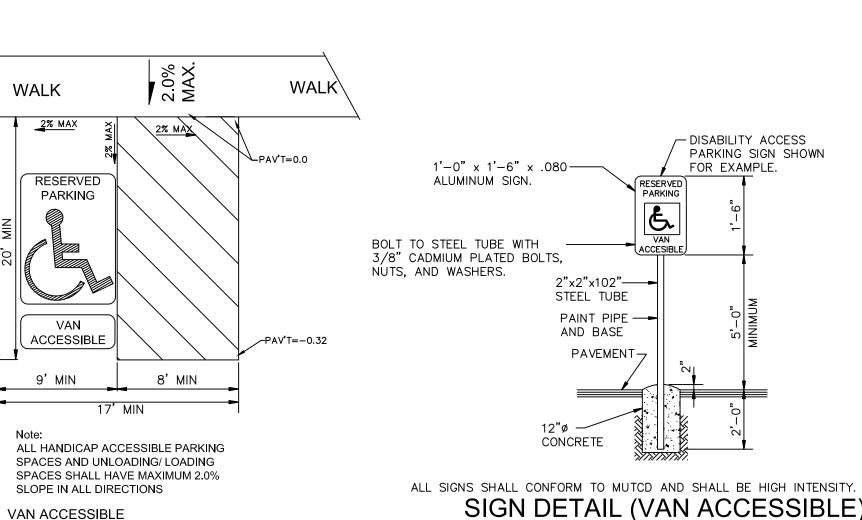

 \Box 9

ARKANSAS

REGISTERED


PROFESSIONAL

ENGINEER

NO. 5620

DATE: 3/29/10

R GW

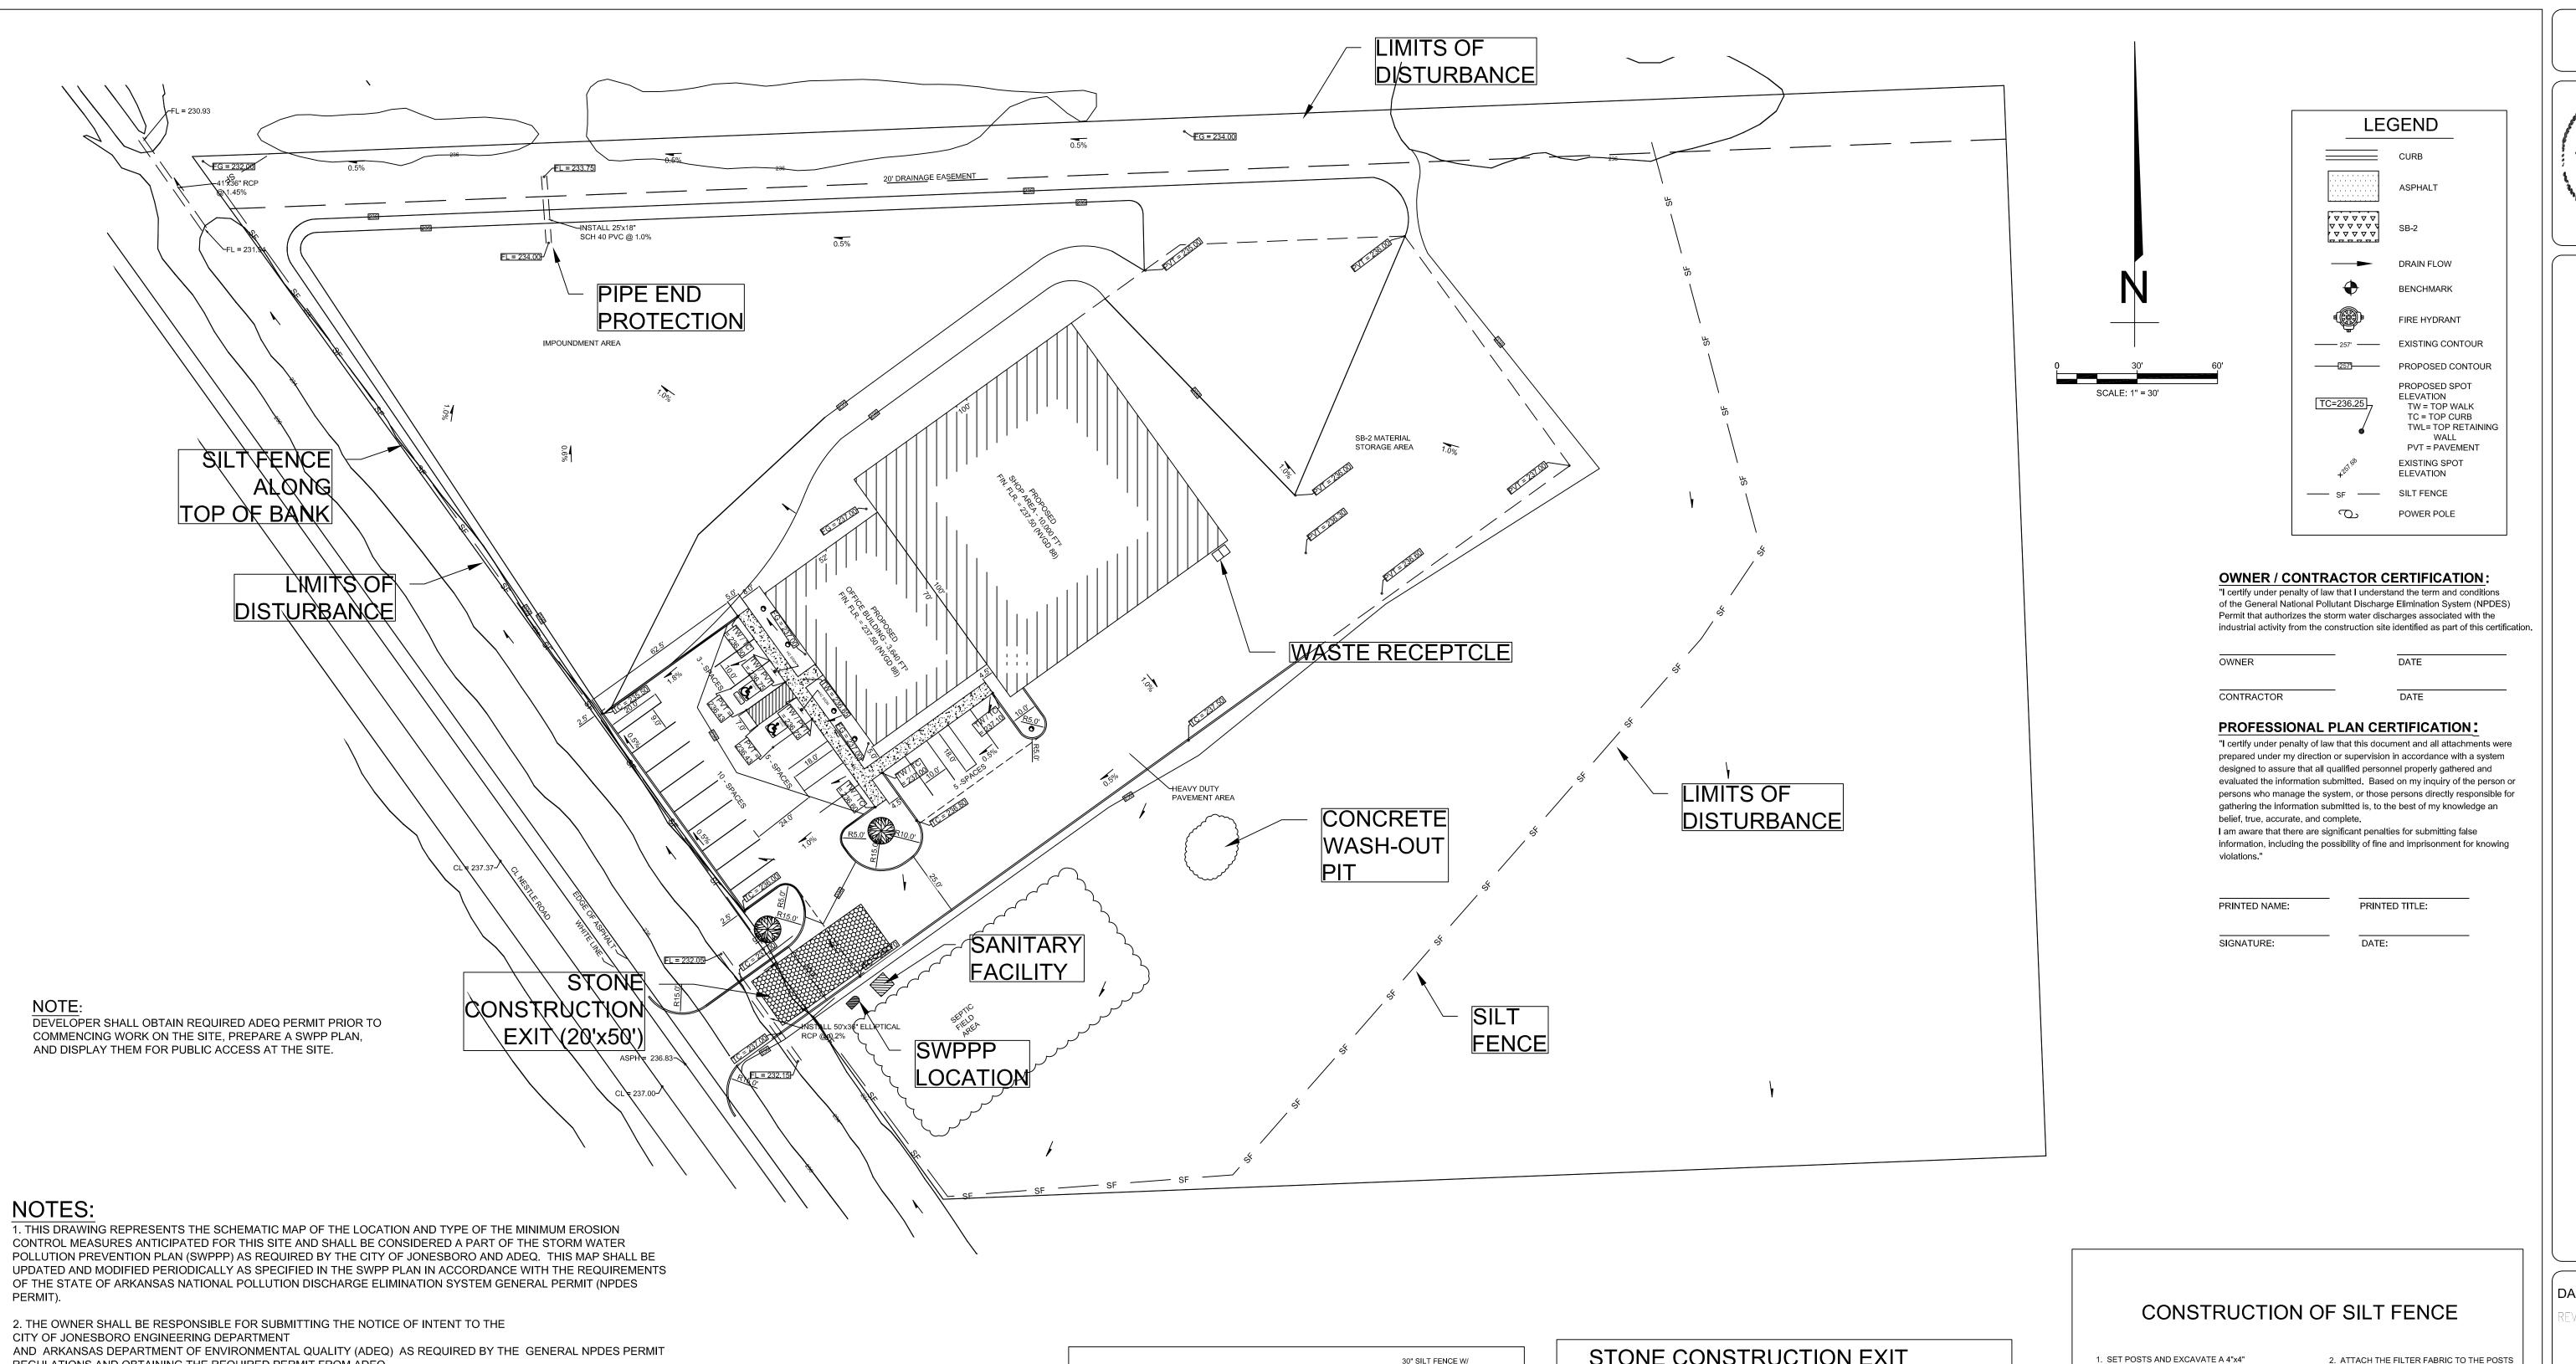

REGULATIONS AND OBTAINING THE REQUIRED PERMIT FROM ADEQ.

3. CONTRACTOR SHALL INSTALL, INSPECT, MAINTAIN, REPAIR, AND MODIFY ALL EROSION CONTROL MEASURES AND SWPP PLAN IN ACCORDANCE WITH THE GENERAL PERMIT REQUIREMENTS TO KEEP THEM IN GOOD WORKING CONDITION THROUGHOUT THE ENTIRE CONSTRUCTION PERIOD. FAILURE TO MAINTAIN COMPLIANCE MAY RESULT IN THE DENIAL OF BUILDING AND CONSTRUCTION INSPECTIONS UNTIL CORRECTIONS HAVE BEEN MADE. CONTRACTOR SHALL MAINTAIN A CONTINUOUS UPDATED SWPP PLAN AND MAP ON SITE (IN A CONTAINER MARKED AS SUCH TO IDENTIFY THE PLAN) IN A PUBLIC ACCESSIBLE LOCATION FOR REVIEW AND INSPECTION BY THE APPROPRIATE INSPECTORS.


4. SILT FENCE & OTHER EROSION CONTROL DEVICES SHALL BE INSTALLED (AS SHOWN ON THE MAP) TO PREVENT MIGRATION OF SEDIMENT TO ADJACENT PROPERTIES & ALONG TOP OF DITCH BANK TO ENSURE THAT THE EXISTING DITCHES ARE NOT CONTAMINATED WITH SEDIMENT DURING CONSTRUCTION. ADDITIONAL LOCATIONS MAY BE NECESSARY AS CONSTRUCTION PROGRESSES. AREAS DISTURBED BY CONSTRUCTION SHALL BE TEMPORARILY SEEDED IN AREAS WHERE CONSTRUCTION CEASES FOR 14 DAYS AND PERMENENTLY SEEDED WITHIN 14 DAYS OF THE COMPLETION OF CONSTRUCTION. THE LOCAL SOIL CONSERVATON SERVICE CAN BE CONTACTED FOR ASSISTANCE.

5. CONTRACTOR SHALL INSTALL A STONE CONSTRUCTION EXIT (PRIOR TO CONSTRUCTION) AT THE LOCATIONS CONSTRUCTION VECHIICLES LEAVE THE SITE TO PREVENT DUST AND MUD TRACKING ONTO STREETS. CONTRACTOR SHALL CLEAN ALL TRACKING MATERIALS FROM STREETS AS FREQUENTLY AS NECESSARY TO MAINTAIN CLEAN STREETS AND AT A MINIMUM OF THE END OF THE DAY.


6. AN INSPECTION SHALL BE MADE WEEKLY. ALL OBSERVED DEFICIENCIES OF THE BEST MANAGEMENT PRACTICES (BMPs) WILL BE RECORDED AND REPAIRED AS SOON AS POSSIBLE.

7. SEDIMENT SHALL BE REMOVED FROM ALL EROSION CONTROL DEVICES WHEN SEDIMENT REACHES 50% OF THE DEVICE CAPACITY.

- 8. A SOLID WASTE CONTAINER SHALL BE PROVIDED FOR SOLID WASTE REMOVAL.
- 9. A TEMPORARY SANITARY SEWER CONTAINER SHALL BE PROVIDED.
- 10. A CONCRETE WASTE PIT SHALL BE PROVIDED AS NEEDED DURING THE CONSTRUCTION OF THE SITE.

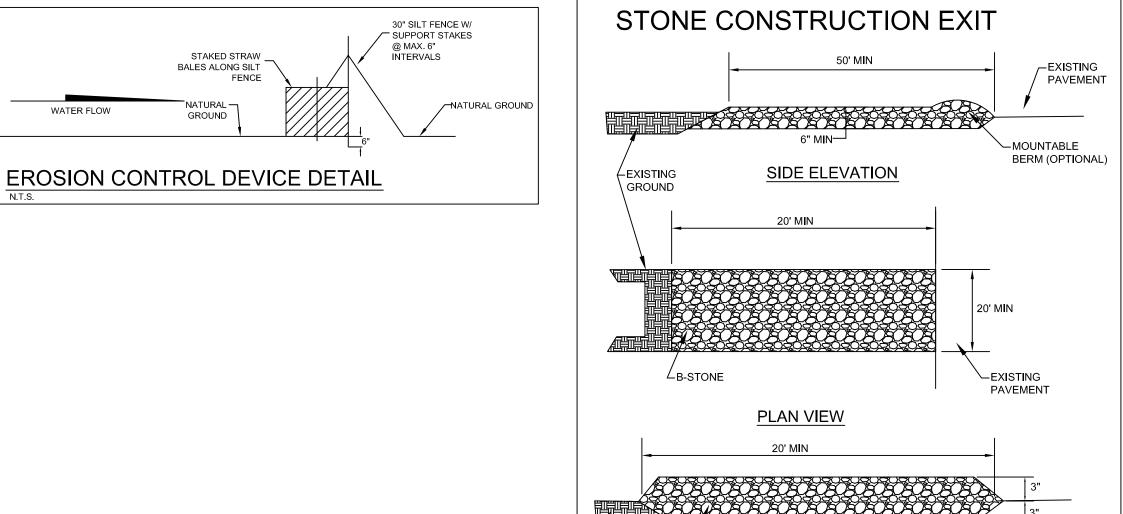

∠EXISTING

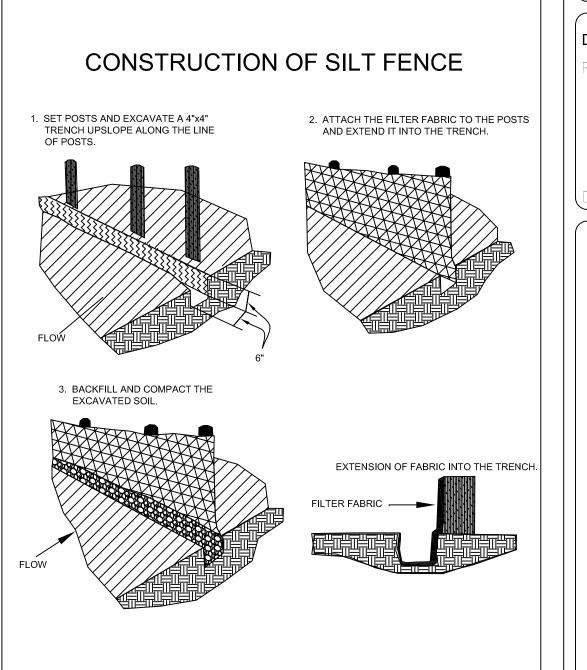

ECM-1

ARKANSAS REGISTERED PROFESSIONAL ENGINEER No. 5620 0

EROSION

DATE: 3/29/10

DRAWN BY: BGW

