
## SITE DEVELOPMENT PLANS

# EMERALD VILLAGE

LYING IN SECTION 7, TOWNSHIP 14 NORTH, RANGE 4 EAST, CRAIGHEAD COUNTY, JONESBORO, ARKANSAS FEBRUARY, 2016

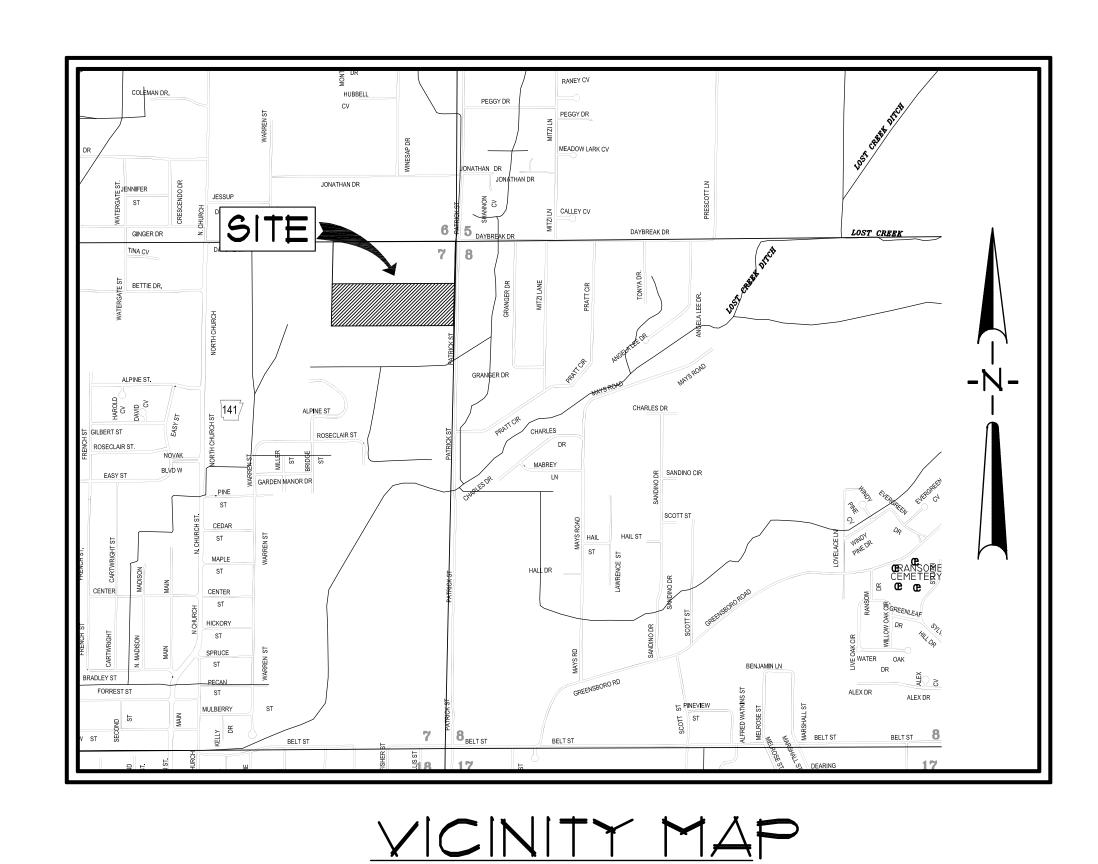

#### INDEX TO SHEETS

INDEX SHEET AREA MAP TOPOGRAPHIC MAP RECORD PLAT SITE PLAN UTILITY PLAN DRAINAGE PLAN EROSION CONTROL PLAN STREET PROFILES STANDARD DETAILS EROSION CONTROL DETAILS








ASSOCIATED ENGINEERING AND TESTING, LLC CIVIL ENGINEERING AND LAND SURVEYING SERVICES 103 SOUTH CHURCH STREET - P.O. BOX 1462 - JONESBORO, AR 72403 PH: 870-932-3594 FAX: 870-935-1263


> INDEX SHEET EMERALD YILLAGE KWL PROPERTIES, LLC


REVISED SANITARY SEWER ALIGNMENT PER CWL 1 04/05/16 REY DATE REVISIONS


JME JME **DRAWN**: CCH DRAWN CHK'D SCALE: 1" = 1000' CADD FILE;5100-5DP-EV DWG. 0414071.0004


JONESBORO, ARKANSAS

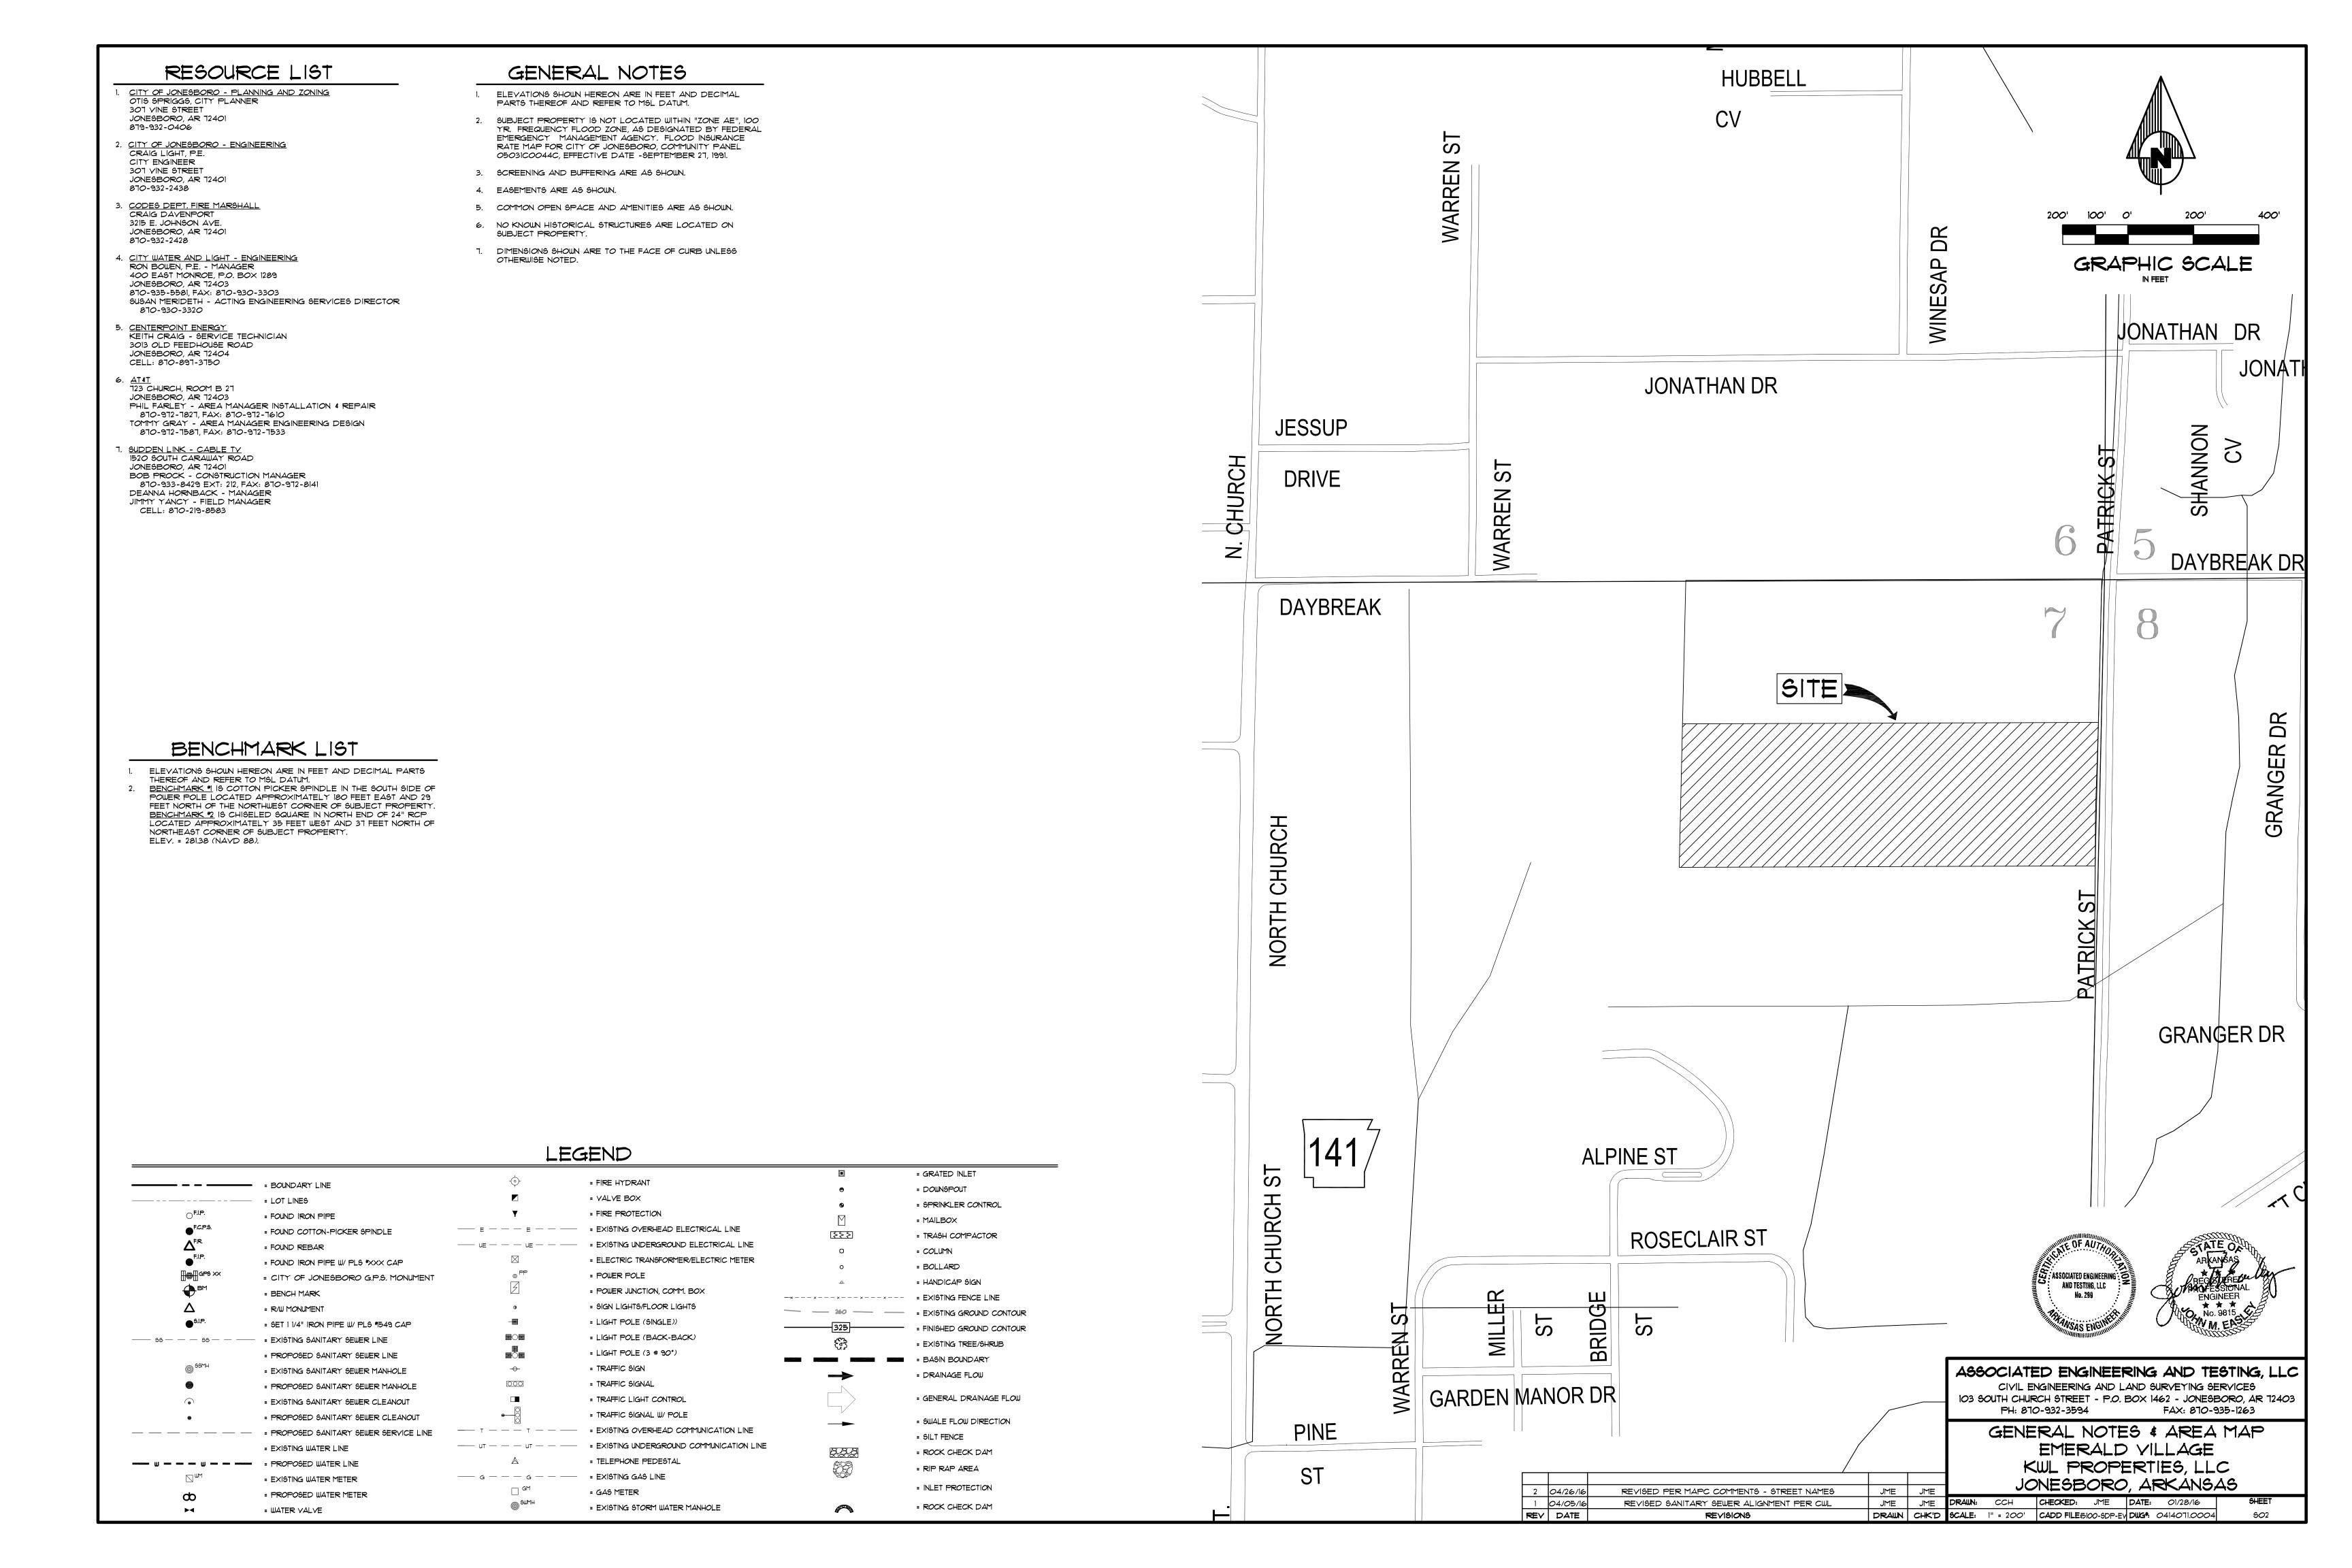


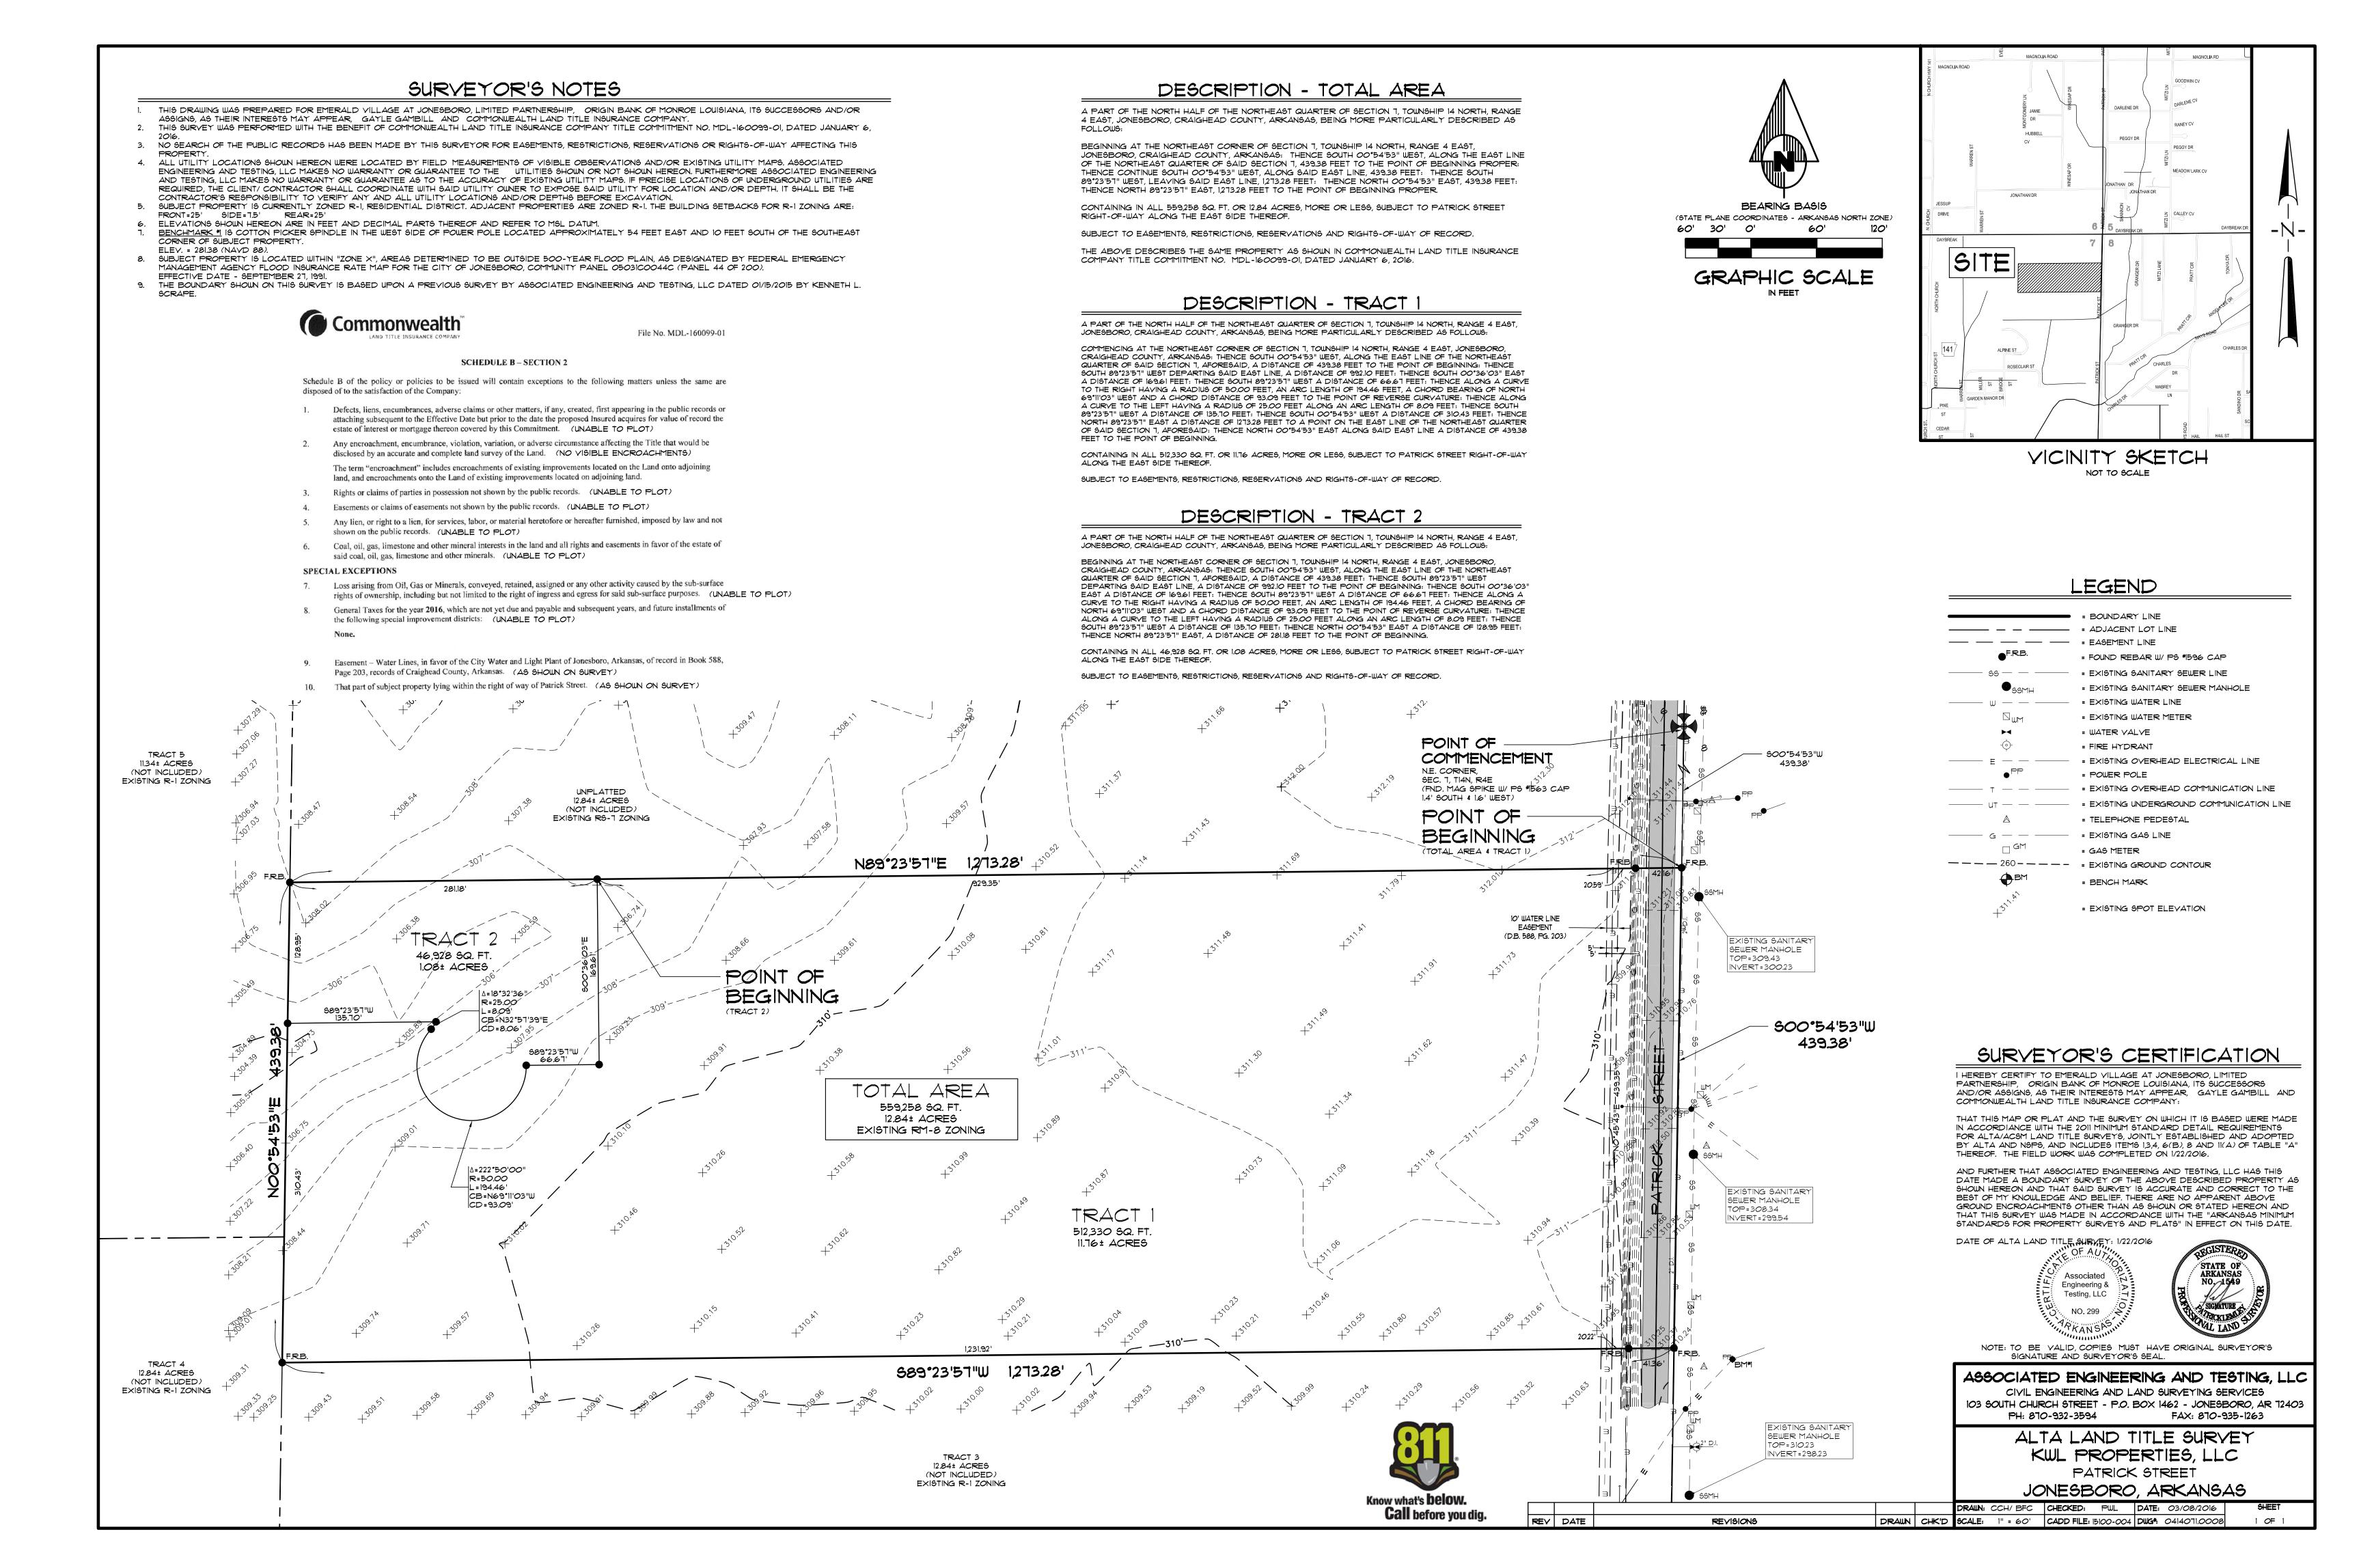


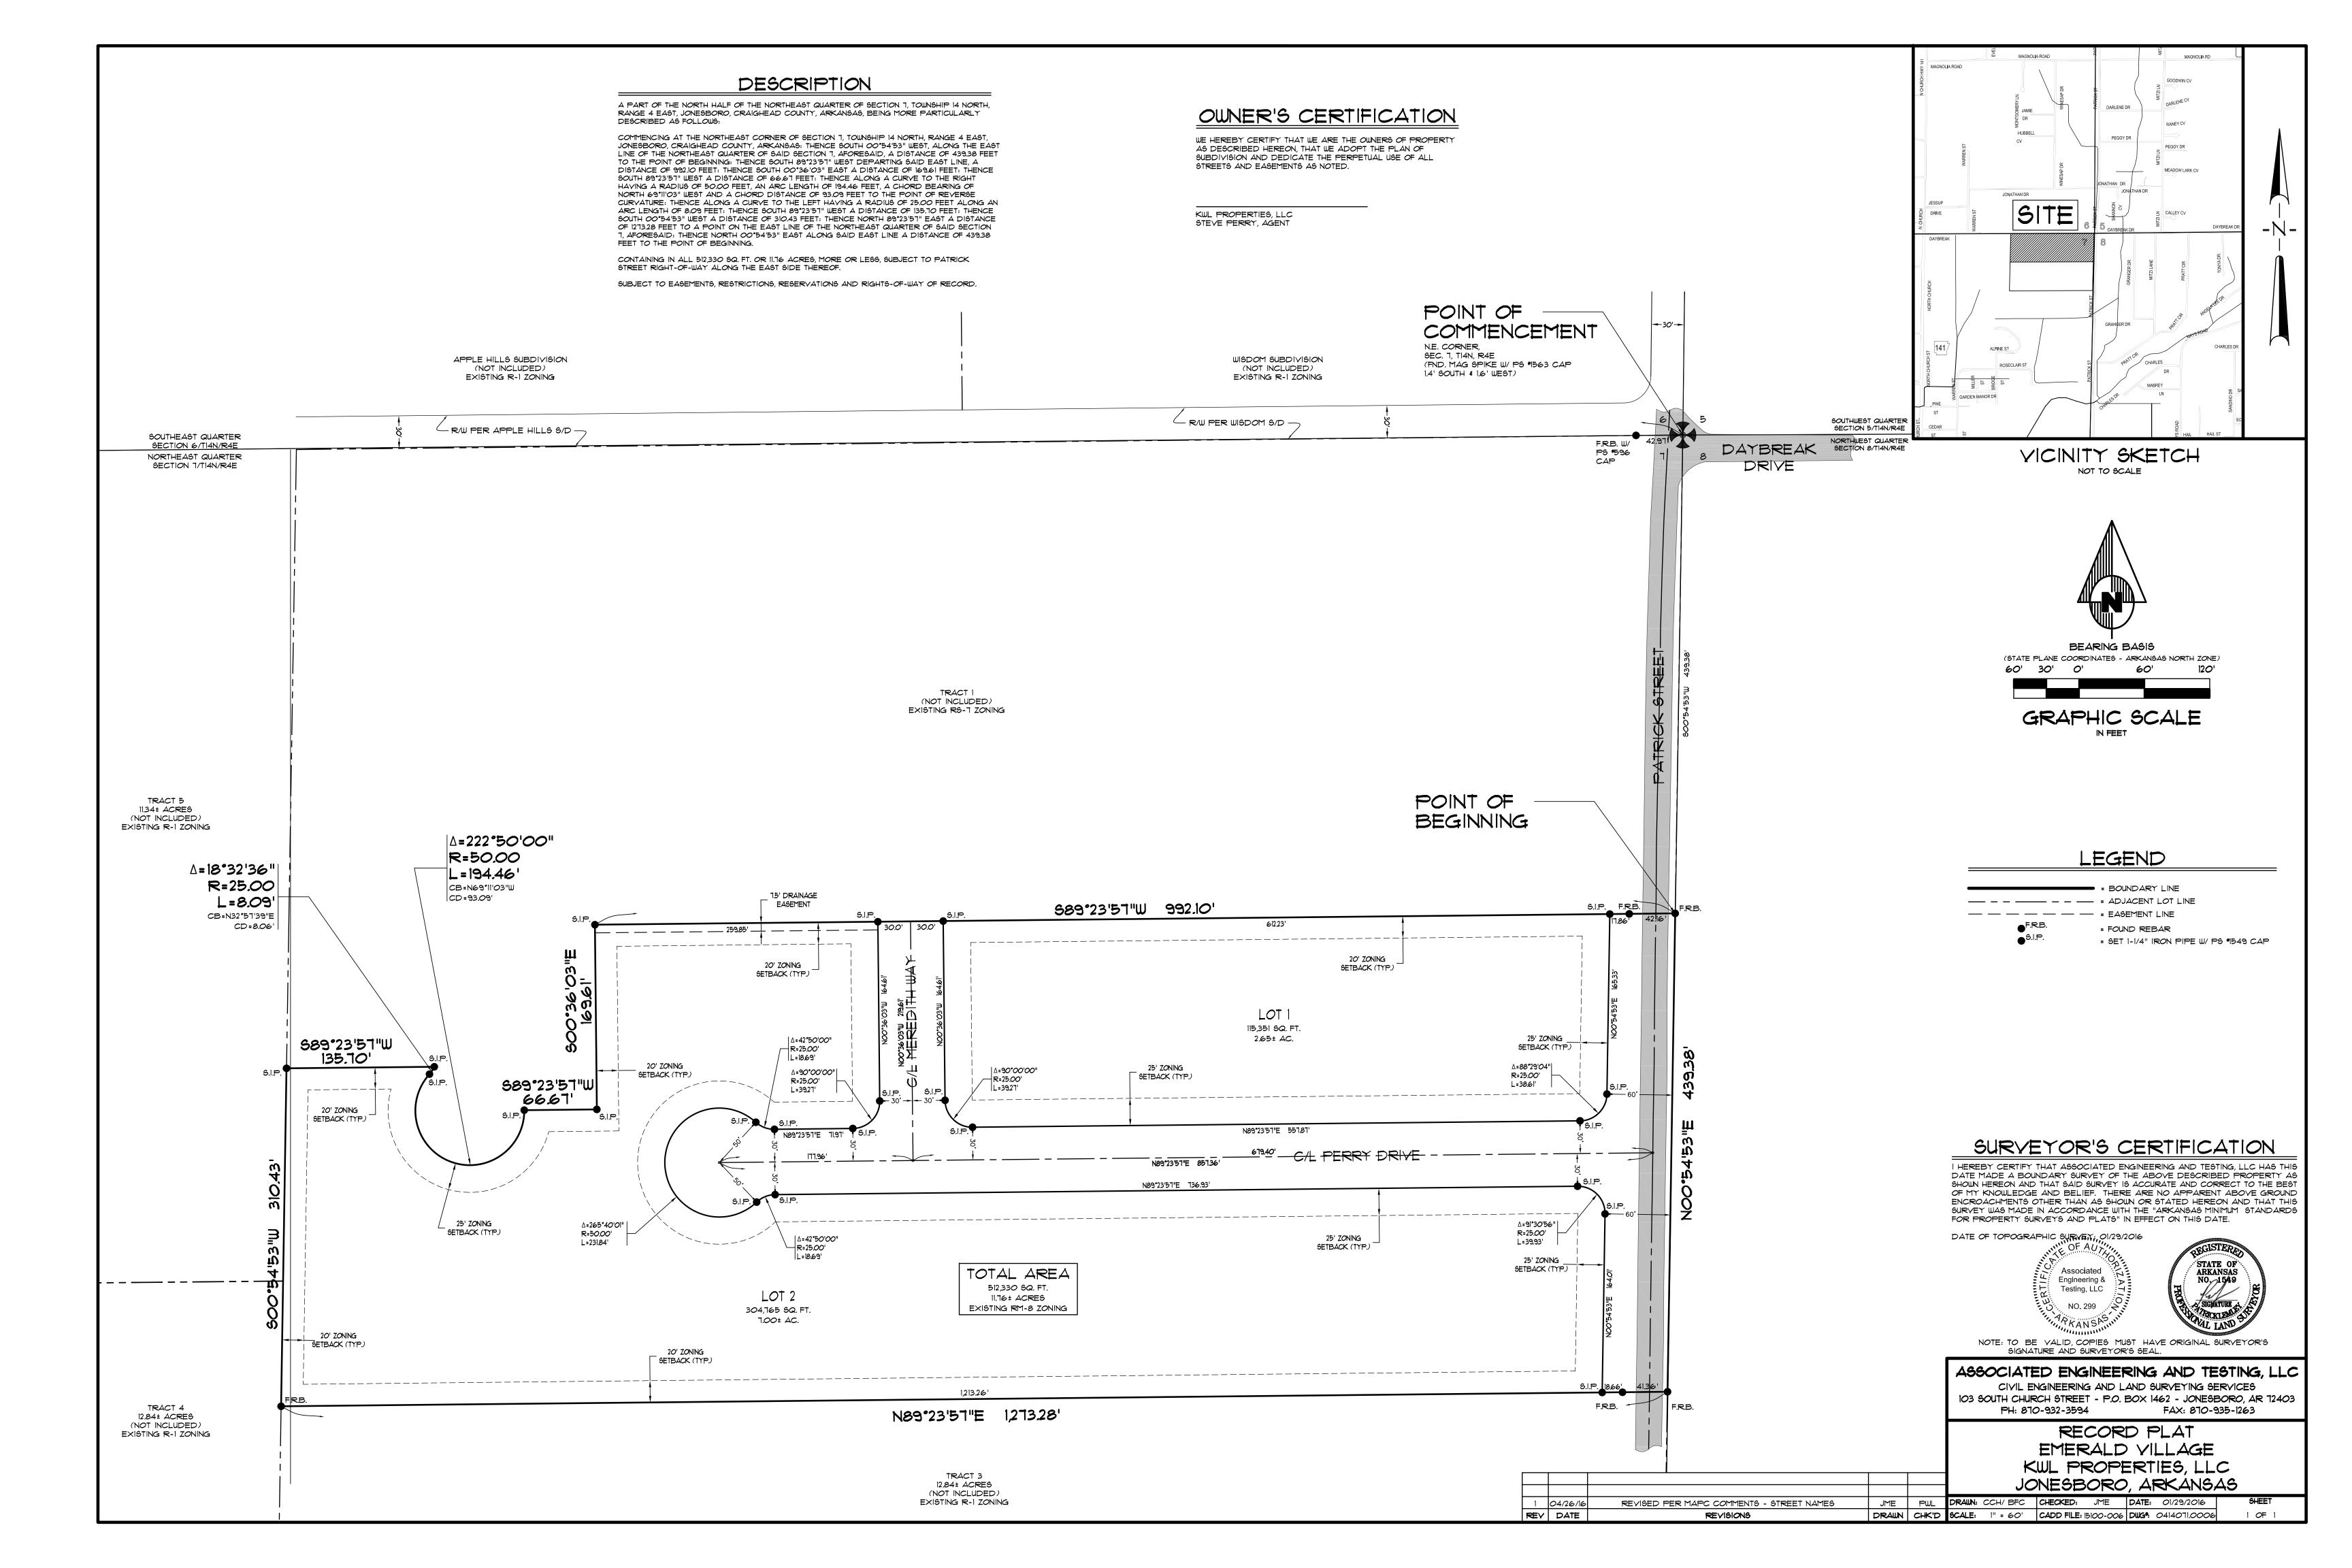


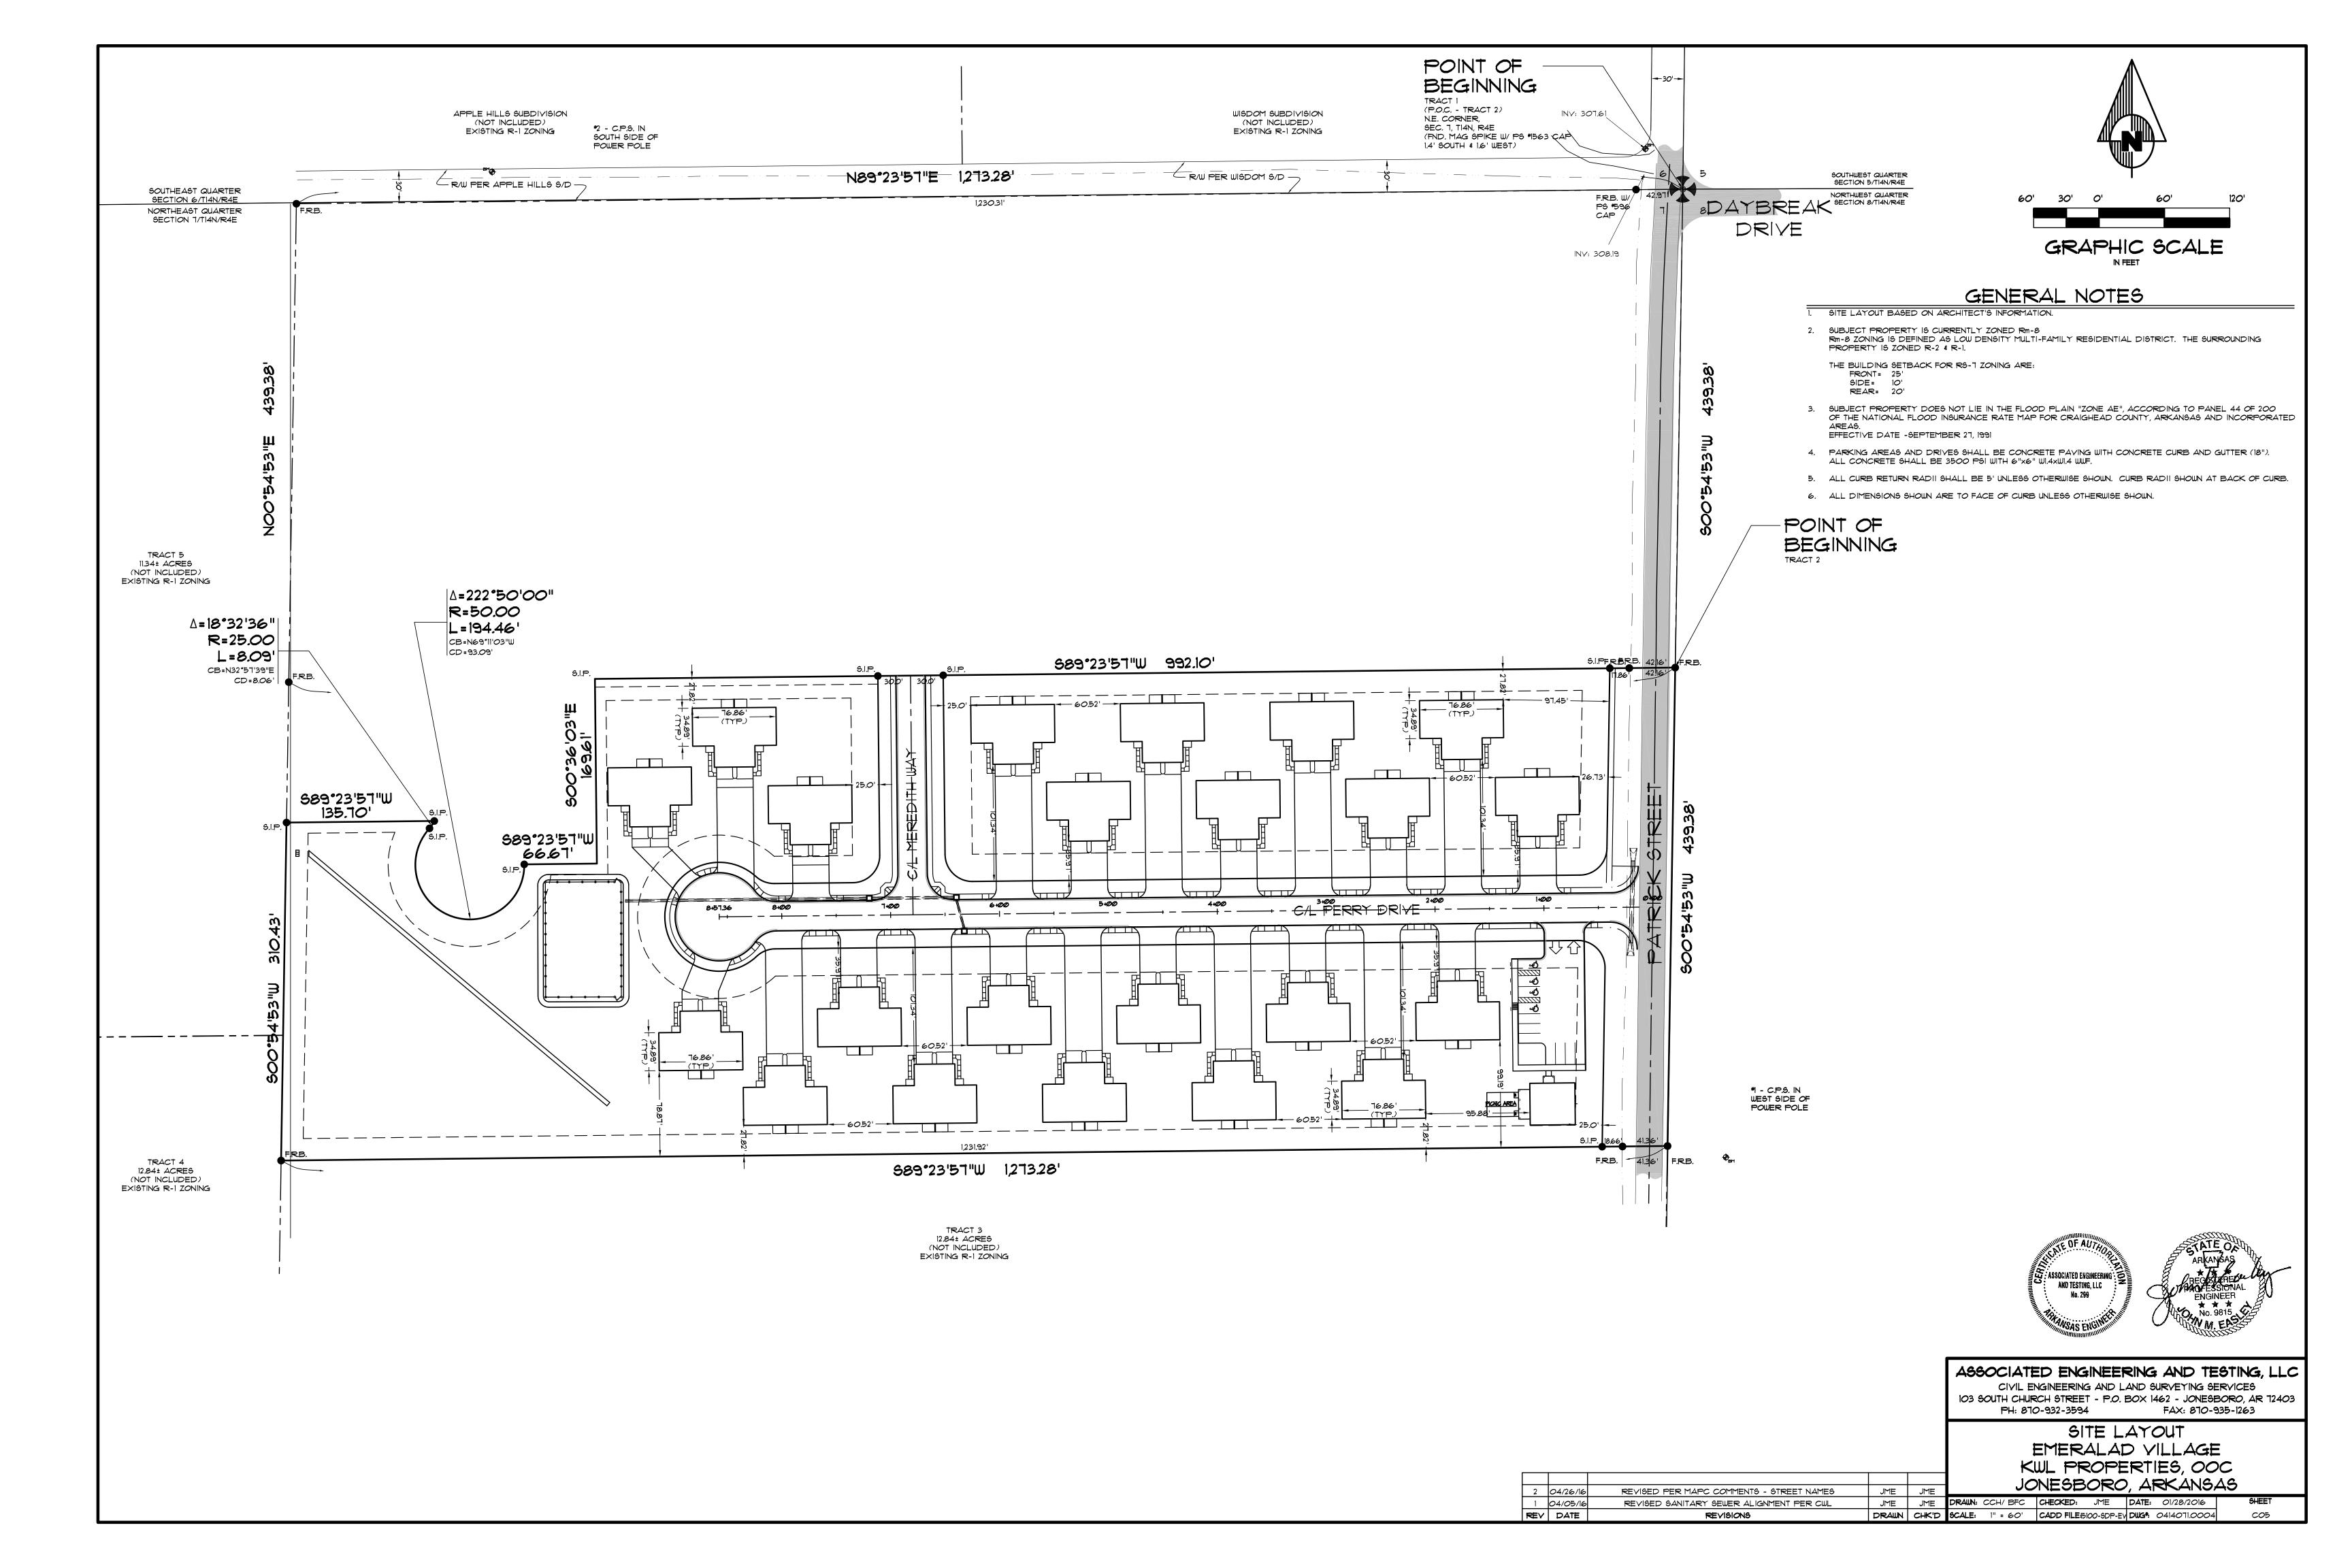


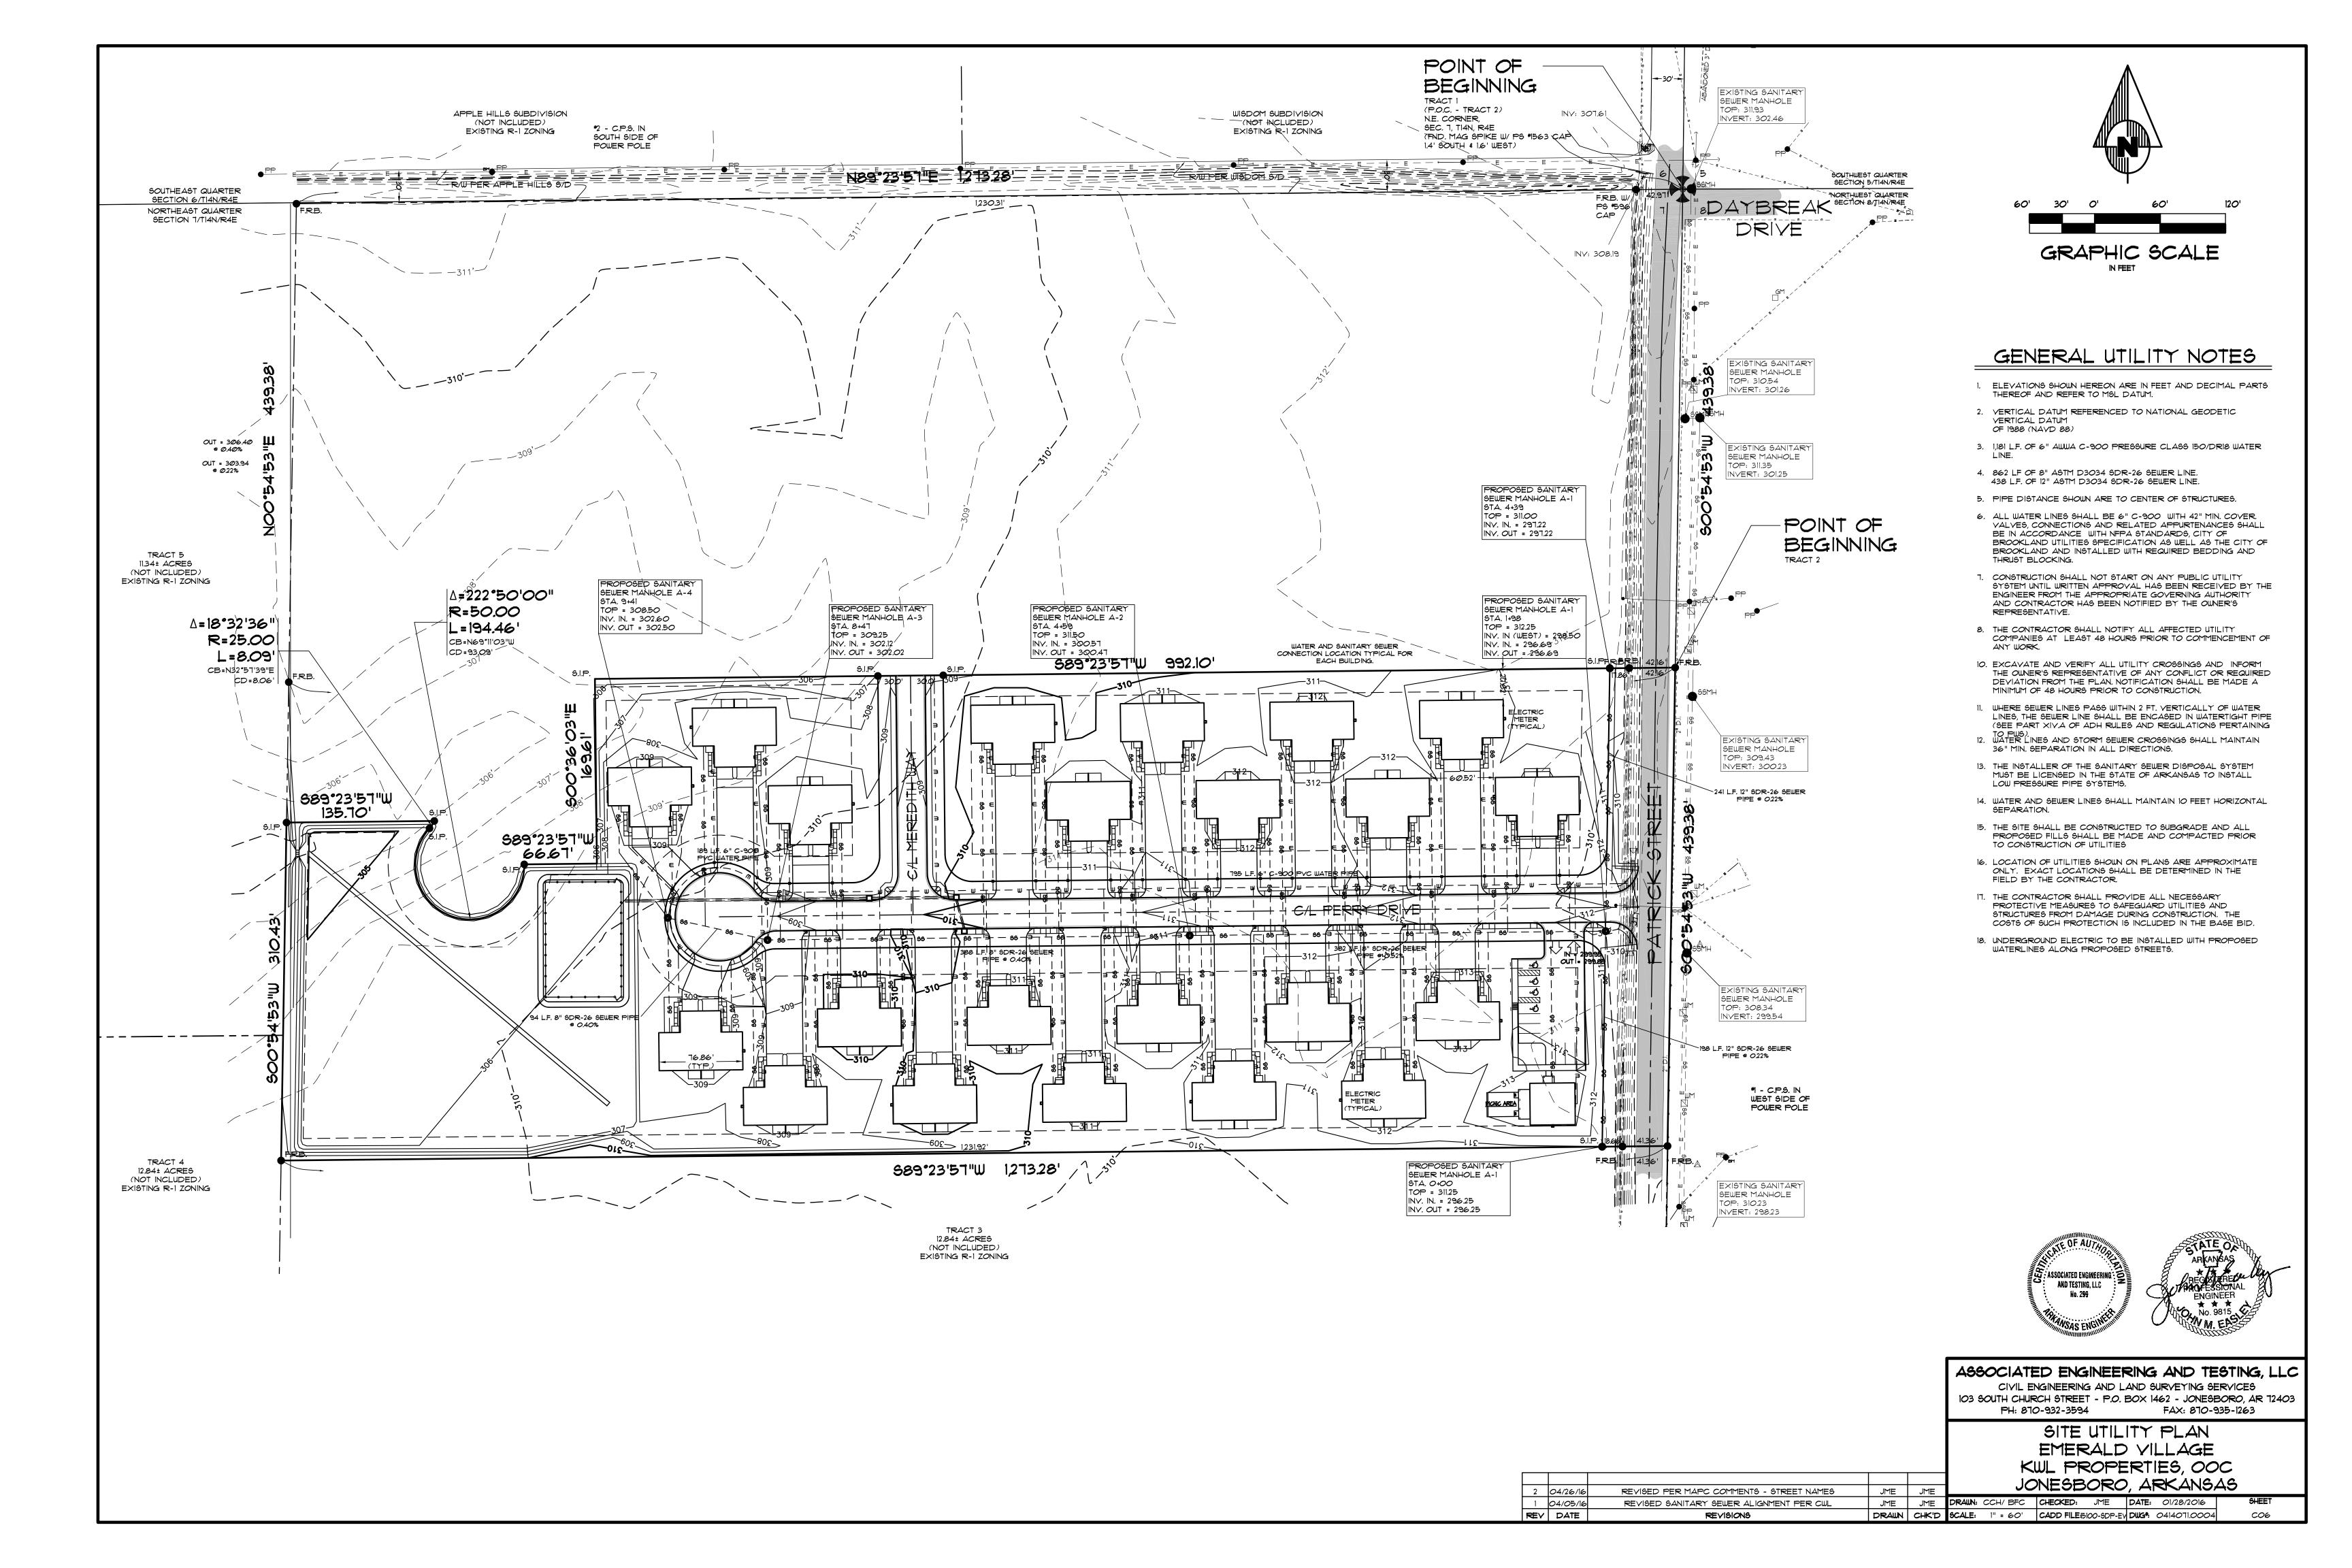

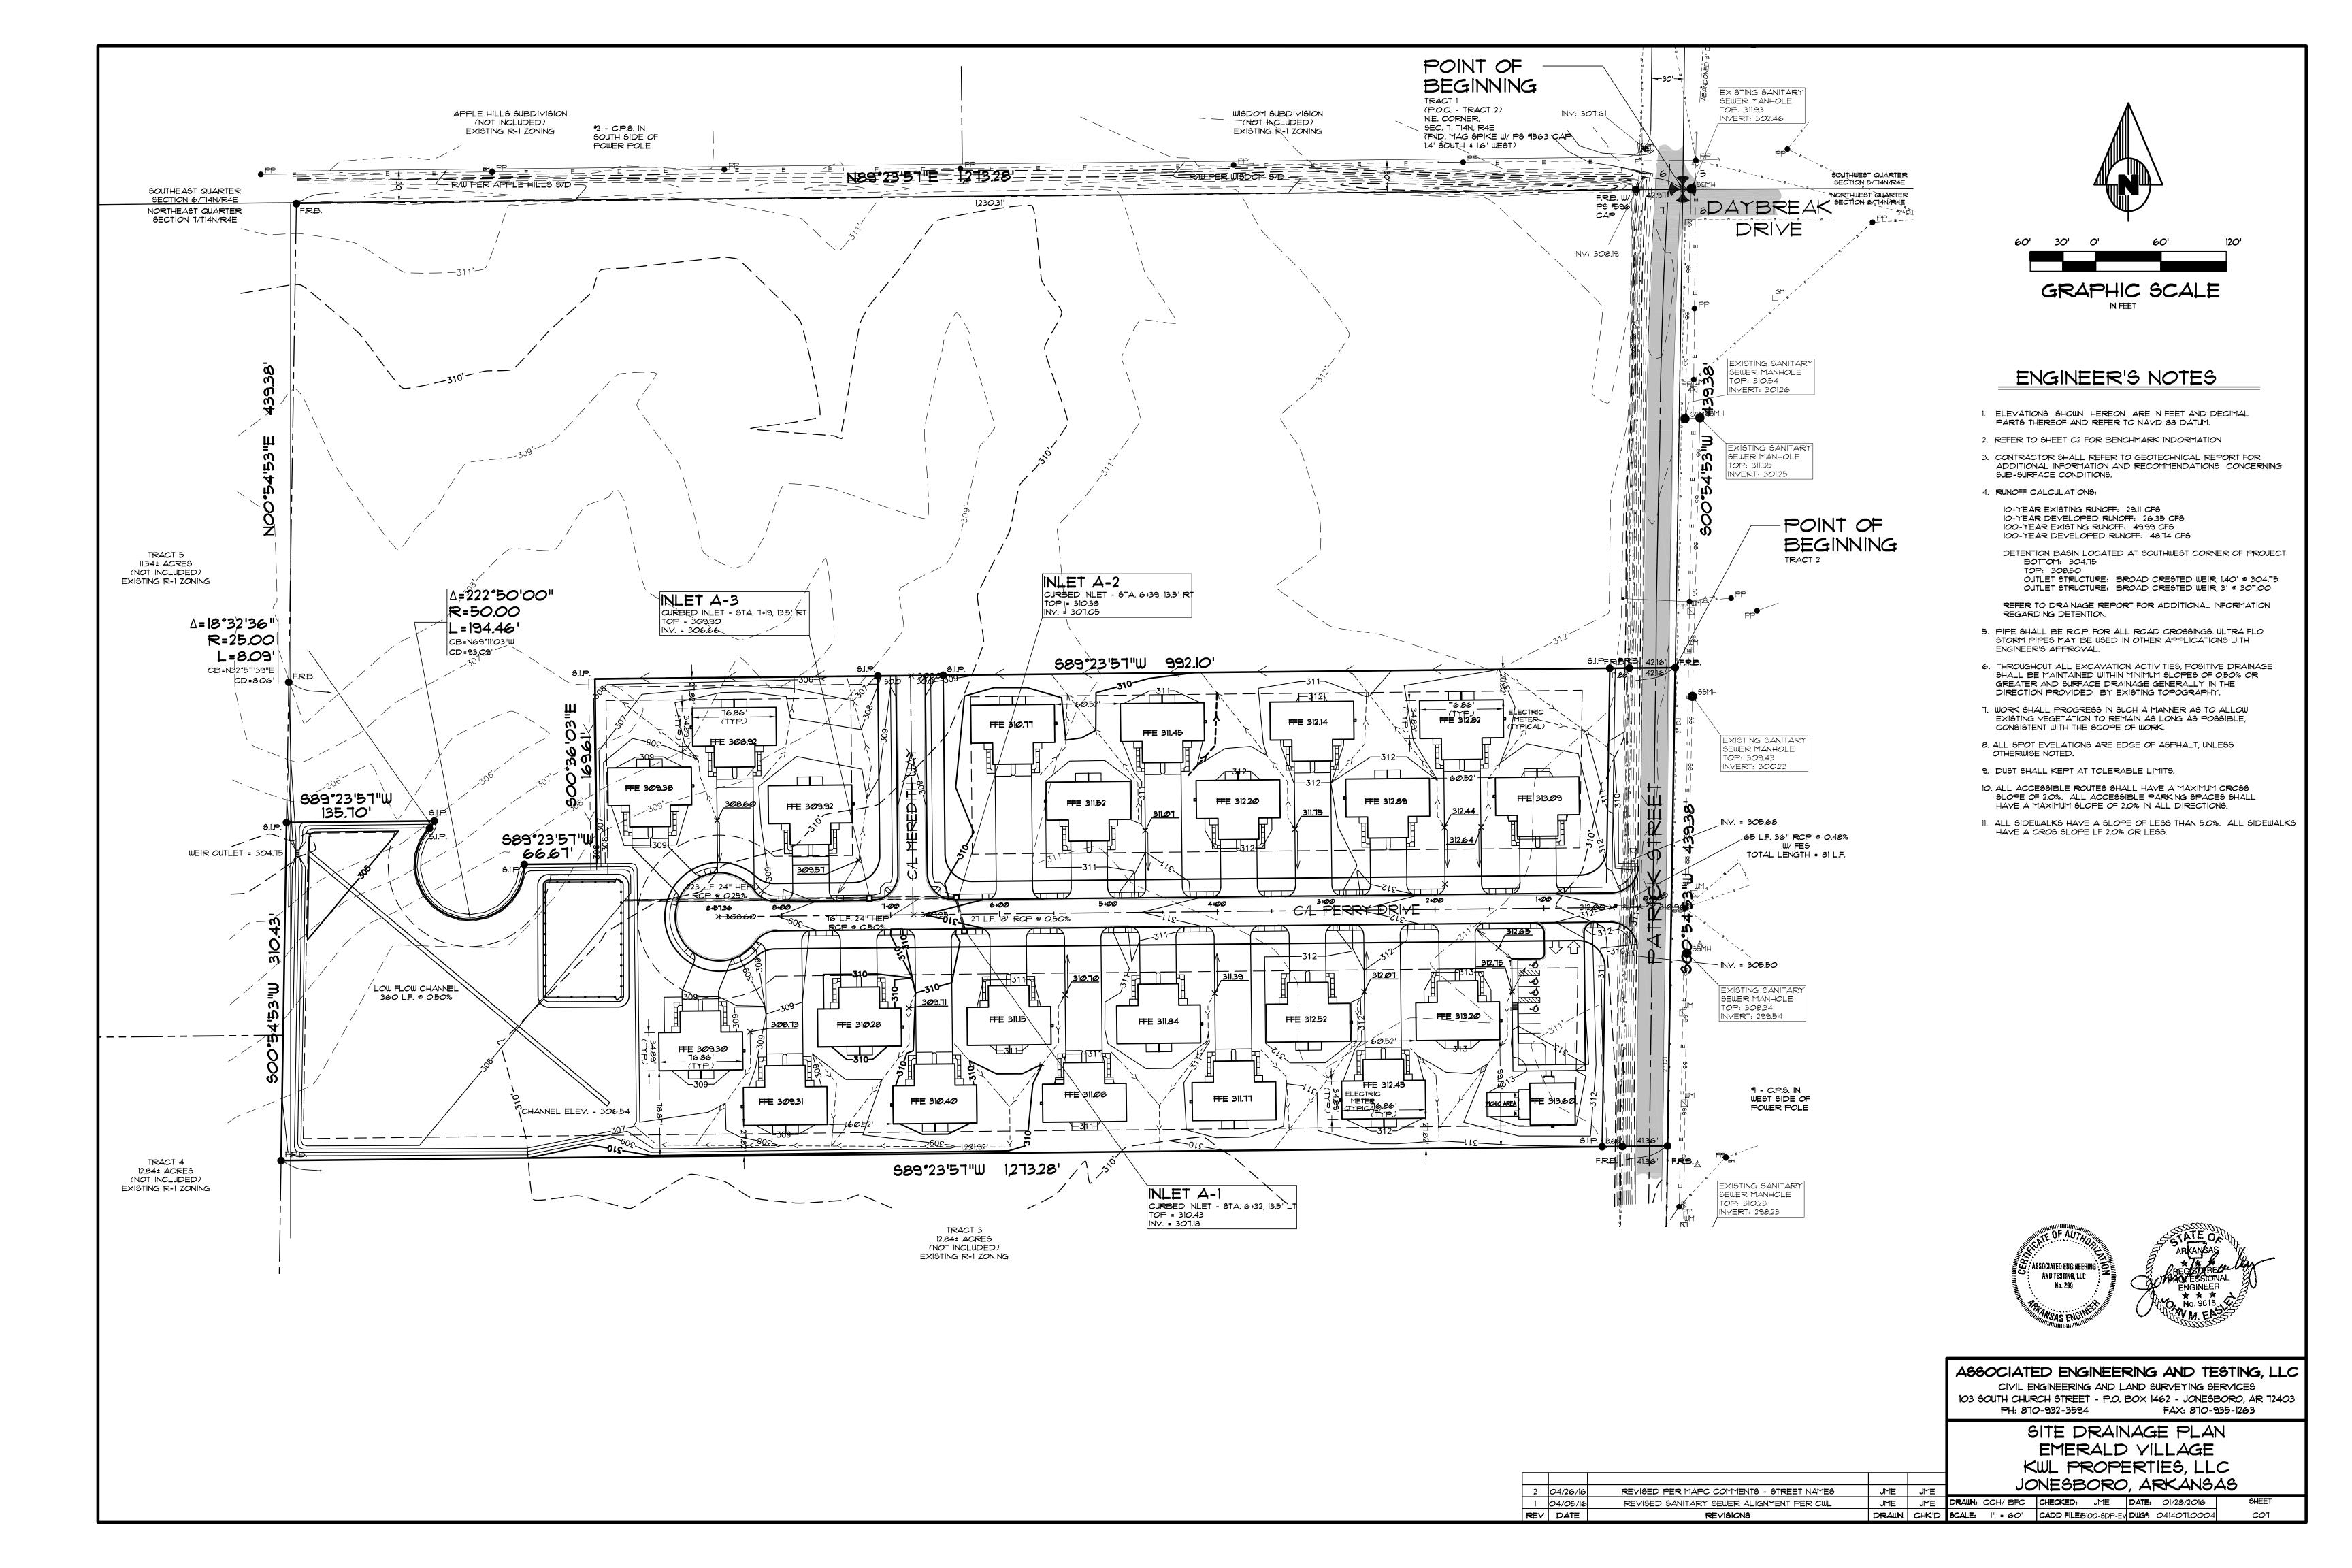


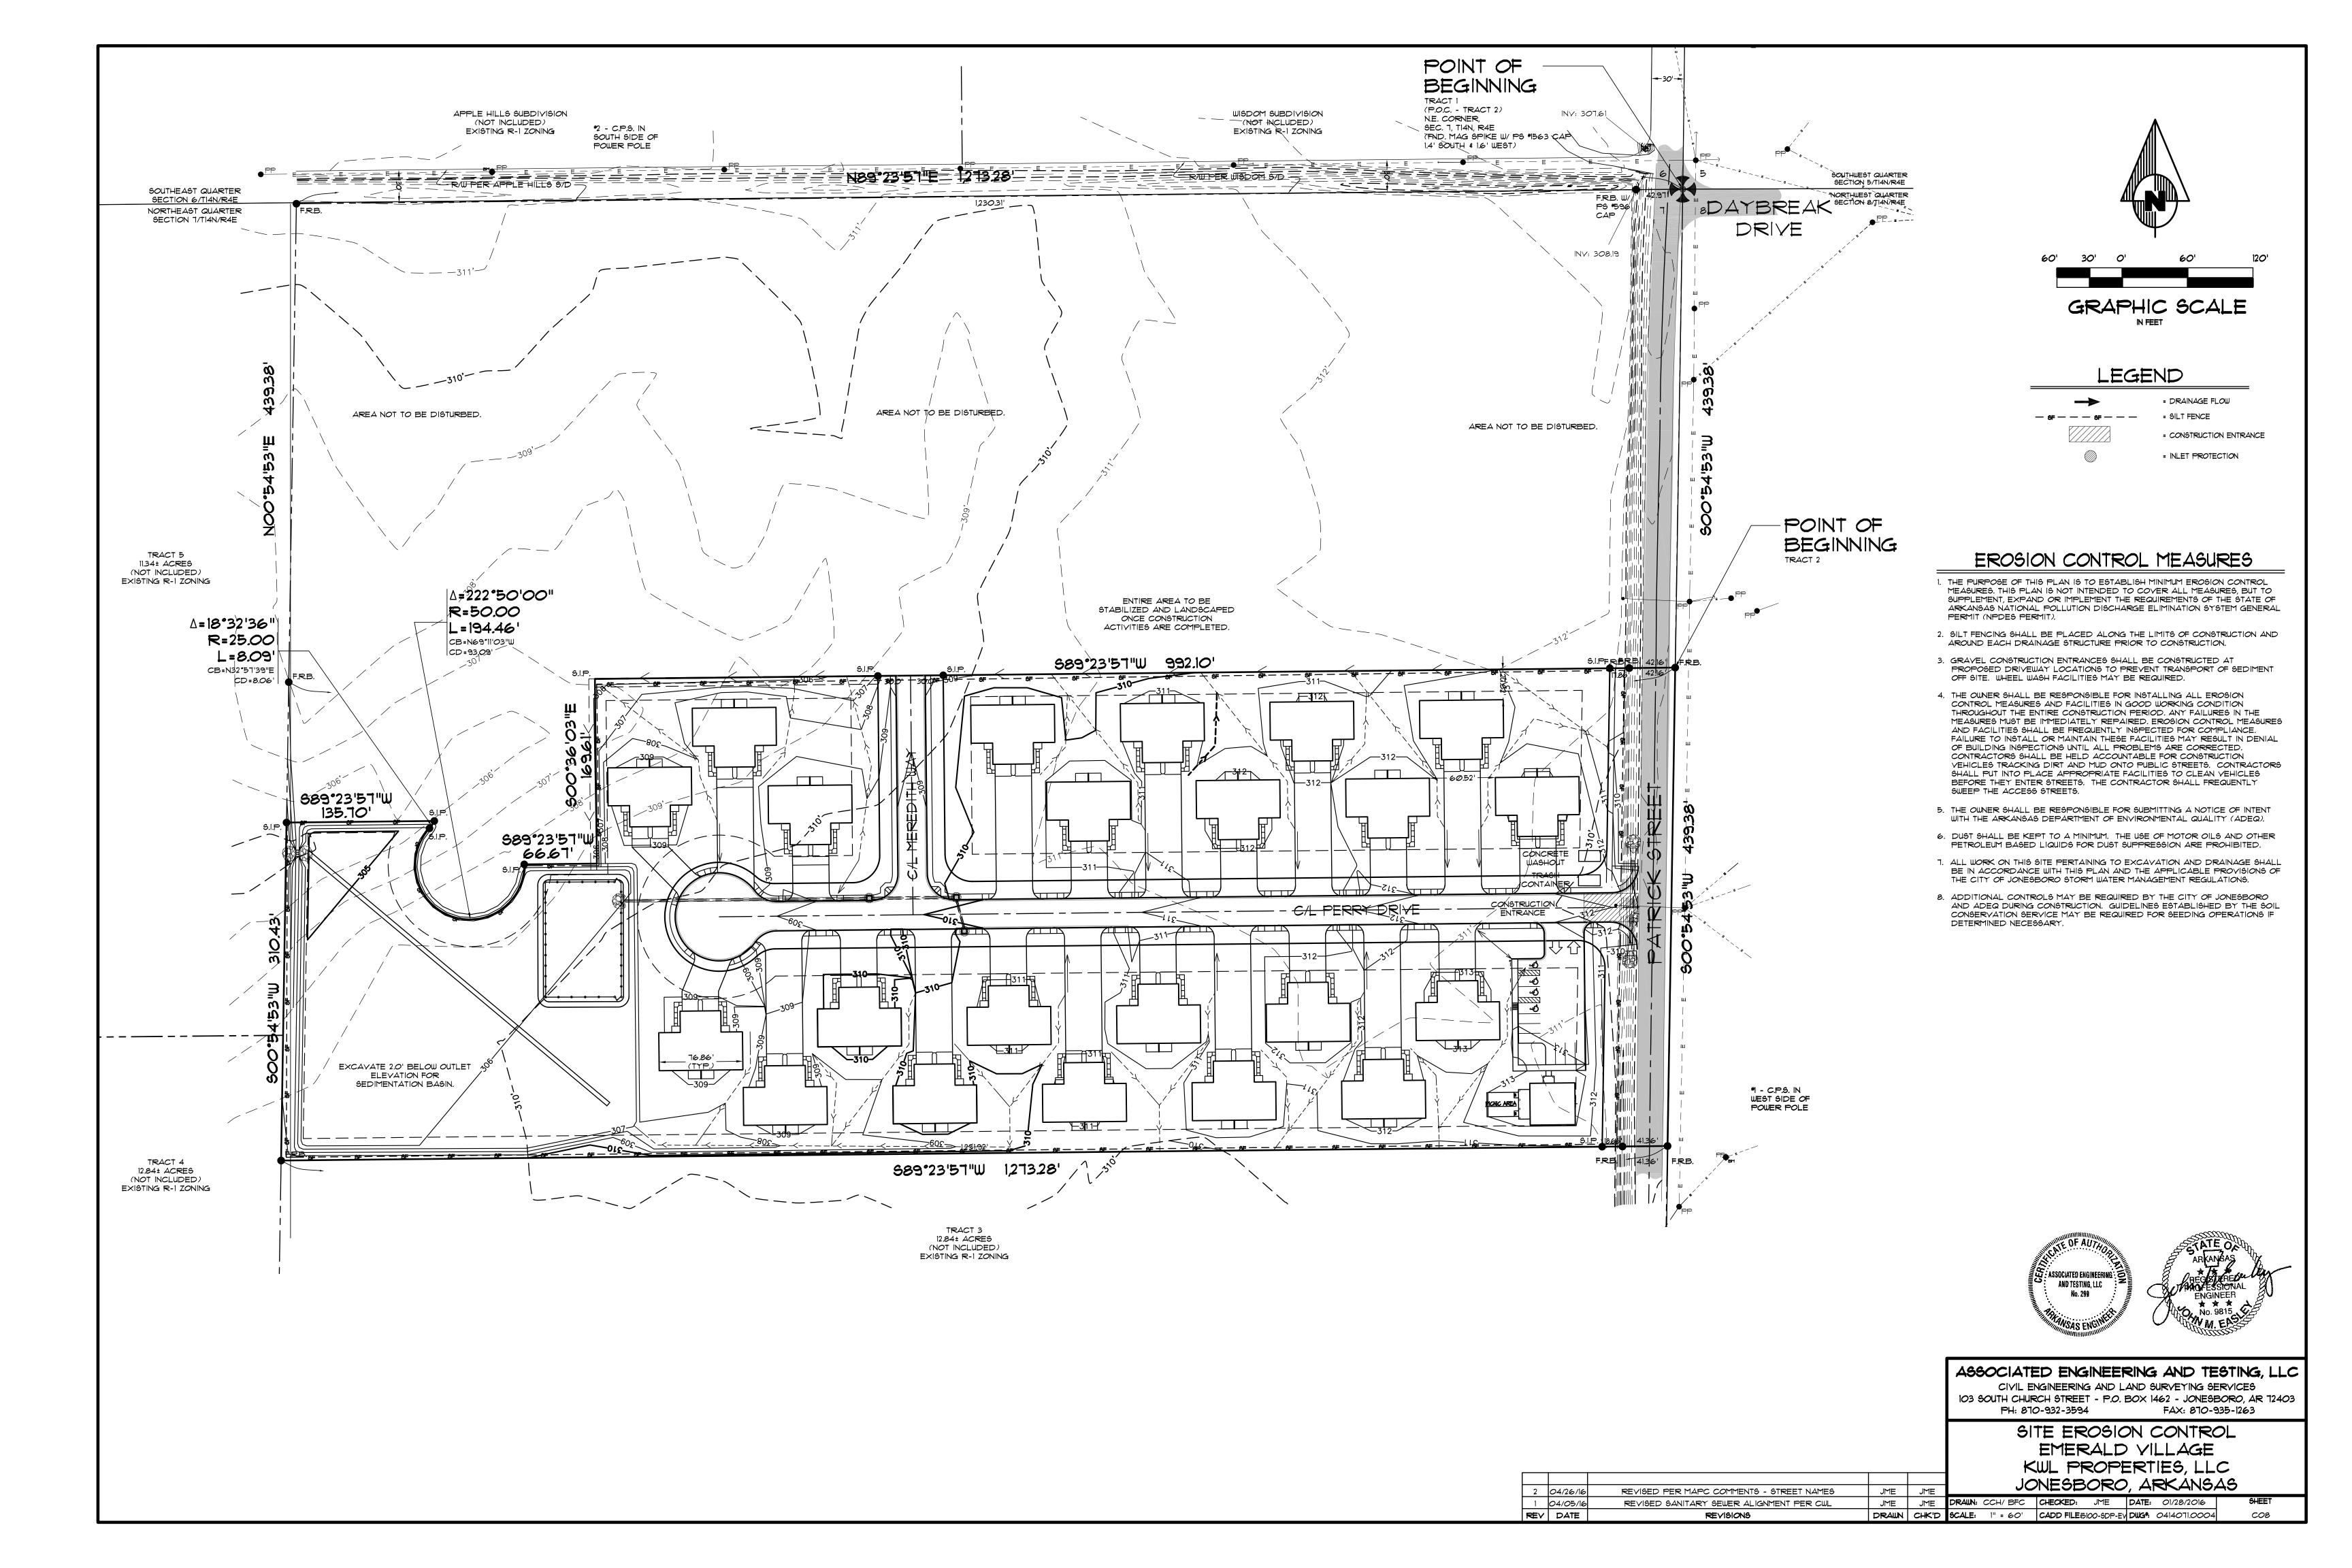

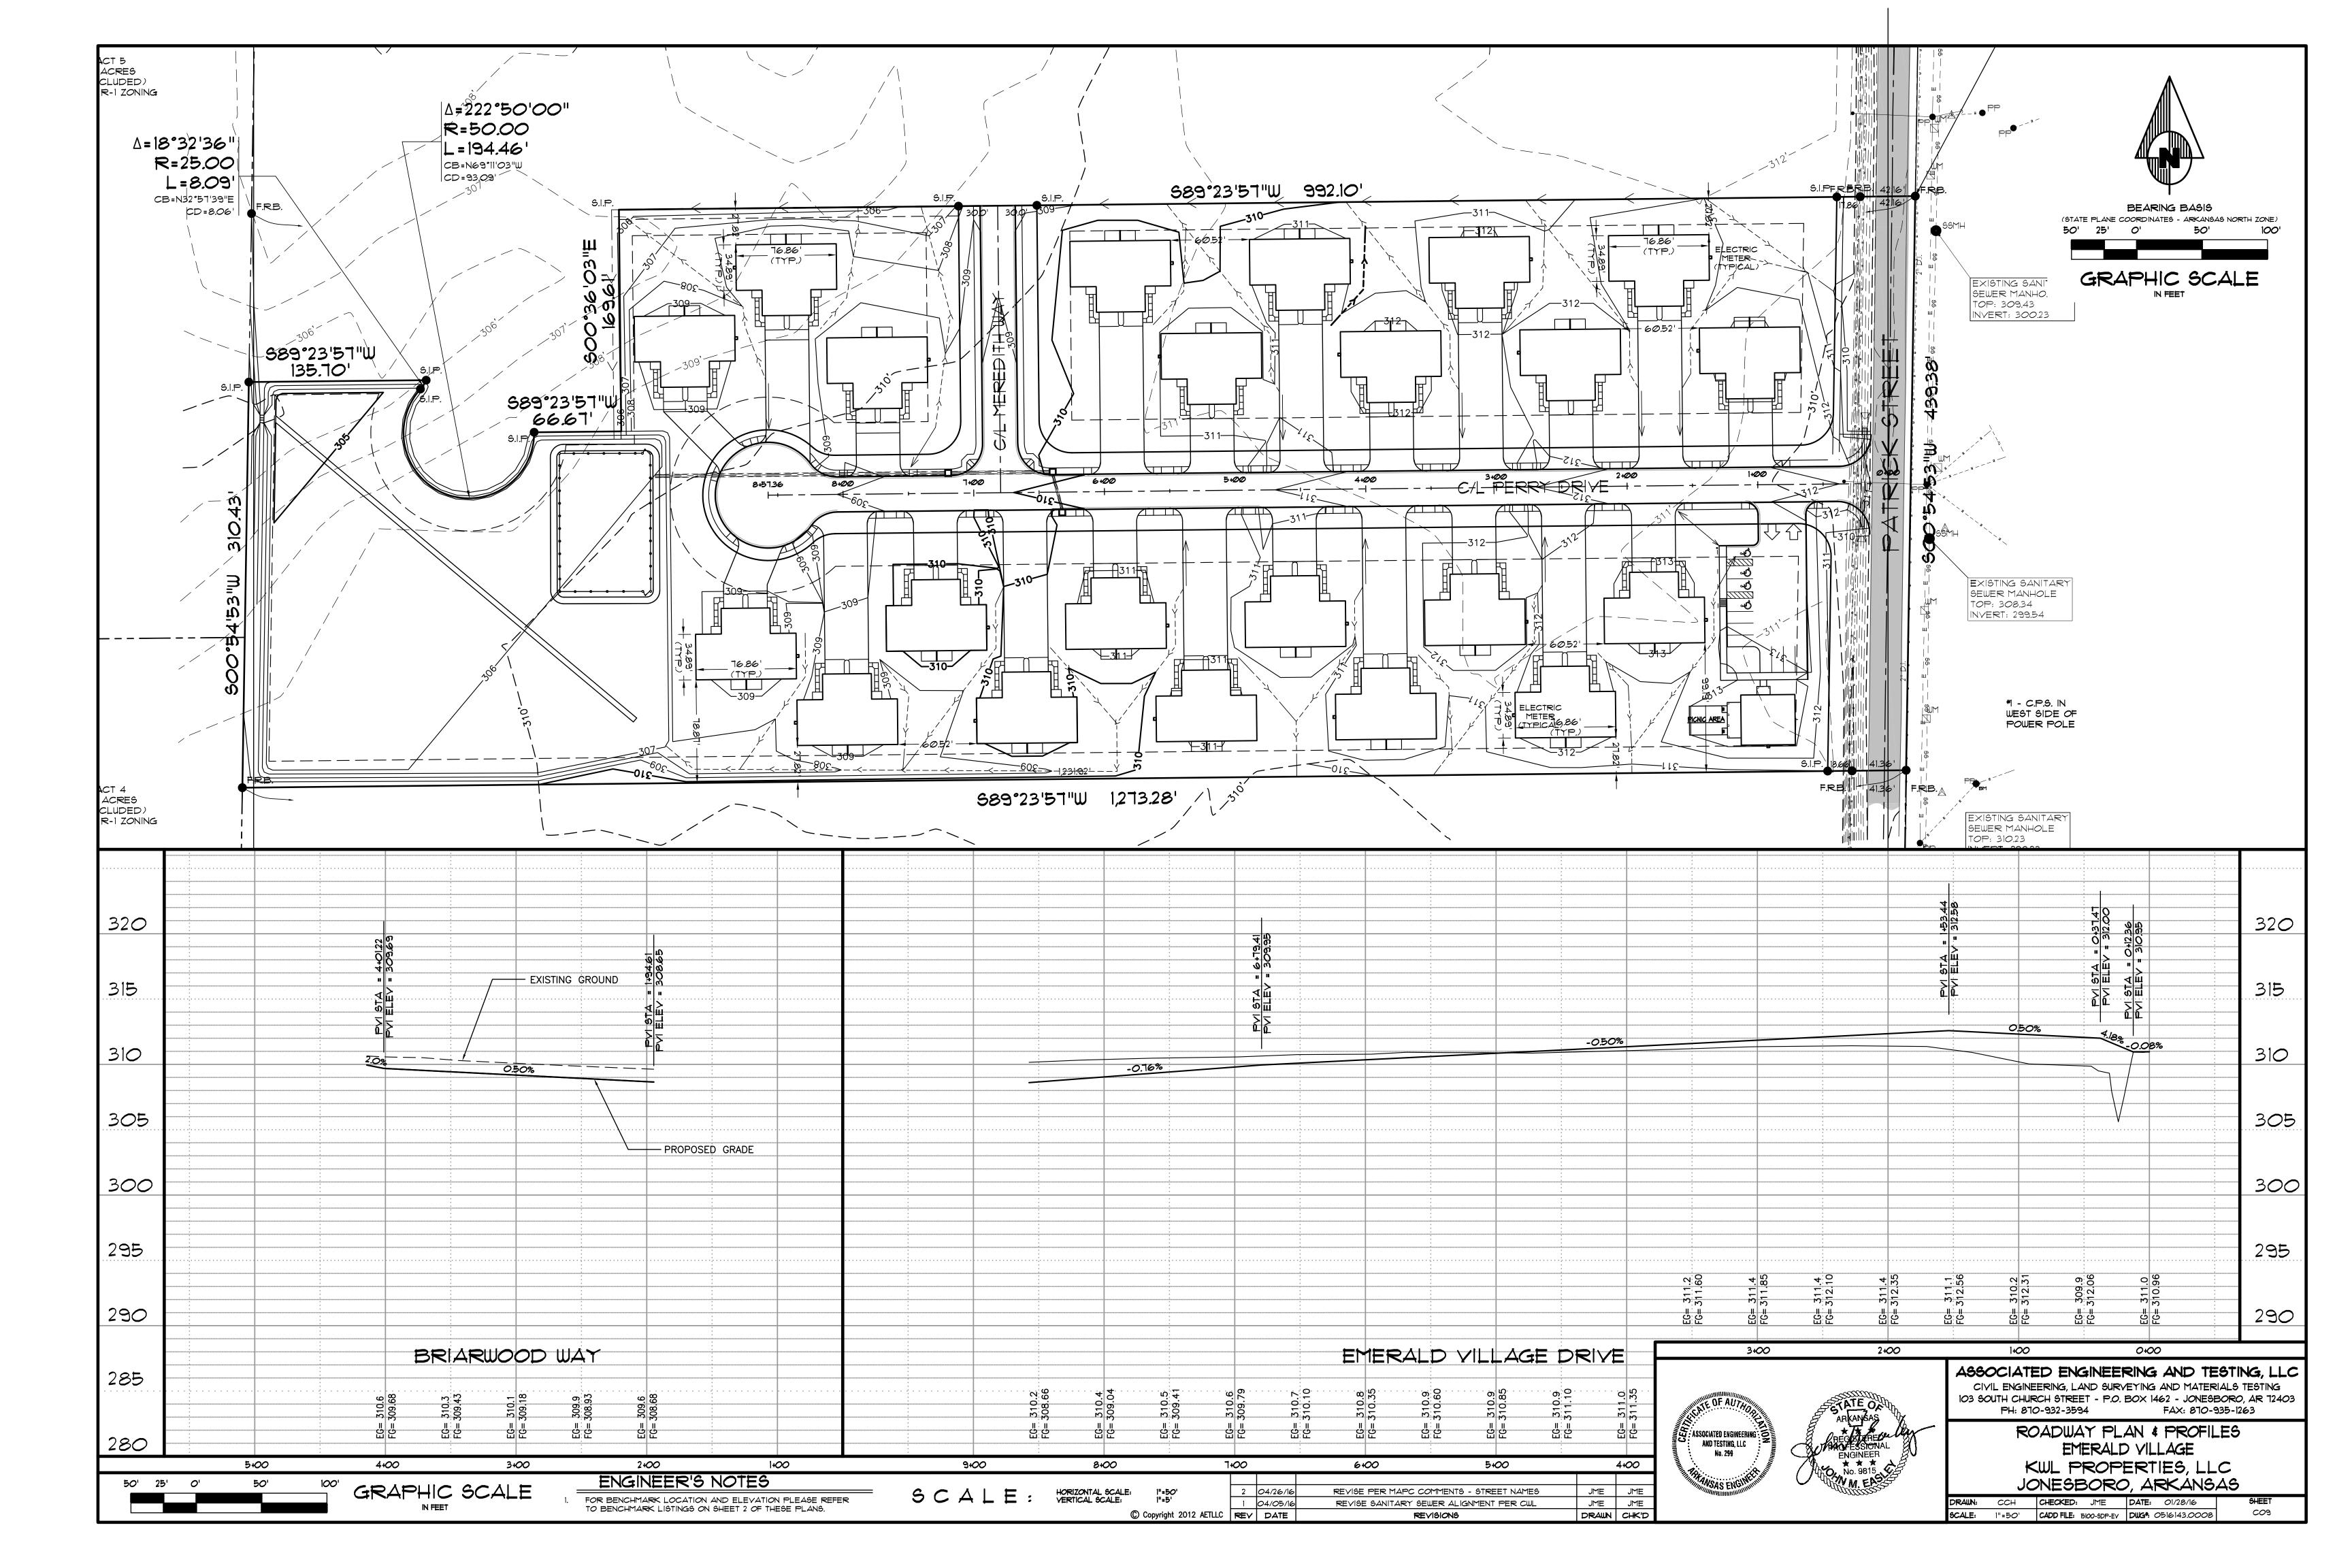

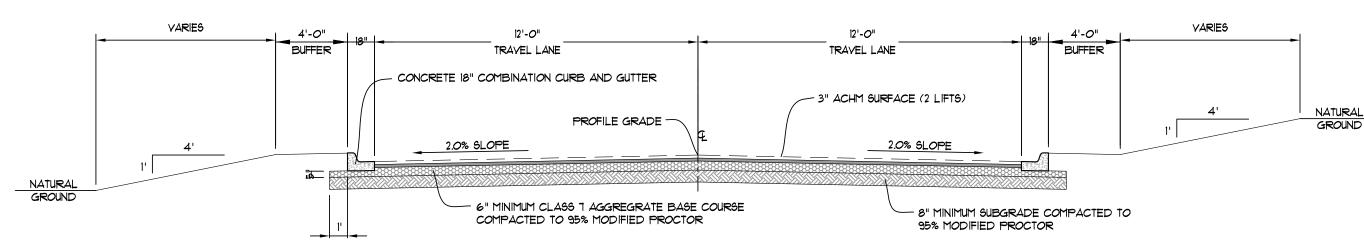


#### LOCAL STREET SECTION SCALE: NONE

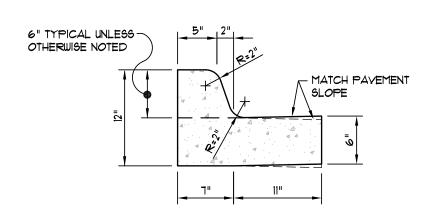


NOTE: CONTRACTION AND EXPANSION JOINTS SHALL BE CONSTRUCTED IN ACCORDANCE WITH THE PLANS AND SPECIFICATIONS.

(NOT TO SCALE)

#### TYPICAL CURB & GUTTER TYPE "A-18"

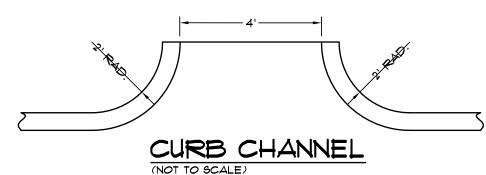

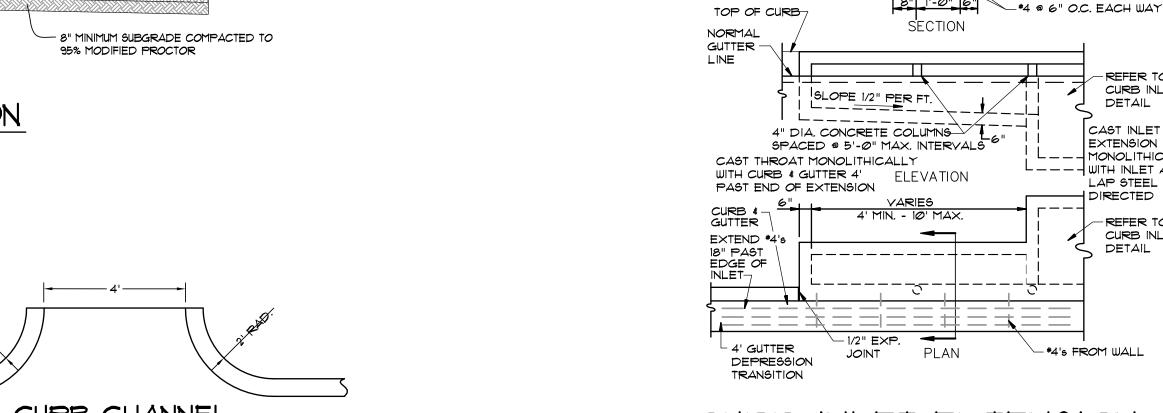




DEPRESSION AS


CALLED FOR IN

PLANS-

BEND #4's INTO GUTTER

#4 @ 8" O.C. EACH WAY

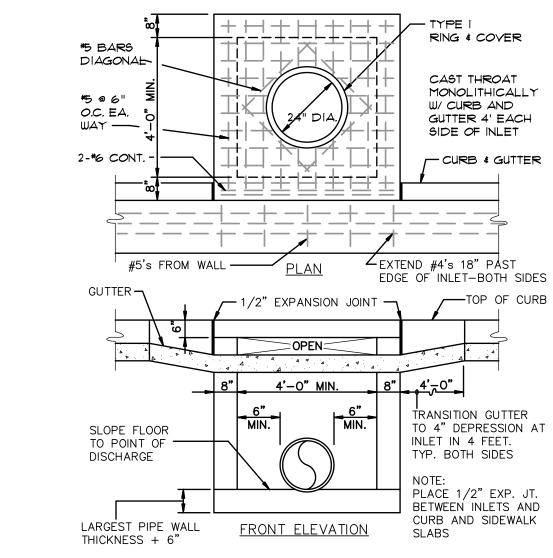

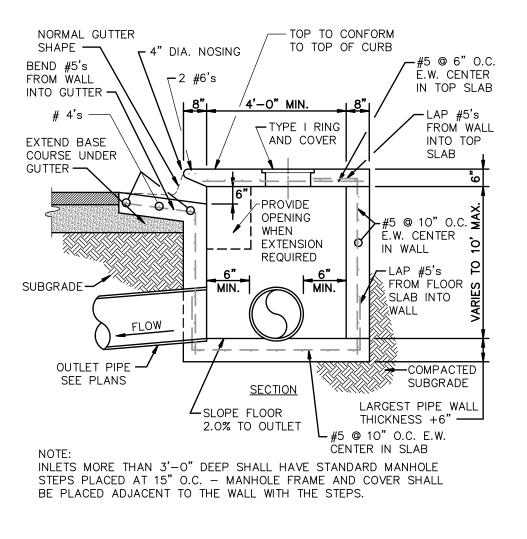

– \*4 @ 6" O.C. EACH WAY

- #4 @ 8" O.C. EACH WAY

-REFER TO CURB INLET

DETAIL

CAST INLET EXTENSION

----MONOLITHICALLY

DIRECTED

LAP STEEL AS

REFER TO

CURB INLET


DETAIL

L---- WITH INLET AND

\*4's FROM WALL


1 1/2" CLR.

CURB INLET - TYPE "A"

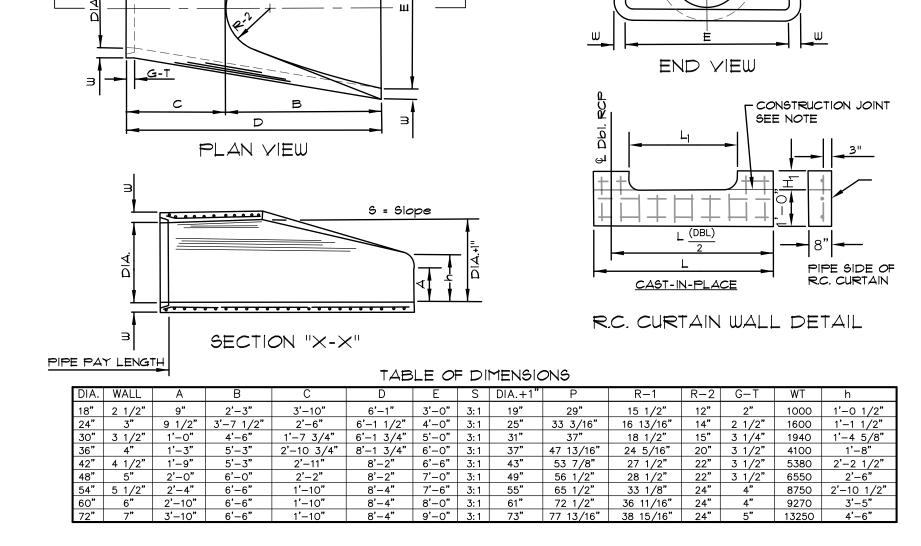


- 1. THE PORTION OF THE R.C. CURTAIN WALL BENEATH THE FLARED END SECTION (LOWER 1'-O") SHALL BE PLACED MONOLITHICALLY. THE FLARED END SECTION SHALL THEN BE SET IN PLACE AND THE REMAINING PORTIONS OF THE R.C. CURTAIN WALL PLACED.
- 2. ALL REINFORCING STEEL ARE #4 BARS AT 6" O.C.
- 3. NO SEPARATE PAYMENT WILL BE MADE FOR THE CURTAIN WALLS. THEY SHALL BE CONSIDERED SUBSIDIARY TO THE FLARED END SECTIONS.
- 4. TONGUE END ON UPSTREAM SECTION. GROOVE END ON DOWNSTREAM SECTION.

#### FLARED END SECTION DETAILS FOR REINFORCED CONCRETE PIPE CULVERT

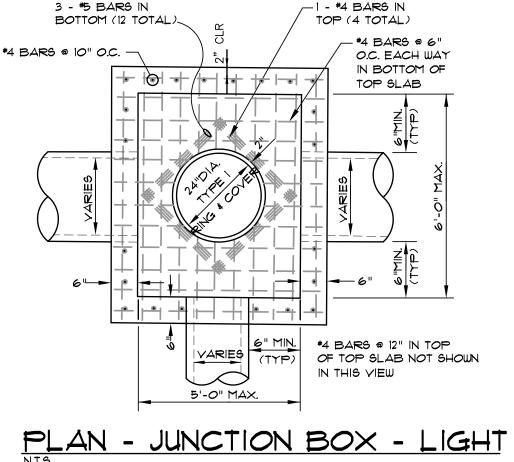

NOTE: DO NOT USE UNDER VEHICULAR TRAFFIC.

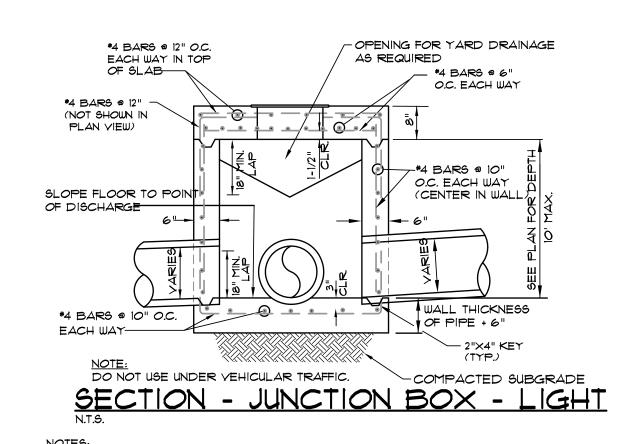


1. JUNCTION BOXES MORE THAN 3 FEET DEEP SHALL HAVE STANDARD MANHOLE STEPS PLACED @ 15" O.C.

2. SEE REINFORCING DETAIL FOR OPENING IN WALL OR SLAB.


#### 1' 5'-0" (UNLESS NOTED OTHERWISE - 5" THICK CONCRETE SIDEWALK ON PLANS) (3000 PSI CONCRETE @ 28 DAYS) 2" CLEARANCE NATURAL GROUND 6x6-W1.4xW1.4 WWF - CONCRETE COMBINATION CURB AND GUTTER TYPE "A" 2.0% SLOPE (MAX.) NATURAL GROUND 4" THICK CRUSHED LIMESTONE OR AGGREGATE BASE COURSE CLASS 8 - COMPACTED SUBGRADE

#### TYPICAL SECTION - SIDEWALK AT CURB

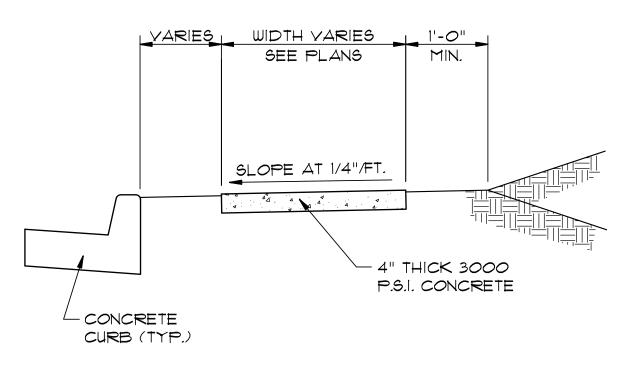


TYPICAL SECTION - SIDEWALK

\* MINIMUM WIDTH FOR SIDEWALK ADJACENT TO CURB IS 5' FOR CITY STREETS AND 6' FOR STATE OR U.S. HIGHWAYS.

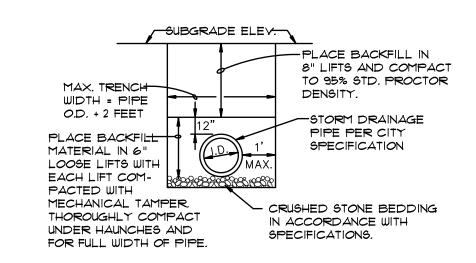


#### DRAINAGE PIPE TRENCH DETAIL

NOTE: TO BE USED WITH NEW STREET CONSTRUCTION. SEE DRAWING NO. PT-1 FOR EXISTING STREET CUTS.

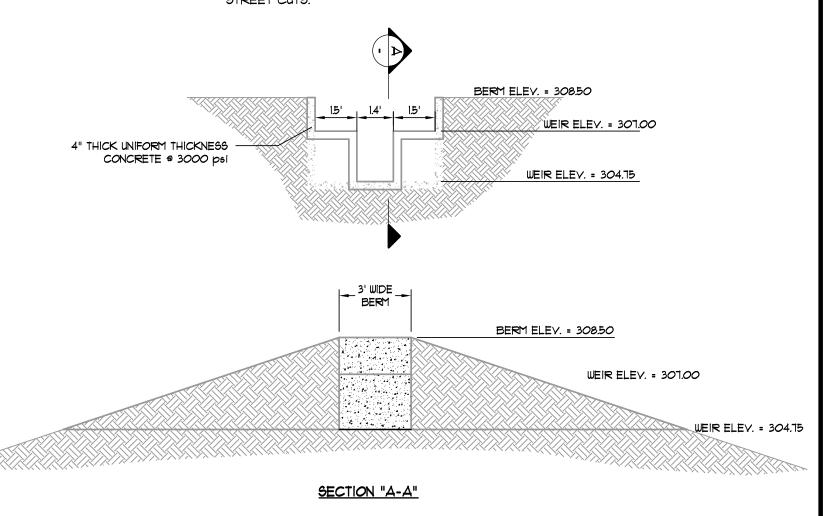

### BROAD CRESTED WEIR DETAIL

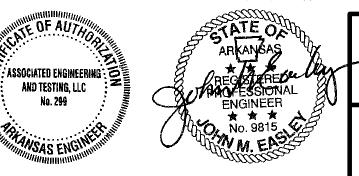


ASSOCIATED ENGINEERING AND TESTING, LLC CIVIL ENGINEERING AND LAND SURVEYING SERVICES
103 SOUTH CHURCH STREET - P.O. BOX 1462 - JONESBORO, AR 12403
PH: 810-932-3594


> STANDARD DETAILS EMERALD VILLAGE KWL PROPERTIES, LLC


> > C10

JONESBORO, ARKANSAS REVISED PER MAPC COMMENTS - STREET NAMES JME JME JME JME **DRAWN**: CCH CHECKED: JME DATE: 01/28/16 REVISED SANITARY SEWER ALIGNMENT PER CWL DRAWN CHK'D SCALE: AS SHOWN CADD FILESION-SDP-EV DWG O414144.0015 REVISIONS


04/26/16 1 04/05/16 REY DATE

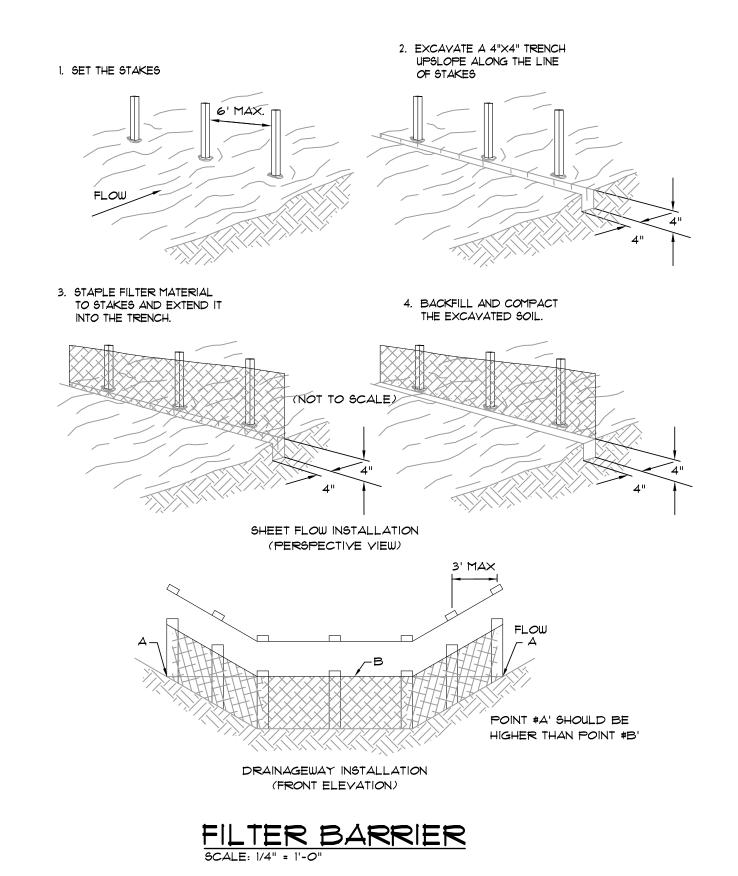


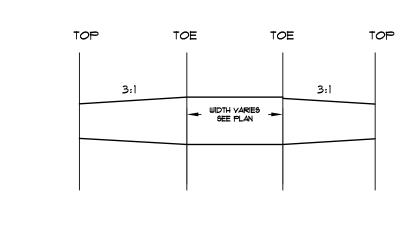

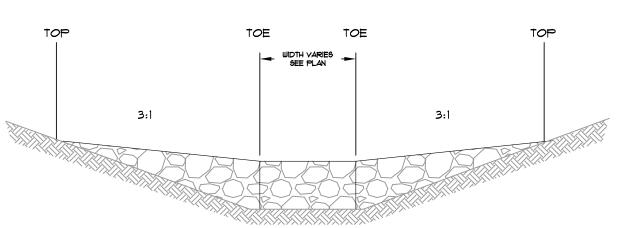


GRAVEL TO BE 2"-3" STONE ROCK CHECK DAM SCALE: 1/2" = 1'-0"

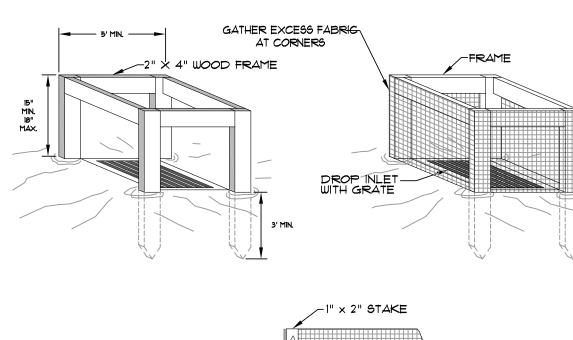

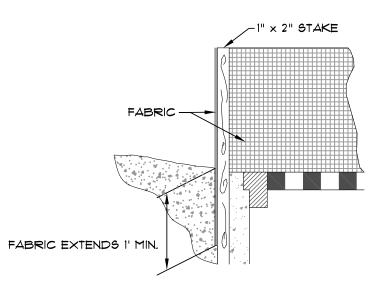


SILT FENCE INLET PROTECTION SCALE: 1/2" = 1'-0"

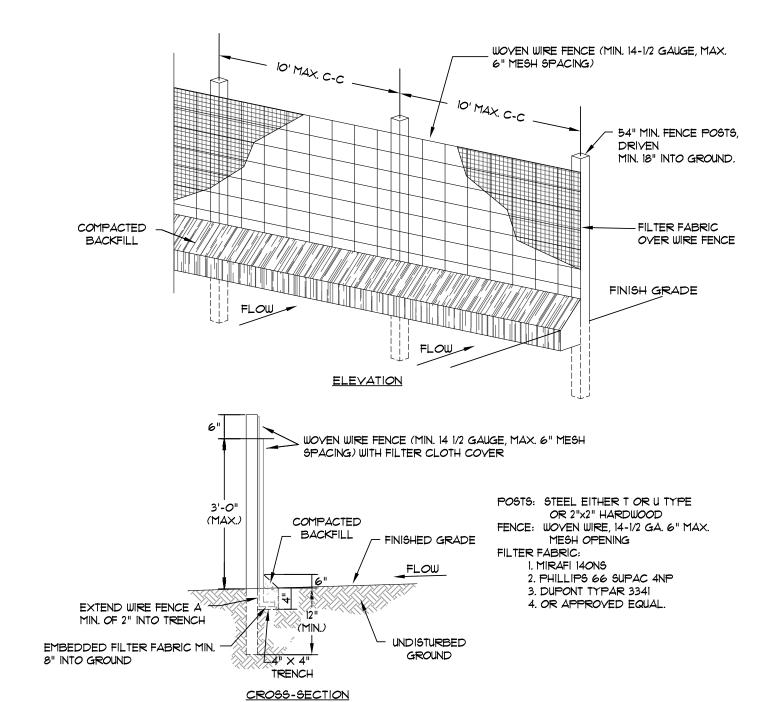


- WOVEN WIRE FENCE TO BE FASTENED SECURELY TO FENCE POSTS WITH WIRE TIES OR STAPLES.
   FILTER CLOTH TO BE FASTENED SECURELY TO WOVEN WIRE FENCE WITH TIES SPACED EVERY 24"
   AT TOP AND MID SECTION.
- 3. WHEN TWO SECTIONS OF FILTER CLOTH ADJOIN EACH OTHER THEY SHALL BE OVERLAPPED BY
- SIX INCHES AND FOLDED. 4. MAINTENANCE SHALL BE PERFORMED AS NOTED IN THE EROSION CONTROL PLAN. COLLECTED

MATERIAL SHALL BE REMOVED WHEN "BULGES" DEVELOP IN THE SILT FENCE.

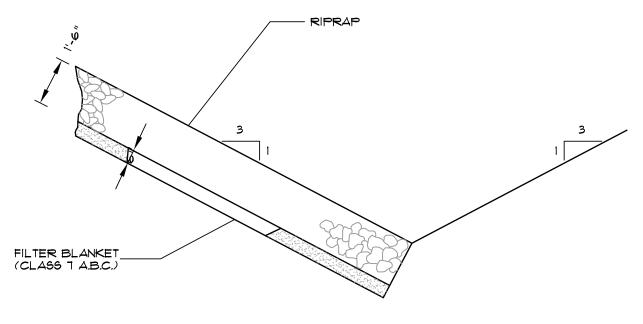


NOTE: IN LIEU OF AN AGGREGATE FILTER BLANKET, A SYNTHETIC FIBER GEOTEXTILE FABRIC MEETING THE REQUIREMENTS OF AASHTO M288 MAY BE USED. IN LIEU OF RIPRAP, AN EROSION CONTROL MAT MAY BE USED.

SECTION - DUMPED RIPRAP
TOE EXCAVATION IN SOIL

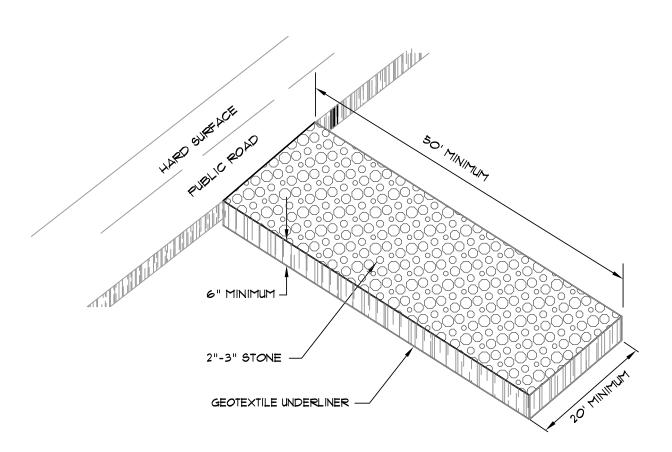

CONSTRUCTION ENTRANCE

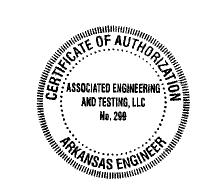



ASSOCIATED ENGINEERING AND TESTING, LLC CIVIL ENGINEERING AND LAND SURVEYING SERVICES 103 SOUTH CHURCH STREET - P.O. BOX 1462 - JONESBORO, AR 72403 PH: 870-932-3594 FAX: 870-935-1263

> EROSION CONTROL DETAILS EMERALD VILLAGE KWL PROPERTIES, LLC

JONESBORO, ARKANSAS JME JME REVISED PER MAPC COMMENTS - STREET NAMES 2 04/26/16 JME JME **DRAWN**: JME CHECKED: JME DATE: 01/28/16 1 04/05/16 REVISED SANITARY SEWER ALIGNMENT PER CWL REY DATE REVISIONS DRAWN CHK'D SCALE: AS SHOWN CADD FILESIOO-SDP-EV DWG\*: CII