
SITE DEVELOPMENT PLANS

PROPOSED COMMERCIAL PARK CRAIGHEAD COUNTY FAIRGROUNDS

PREPARED FOR

CRAIGHEAD COUNTY FAIR BOARD

JONESBORO, ARKANSAS FEBRUARY, 2011

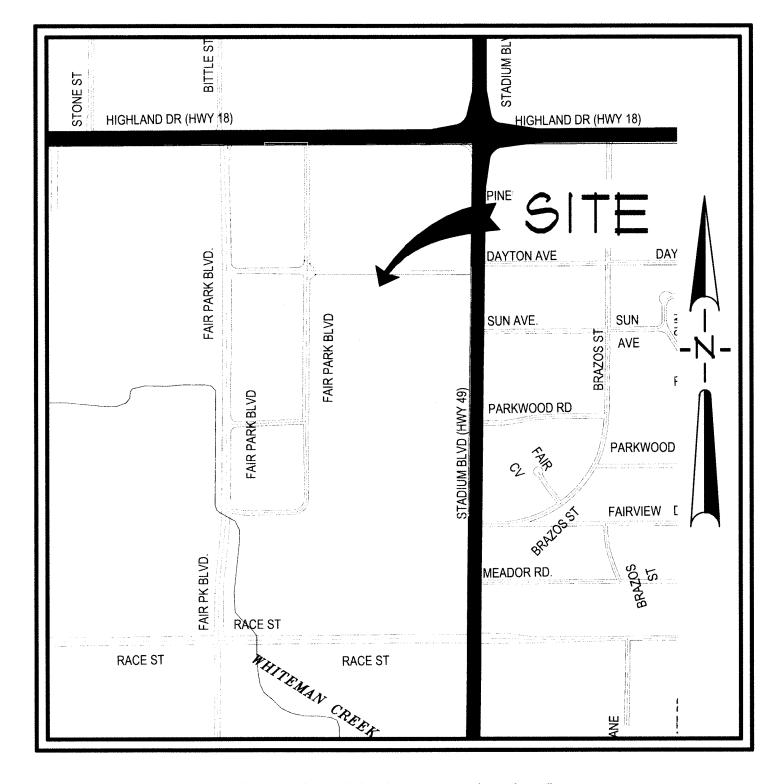

SCALE: 1" = 500'

INDEX TO SHEETS

1 OF 10 INDEX SHEET

2 OF 10 GENERAL NOTES & AREA MAP

3 OF 10 TOPOGRAPHIC SURVEY

4 OF 10 RECORD PLAT 5 OF 10 UTILITY LAYOUT


6 OF 10 GRADING AND DRAINAGE PLAN

7 OF 10 STREET PLAN/PROFILE

8 OF 10 EROSION CONTROL PLAN

9 OF 10 STANDARD DETAILS

10 OF 10 EROSION CONTROL DETAILS

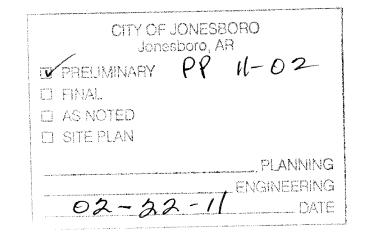


ASSOCIATED ENGINEERING AND TESTING, LLC
CIVIL ENGINEERING, LAND SURVEYING AND MATERIALS TESTING
103 SOUTH CHURCH STREET - P.O. BOX 1462 - JONESBORO, AR 12403


FAX: 870-935-1263


COVER SHEET
PROPOSED COMMERCIAL PARK
CRAIGHEAD COUNTY FAIRGROUNDS
JONESBORO, ARKANSAS


PH: 870-932-3594


| DRAWN: JME CHECKED: JME DATE: 02/22/II
| Copyright 2010 AETLLC | REV DATE | REVISIONS | DRAWN | CHK'D | SCALE: | | = 500' | CADD FILE: 10165-8DP-PHI | DWG*: 04142804.0111

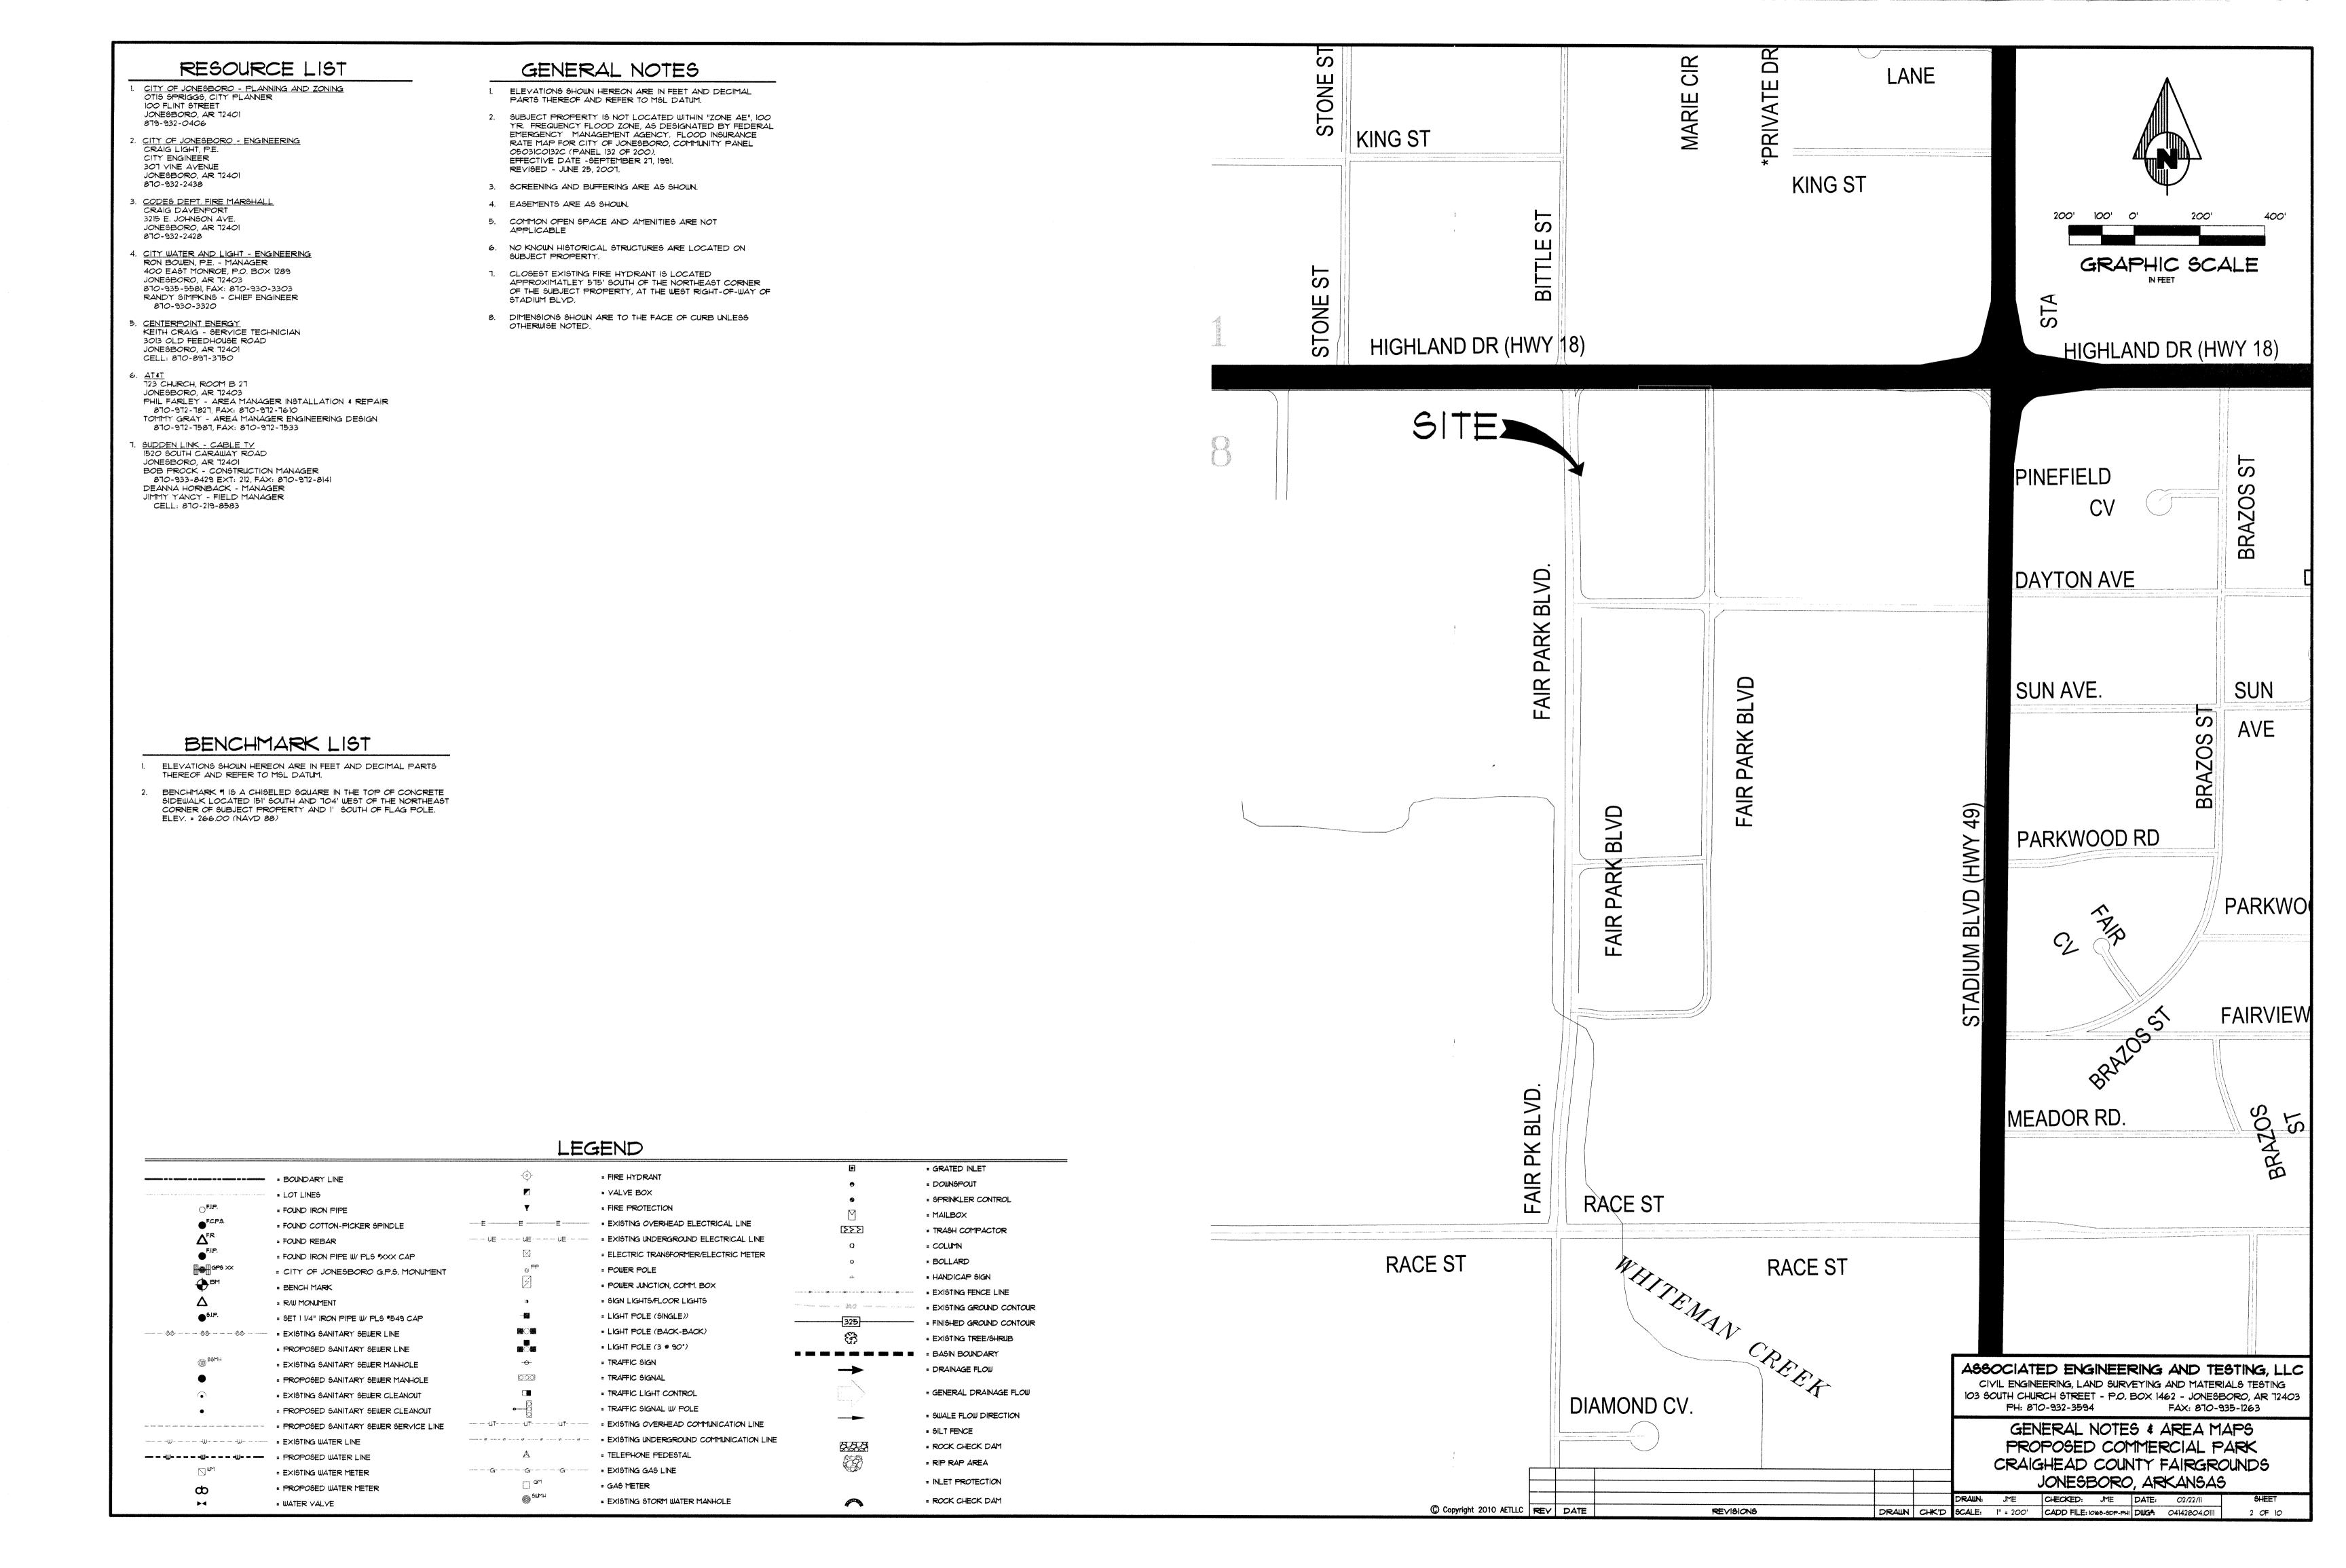

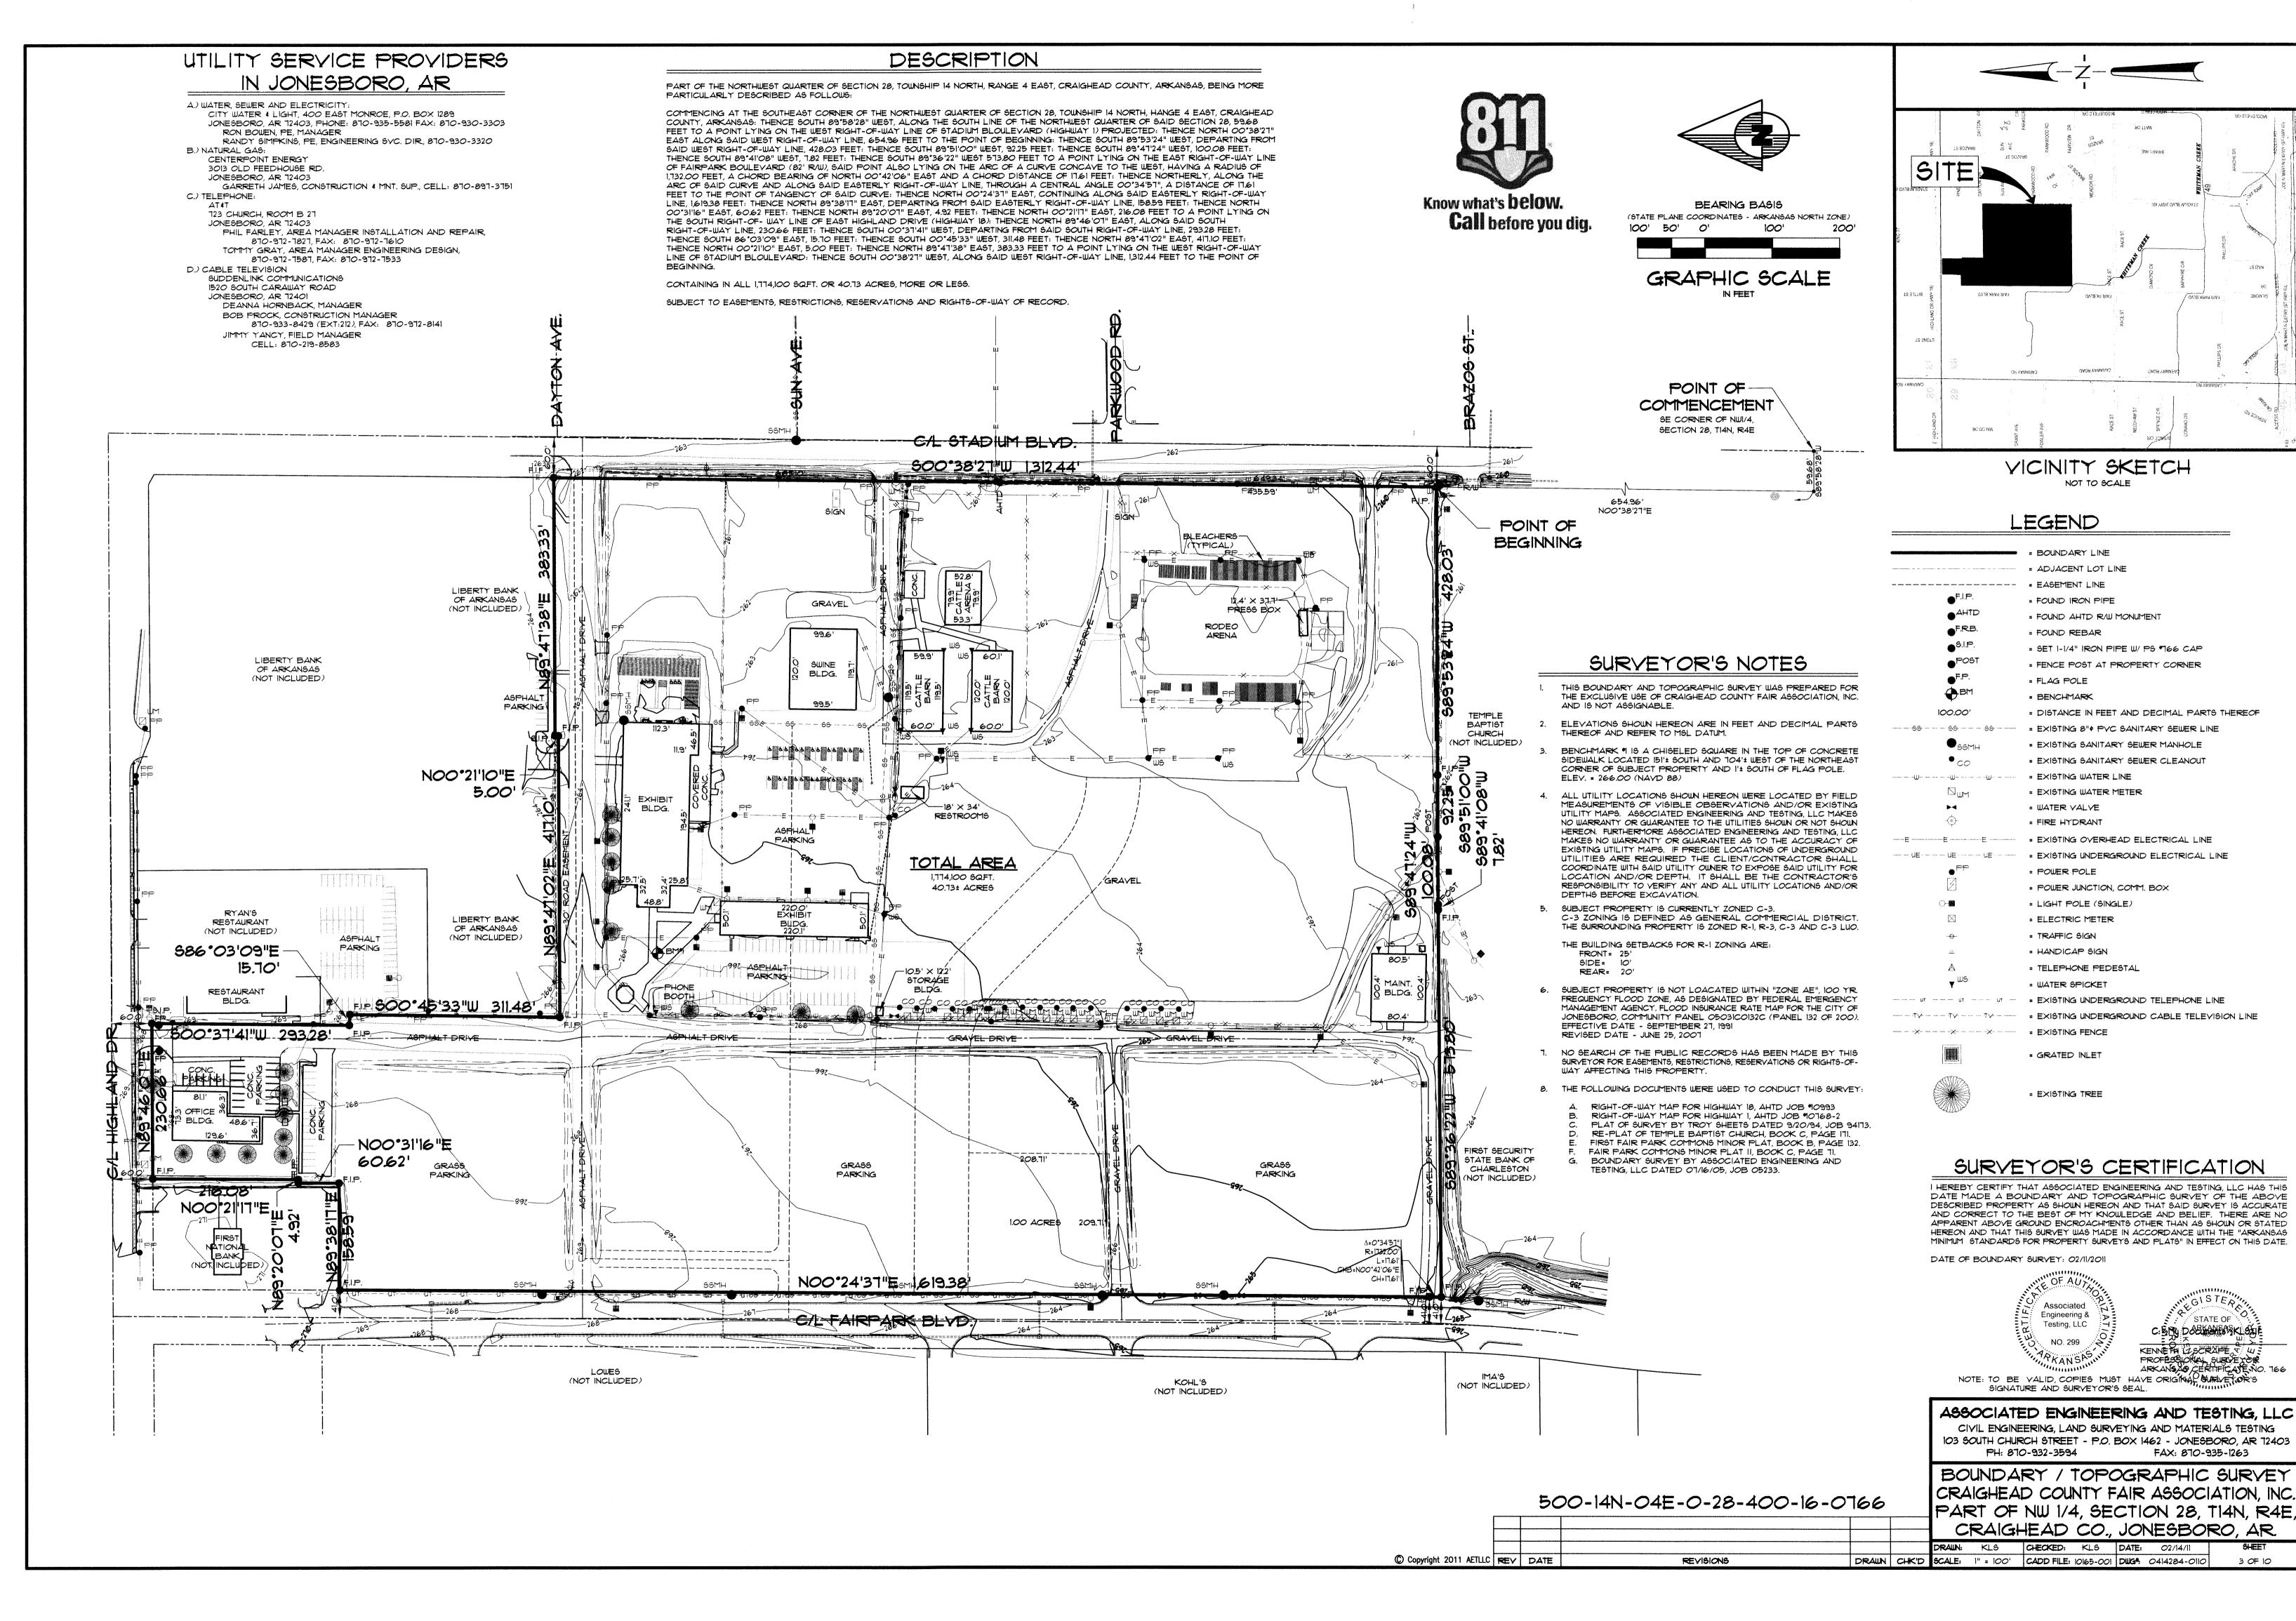

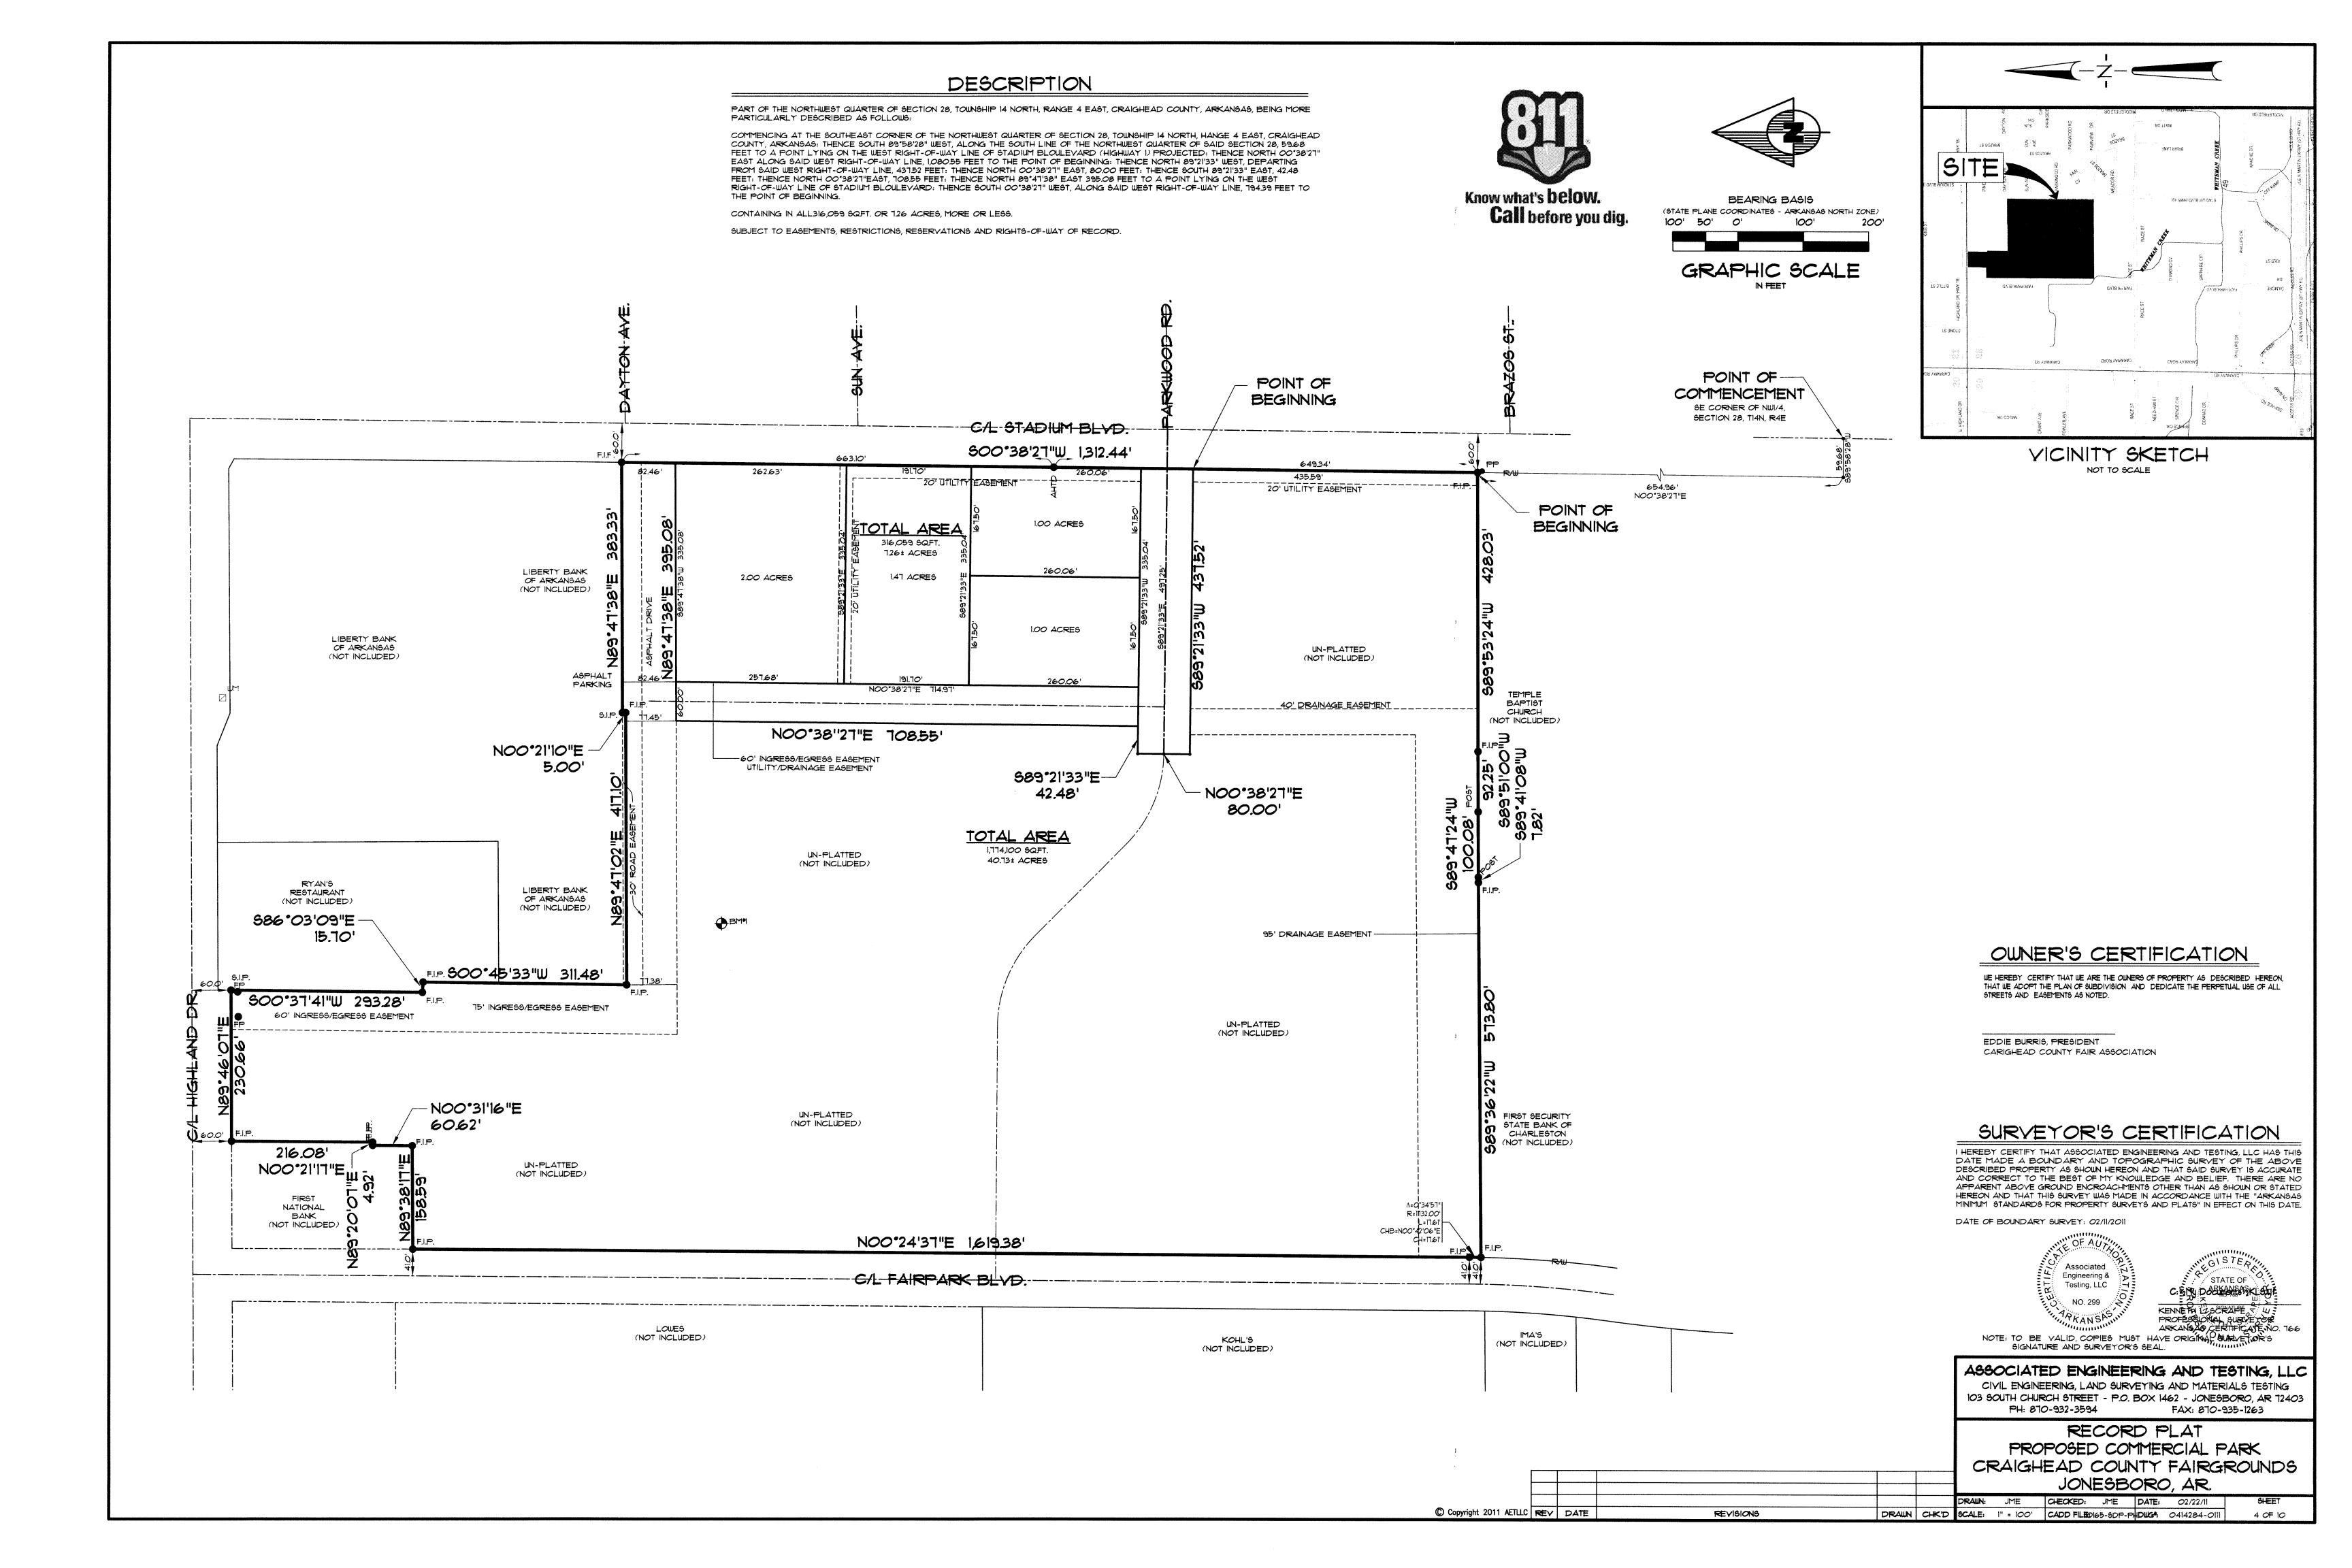

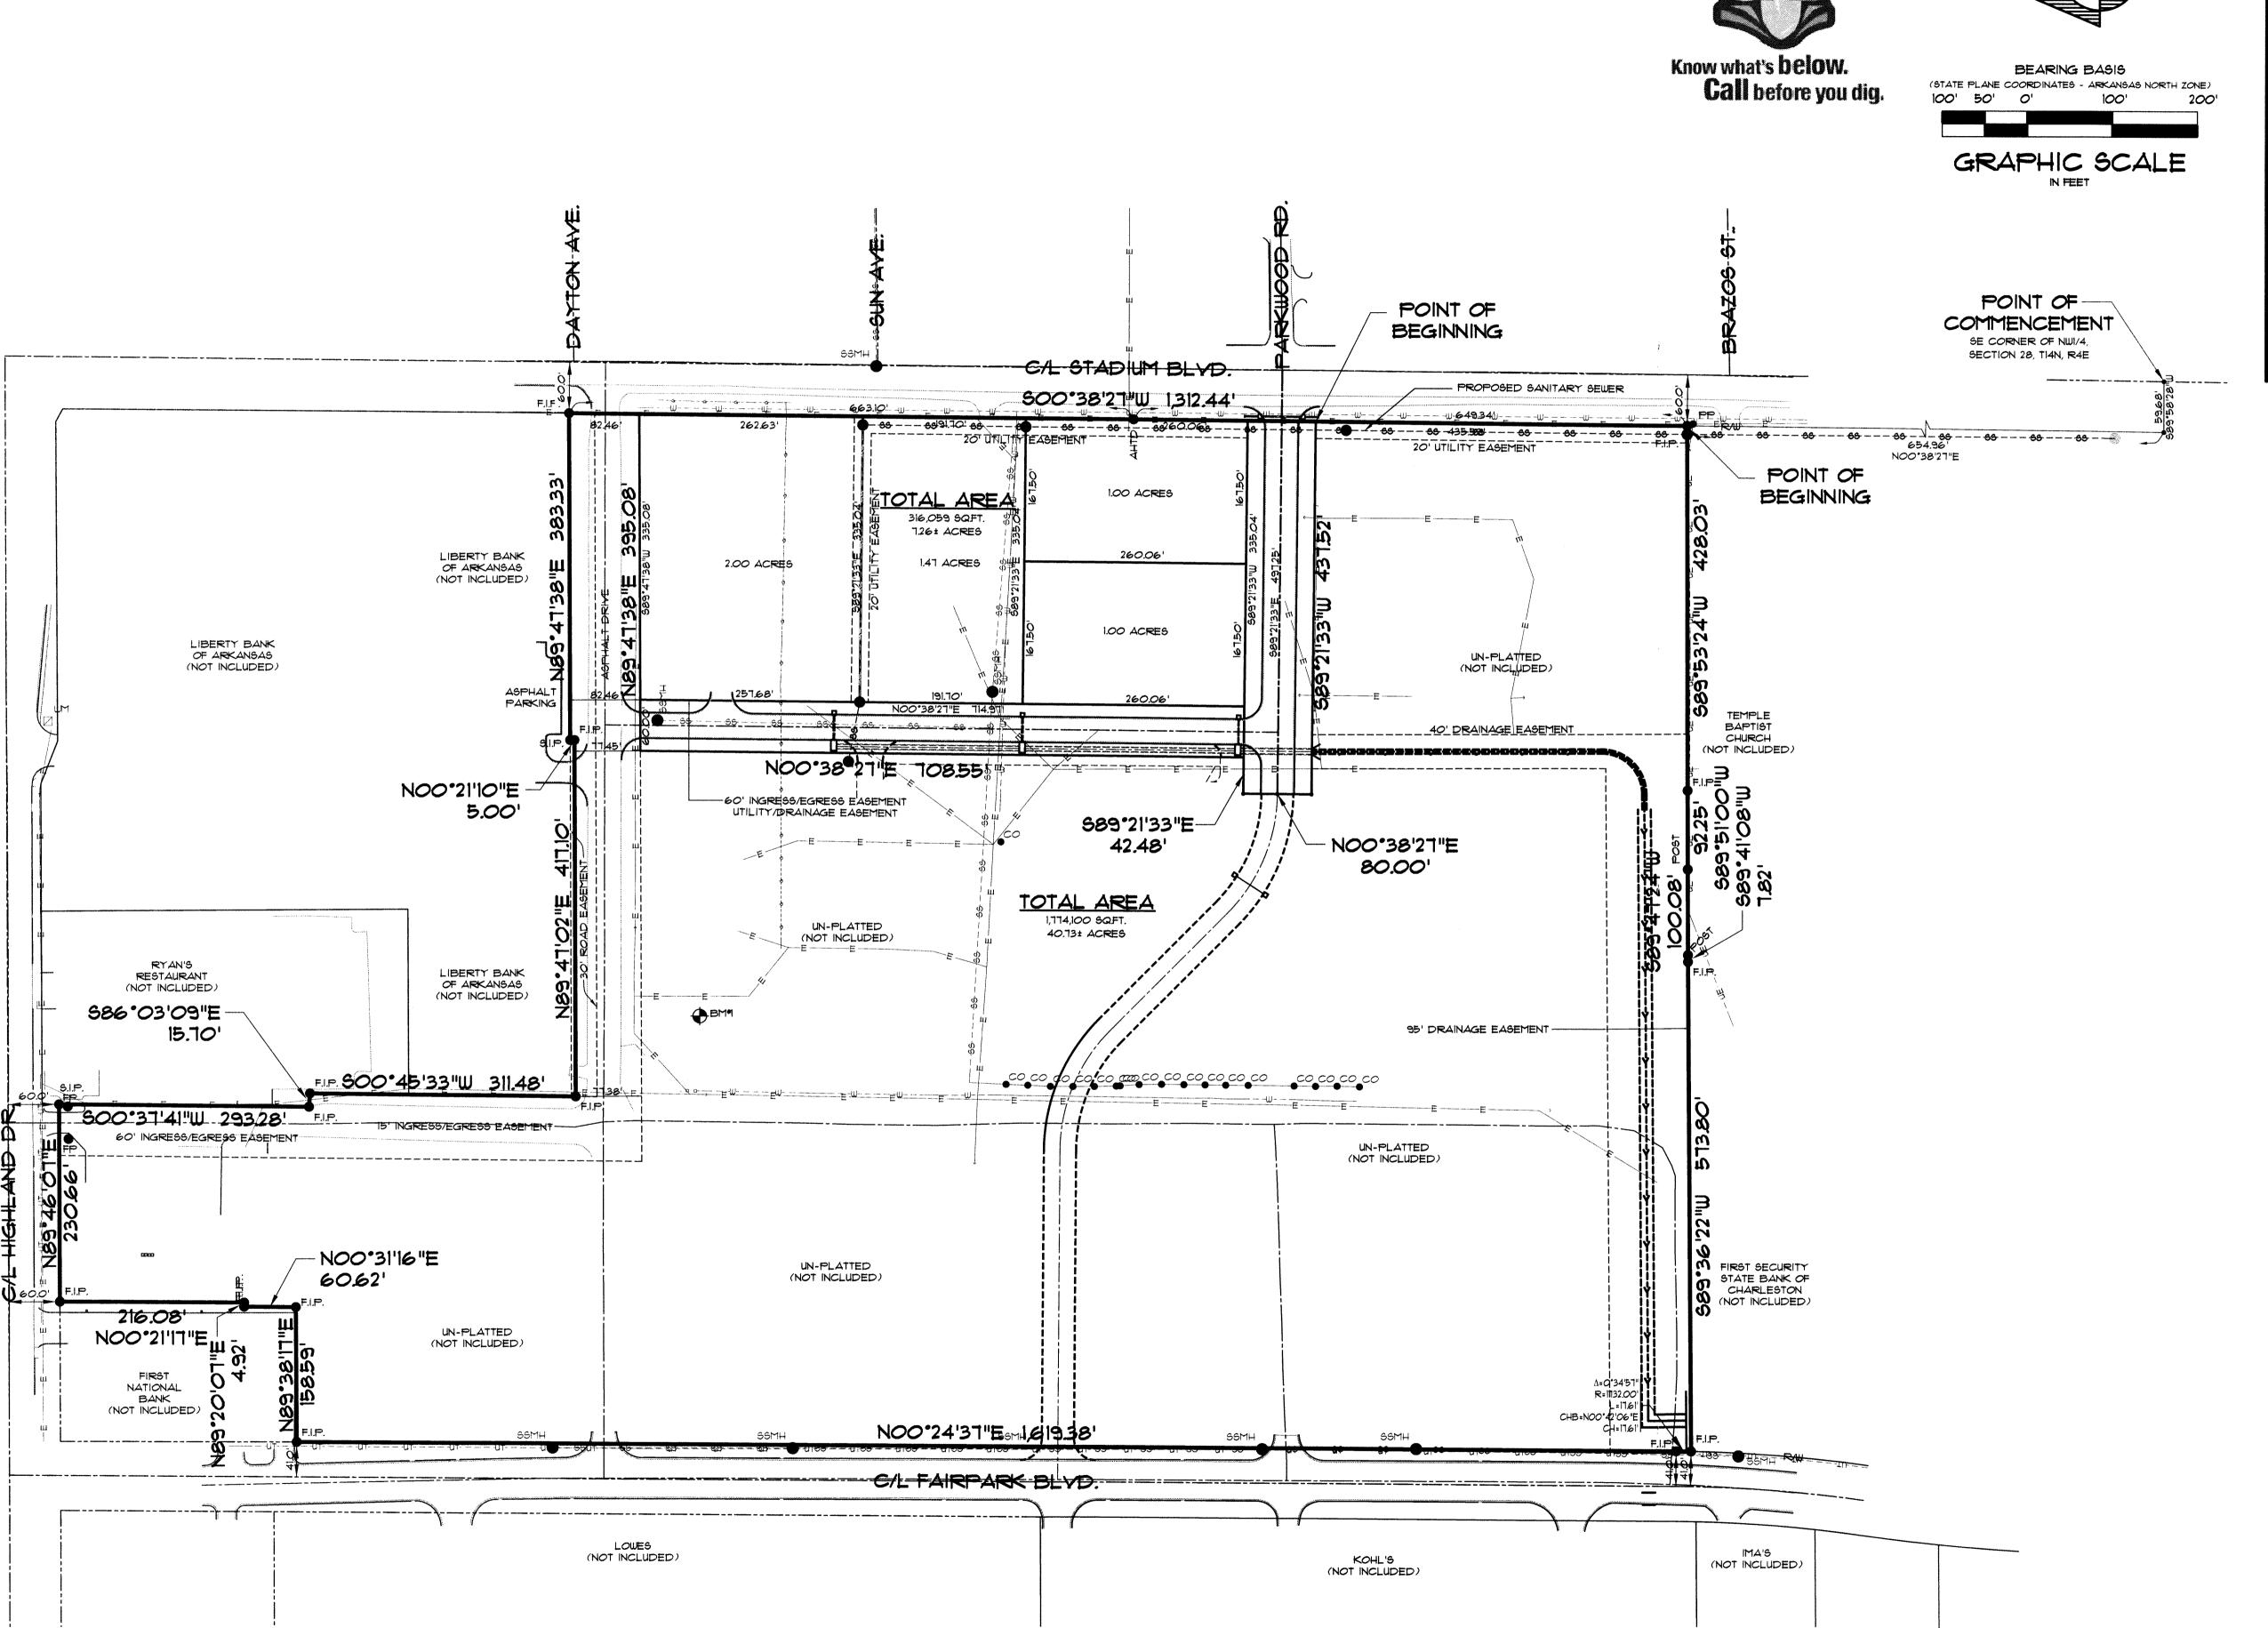

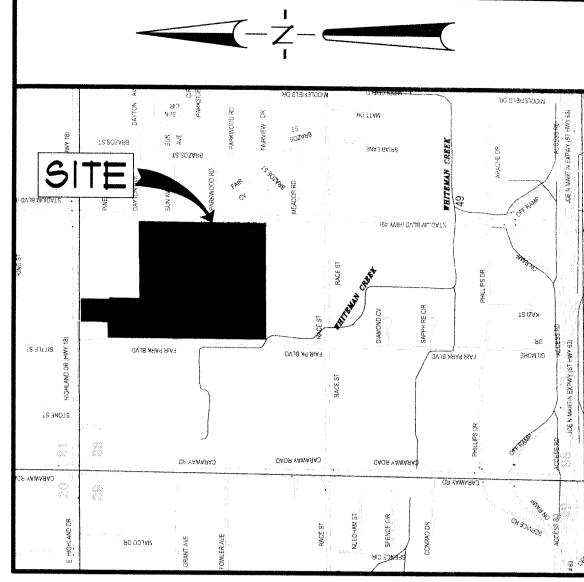

VICINITY SKETCH NOT TO SCALE

GENERAL UTILITY NOTES

1. ELEVATIONS SHOWN HEREON ARE IN FEET AND DECIMAL PARTS THEREOF AND REFER TO MSL DATUM.

- 2. VERTICAL DATUM REFERENCED TO NATIONAL GEODETIC VERTICAL DATUM
- 3. 1,866 LF OF 8" ASTM D3034 SDR-35 SEWER LINE.

OF 1929 (NAVD 29)

4. PIPE DISTANCE SHOWN ARE TO CENTER OF STRUCTURES.


- 5. CONSTRUCTION SHALL NOT START ON ANY PUBLIC UTILITY SYSTEM UNTIL WRITTEN APPROVAL HAS BEEN RECEIVED BY THE ENGINEER FROM THE APPROPRIATE GOVERNING AUTHORITY AND CONTRACTOR HAS BEEN NOTIFIED BY THE OWNER'S REPRESENTATIVE.
- 6. THE CONTRACTOR SHALL NOTIFY ALL AFFECTED UTILITY COMPANIES AT LEAST 48 HOURS PRIOR TO COMMENCEMENT OF ANY WORK.
- 7. EXCAVATE AND VERIFY ALL UTILITY CROSSINGS AND INFORM THE OWNER'S REPRESENTATIVE OF ANY CONFLICT OR REQUIRED DEVIATION FROM THE PLAN. NOTIFICATION SHALL BE MADE A MINIMUM OF 48 HOURS PRIOR TO CONSTRUCTION
- 8. WHERE SEWER LINES PASS WITHIN 2 FT. VERTICALLY OF WATER LINES, THE SEWER LINE SHALL BE ENCASED IN WATERTIGHT PIPE (SEE PART XIV.A OF ADH RULES AND REGULATIONS PERTAINING
- 9. WATER LINES AND STORM SEWER CROSSINGS SHALL MAINTAIN 36" MIN. SEPARATION IN ALL DIRECTIONS.
- 10. THE INSTALLER OF THE SANITARY SEWER DISPOSAL SYSTEM MUST BE LICENSED IN THE STATE OF ARKANSAS TO INSTALL LOW PRESSURE PIPE SYSTEMS.
- II. WATER AND SEWER LINES SHALL MAINTAIN 10 FEET HORIZONTAL SEPARATION.
- 12. THE SITE SHALL BE CONSTRUCTED TO SUBGRADE AND ALL PROPOSED FILLS SHALL BE MADE AND COMPACTED PRIOR TO CONSTRUCTION OF UTILITIES
- 13. LOCATION OF UTILITIES SHOWN ON PLANS ARE APPROXIMATE ONLY. EXACT LOCATIONS SHALL BE DETERMINED IN THE FIELD BY THE CONTRACTOR
- 14. THE CONTRACTOR SHALL PROVIDE ALL NECESSARY PROTECTIVE MEASURES TO SAFEGUARD UTILITIES AND STRUCTURES FROM DAMAGE DURING CONSTRUCTION. THE COSTS OF SUCH PROTECTION IS INCLUDED IN THE BASE BID.


ASSOCIATED ENGINEERING AND TESTING, LLC CIVIL ENGINEERING, LAND SURVEYING AND MATERIALS TESTING 103 SOUTH CHURCH STREET - P.O. BOX 1462 - JONESBORO, AR 12403 PH: 870-932-3594 FAX: 870-935-1263


UTILITY PLAN PROPOSED COMMERCIAL PARK CRAIGHEAD COUNTY FAIRGROUNDS JONESBORO, AR.


DRAUN: JME CHECKED: JME DATE: 02/22/11 REVISIONS DRAWN CHK'D SCALE: 1" = 100' CADD FILEDIGS-SDP-PHDUGA: 0414284-0111

C Copyright 2011 AETLLC REV DATE

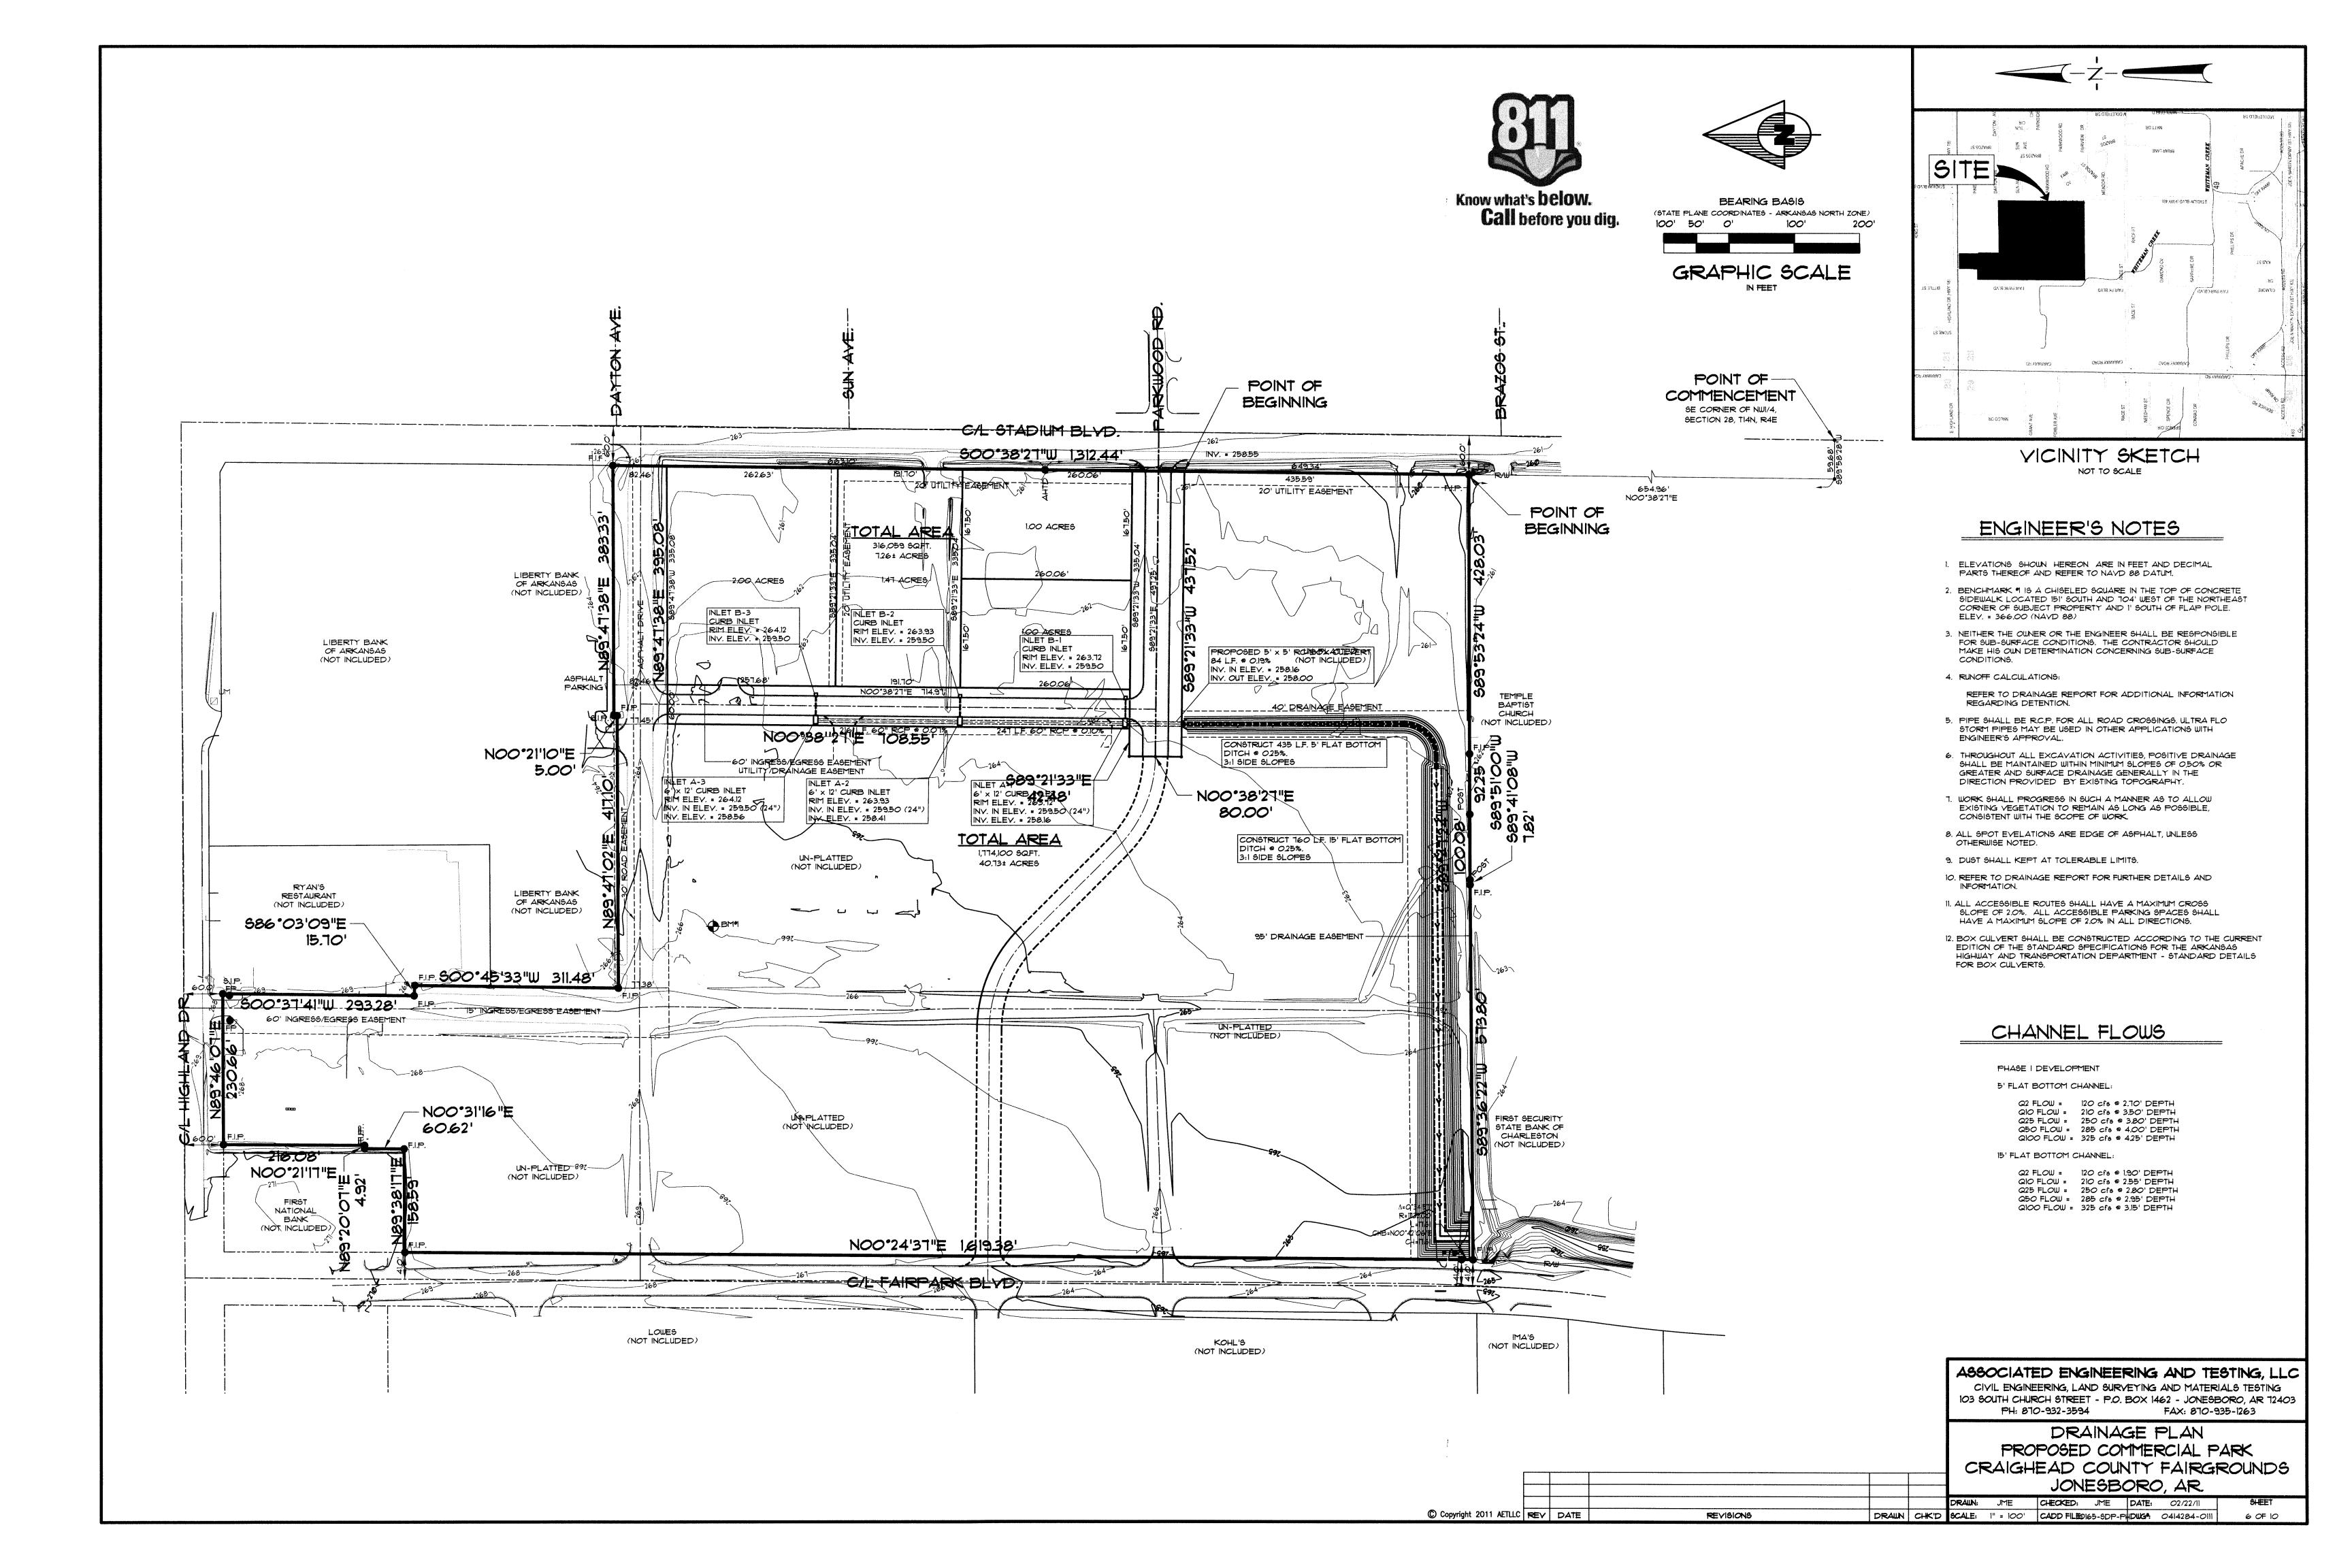


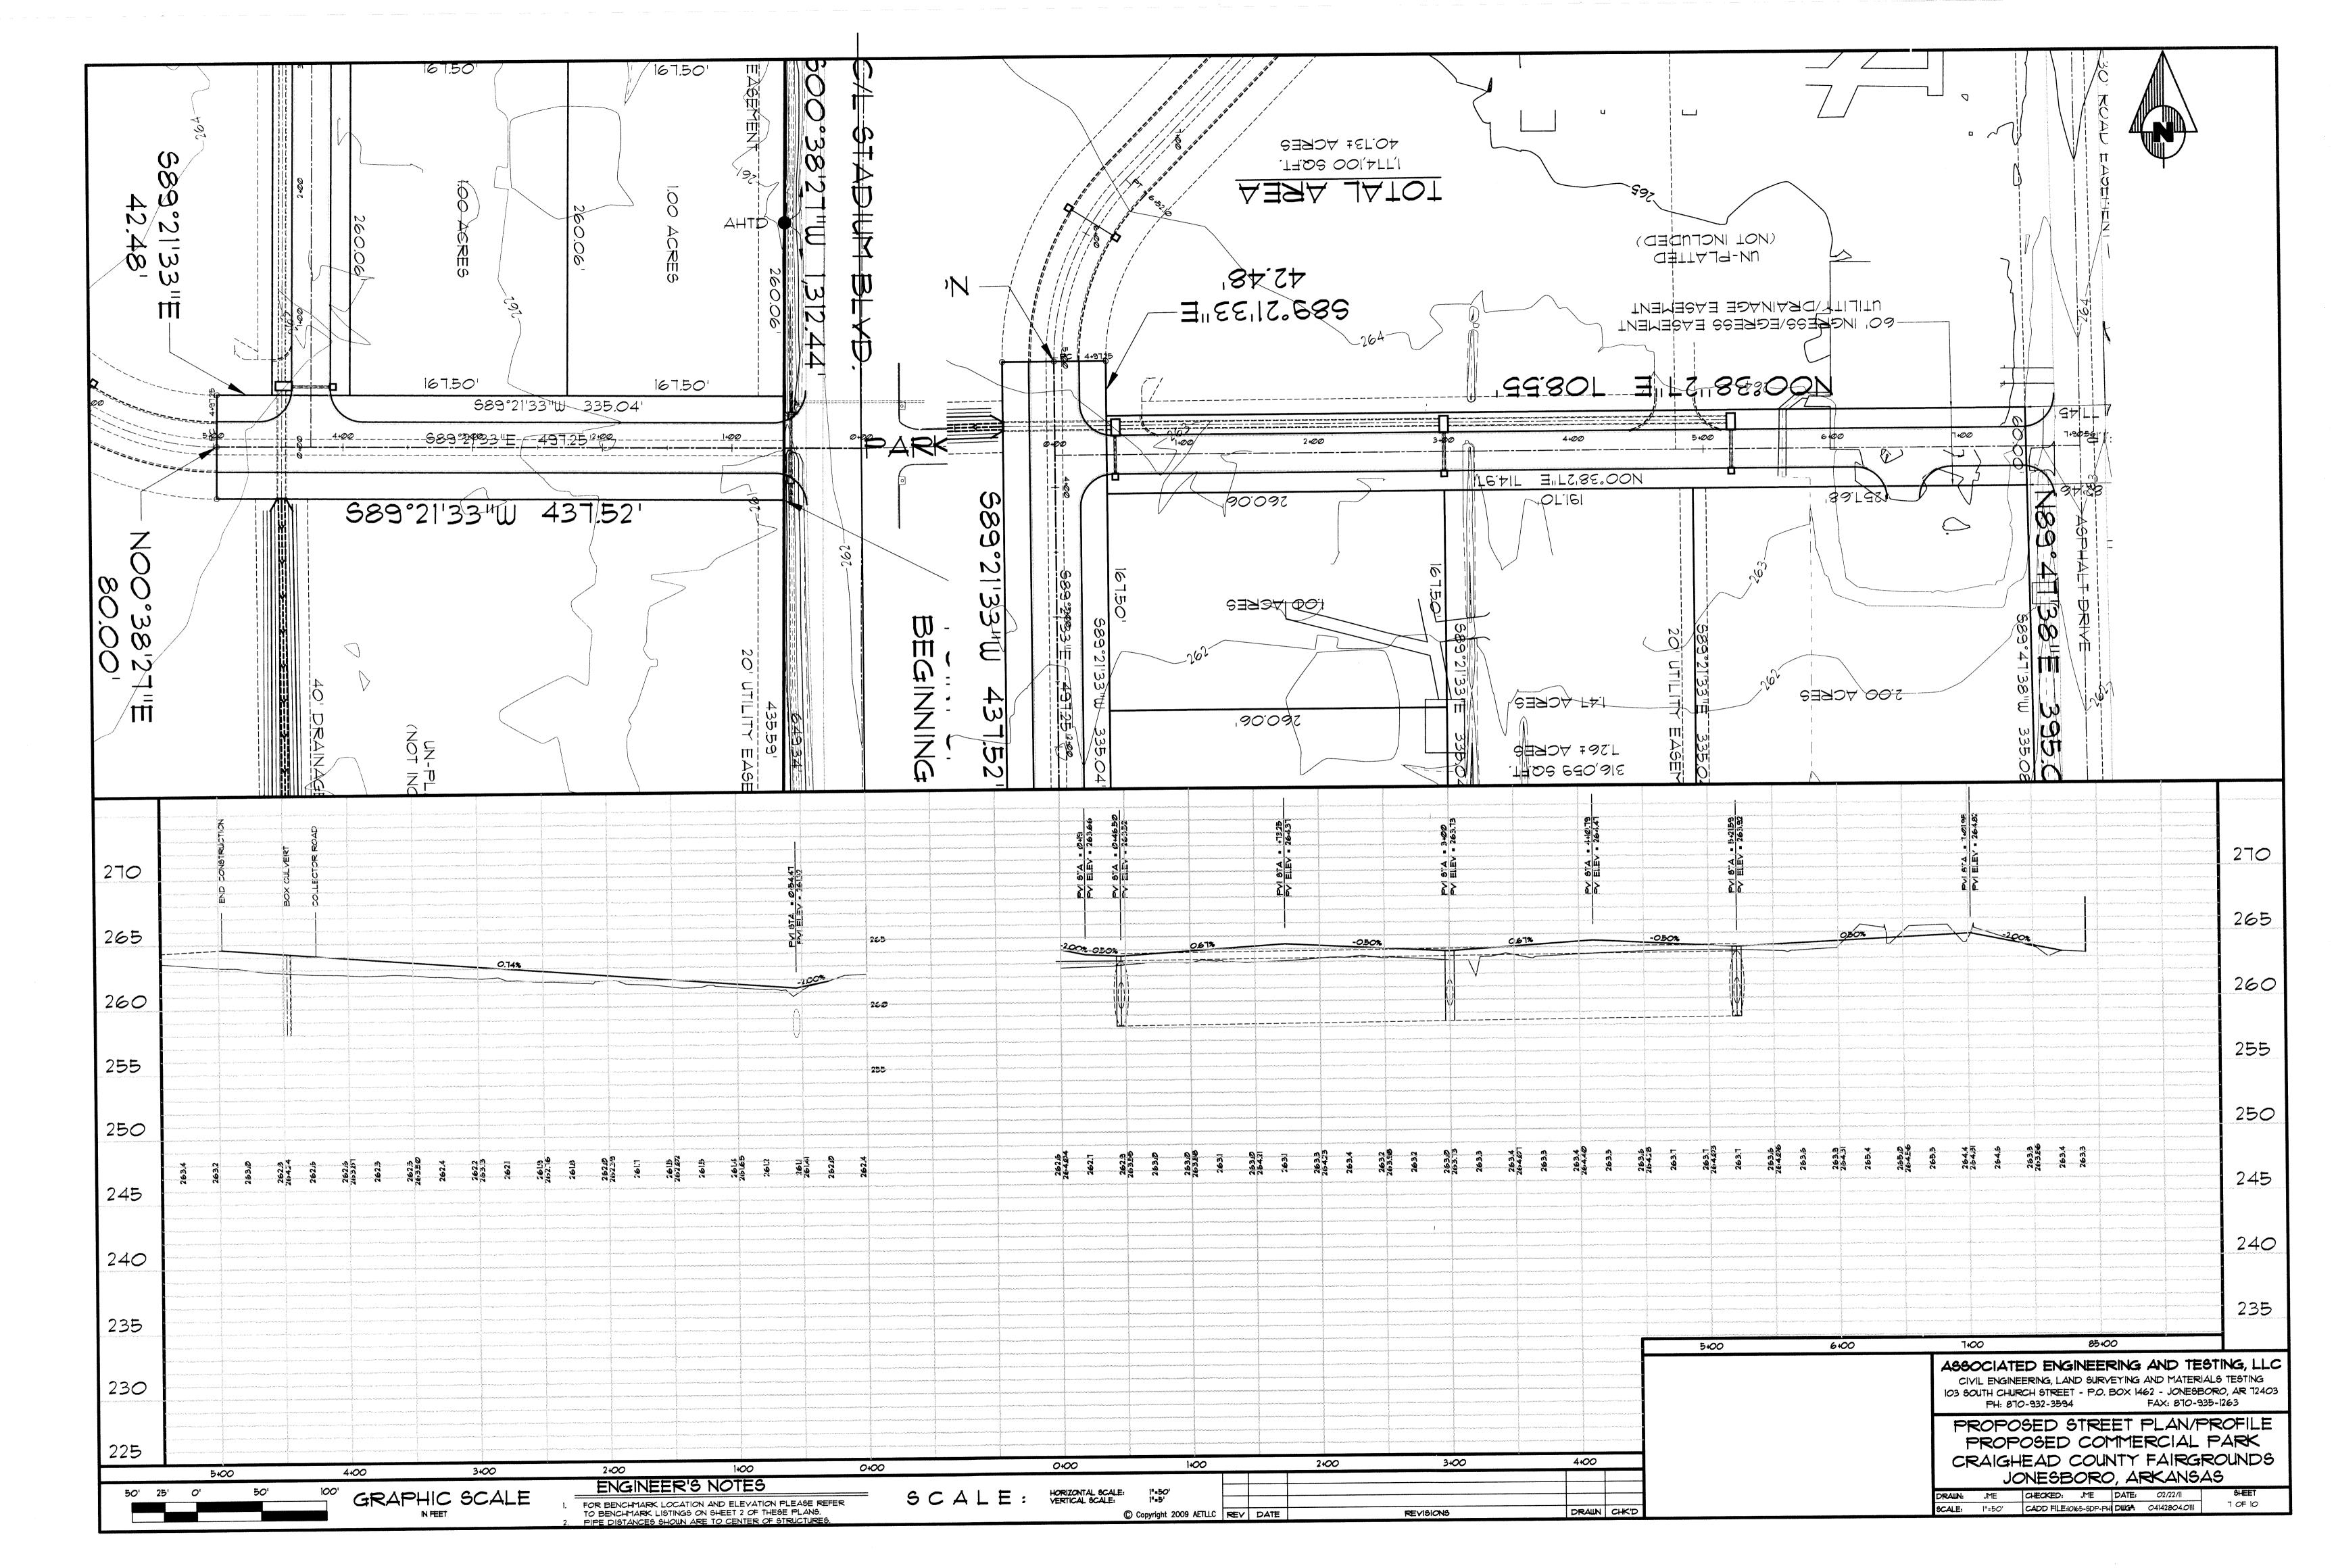

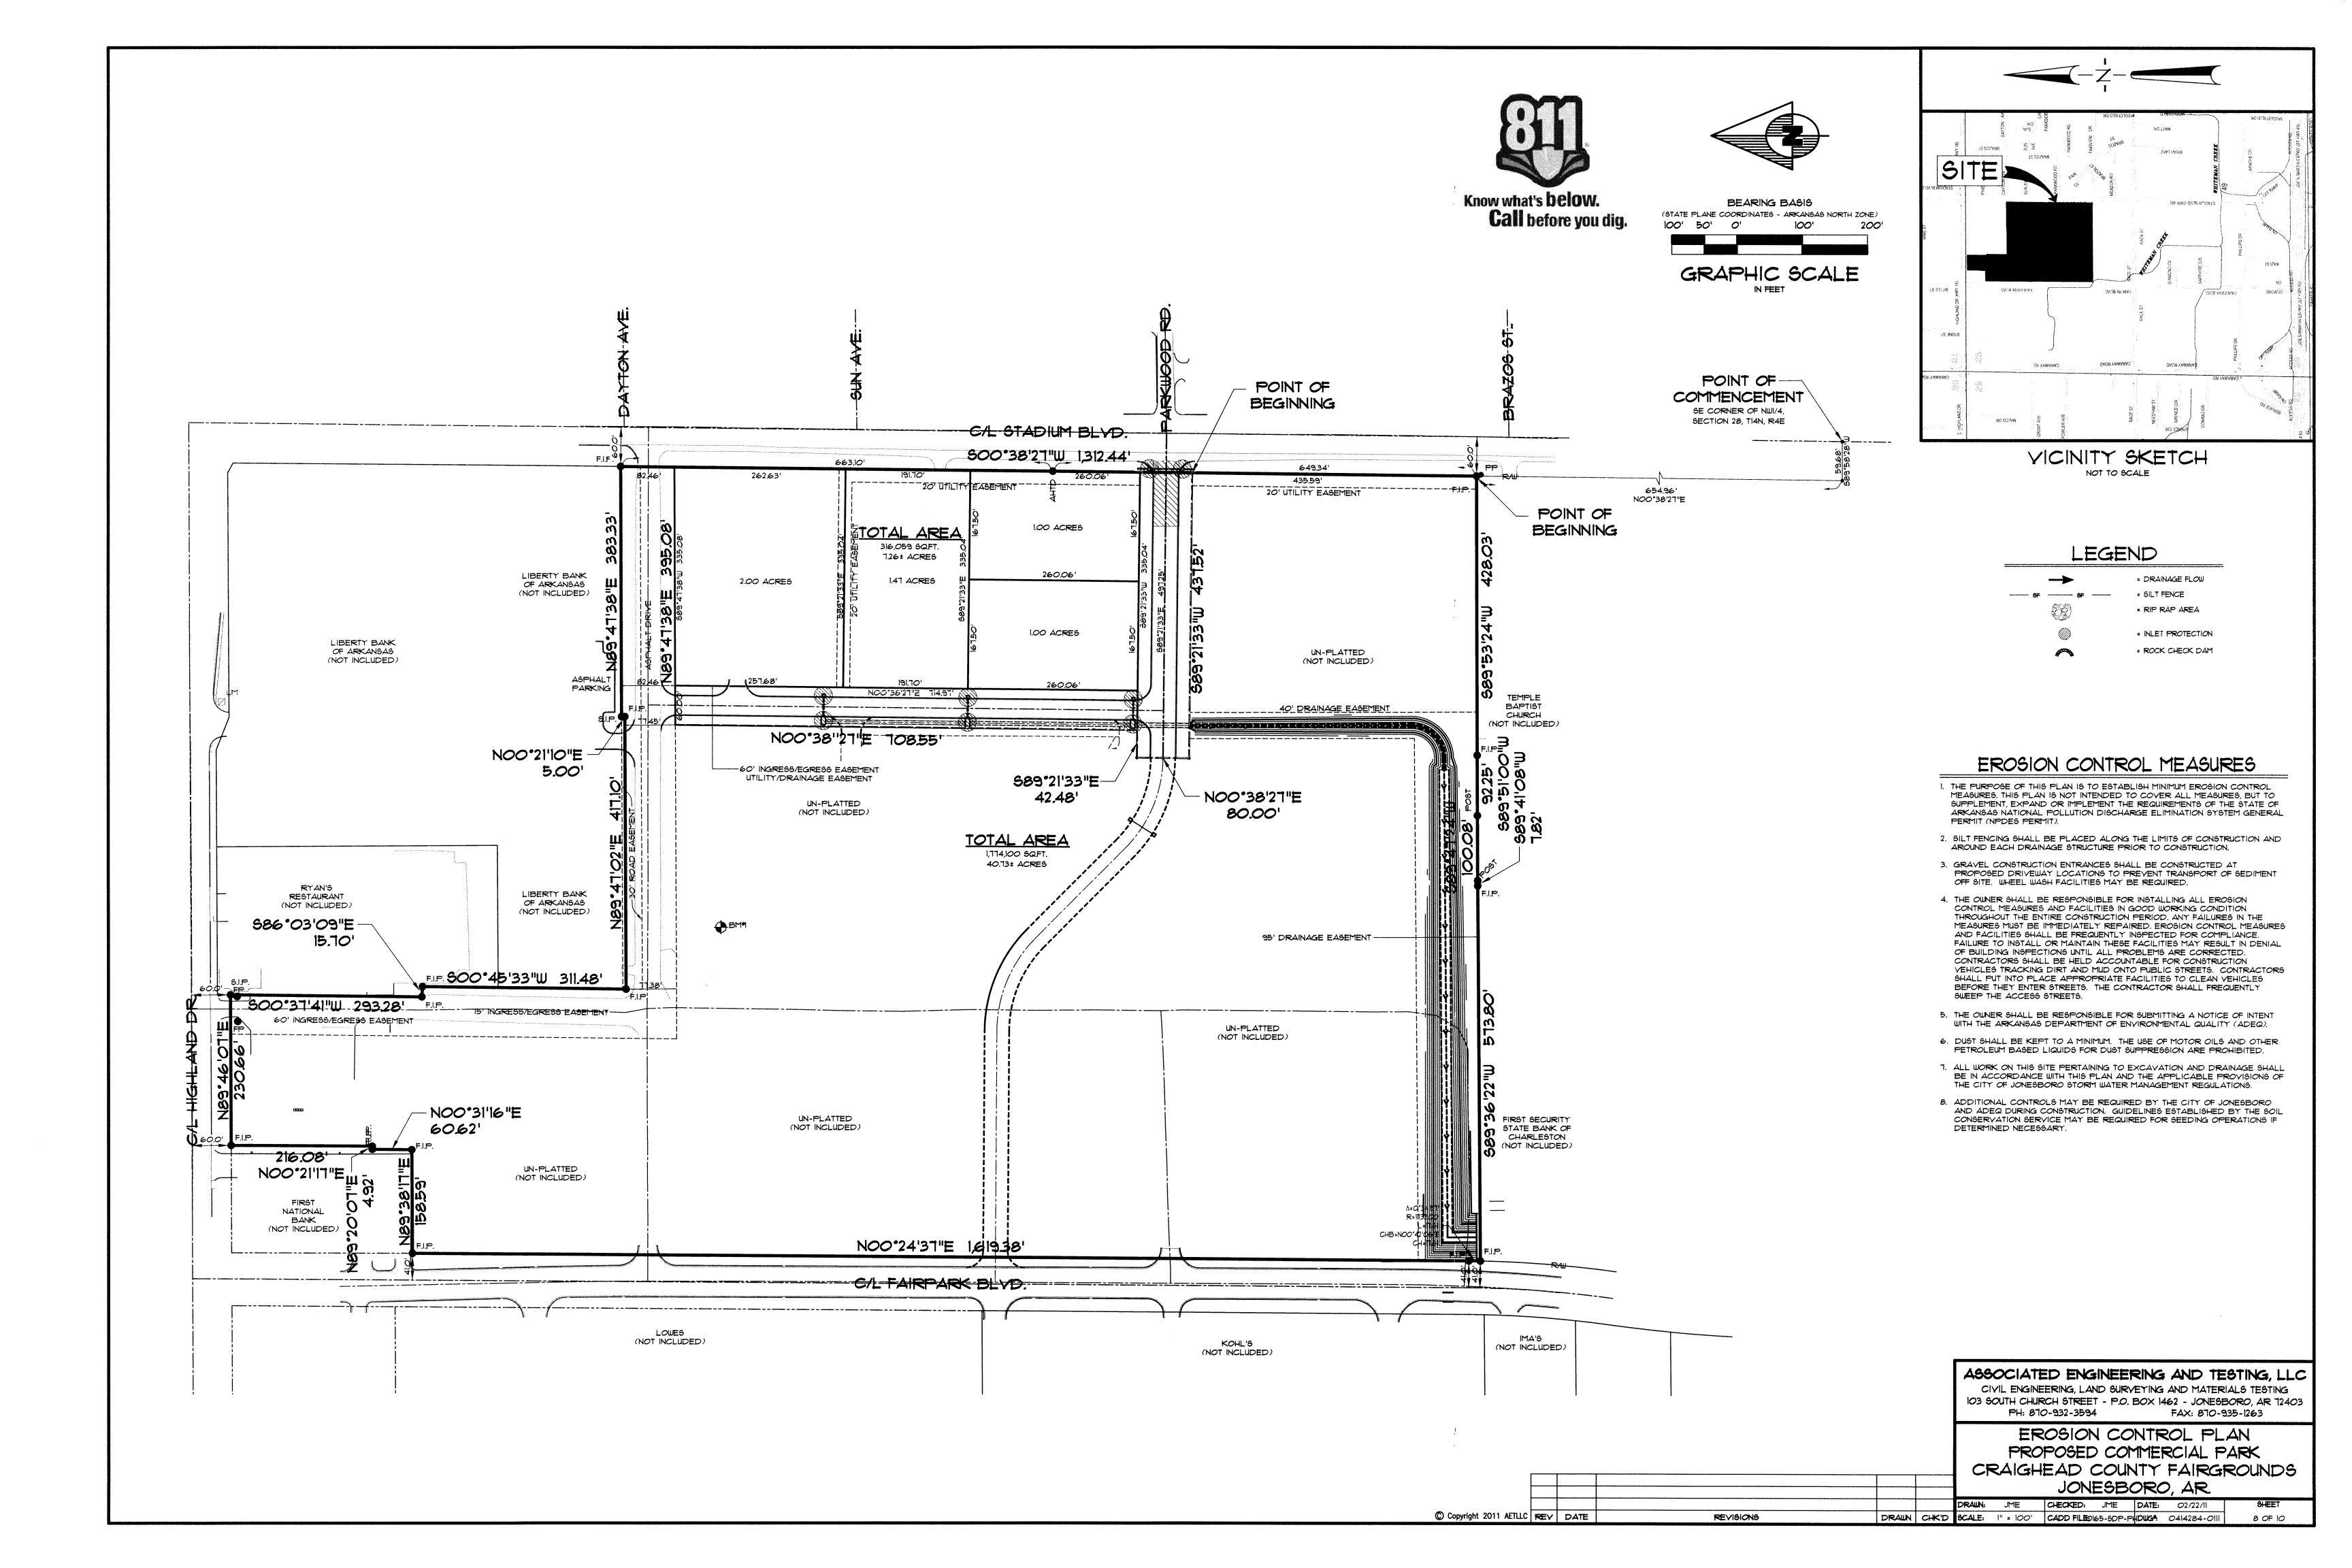


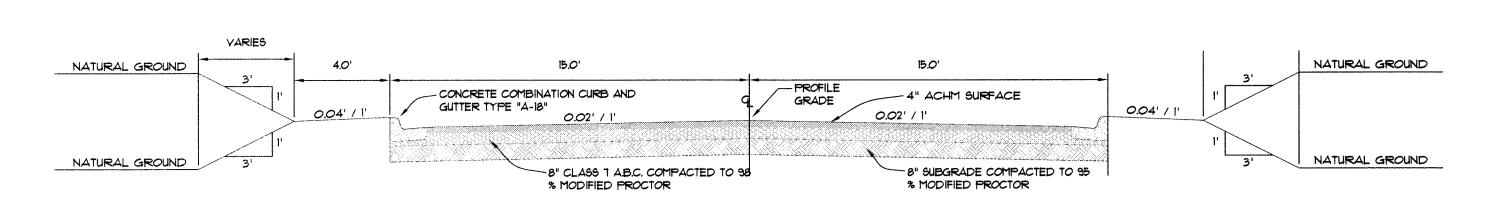


TYPICAL STREET SECTION

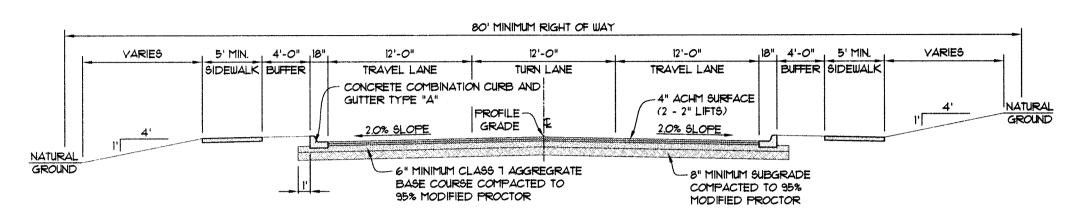


URBAN COLLECTOR STREET SECTION

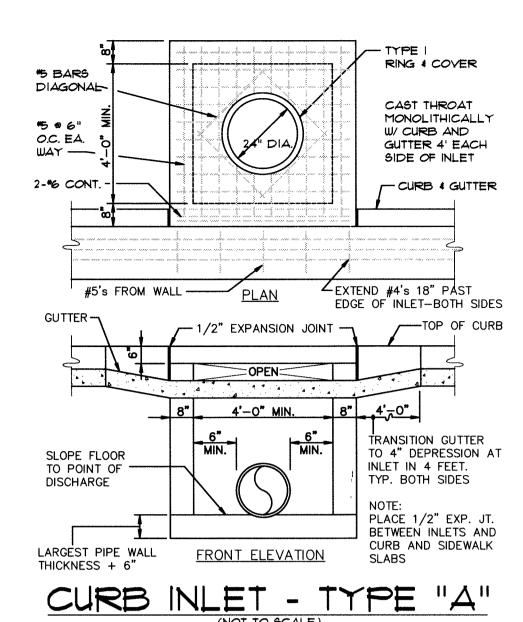

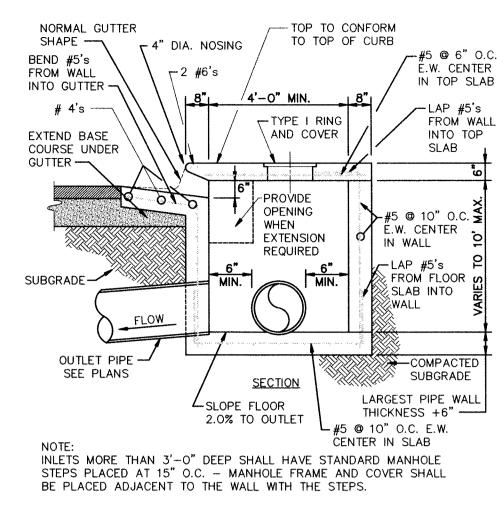


SECTION - TYPICAL CURB INLET - TYPE "A"

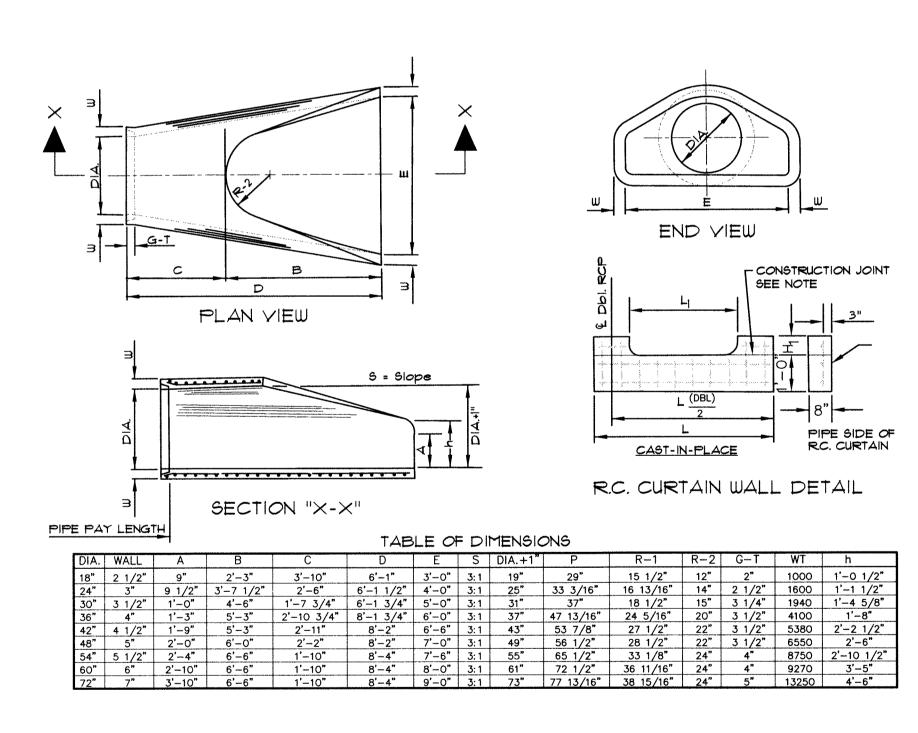

NOTES:


- 1. THE PORTION OF THE R.C. CURTAIN WALL BENEATH THE FLARED END SECTION (LOWER 1'-O") SHALL BE PLACED MONOLITHICALLY. THE FLARED END SECTION SHALL THEN BE SET IN PLACE AND THE REMAINING PORTIONS OF THE R.C. CURTAIN WALL PLACED.
- 2. ALL REINFORCING STEEL ARE *4 BARS AT 6" O.C.
- 3. NO SEPARATE PAYMENT WILL BE MADE FOR THE CURTAIN WALLS. THEY SHALL BE CONSIDERED SUBSIDIARY TO THE FLARED END SECTIONS.
- 4. TONGUE END ON UPSTREAM SECTION, GROOVE END ON DOWNSTREAM SECTION.

FLARED END SECTION DETAILS FOR REINFORCED CONCRETE PIPE CULVERT

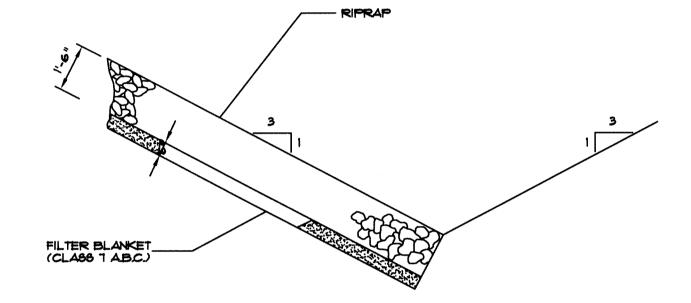


BECTION - DUMPED RIPRAP

NOTE: IN LIEU OF AN AGGREGATE FILTER BLANKET,
A SYNTHETIC FIBER GEOTEXTILE FABRIC MEETING
THE REQUIREMENTS OF AASHTO M288 MAY BE USED.
IN LIEU OF RIPRAP, AN EROSION CONTROL MAT MAY
BE USED.

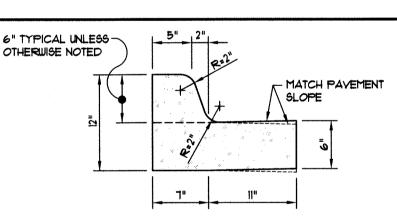

NOTE: CONTRACTION AND EXPANSION JOINTS SHALL BE CONSTRUCTED IN ACCORDANCE WITH THE PLANS AND SPECIFICATIONS.


TYPICAL CURB & GUTTER
TYPE "A-18"

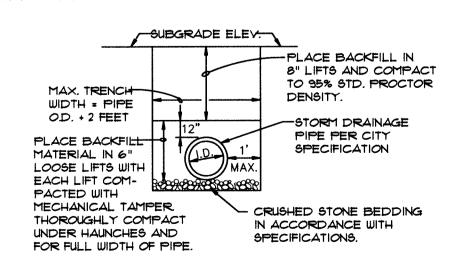

DRAINAGE PIPE
TRENCH DETAIL


NOTE: TO BE USED WITH NEW STREET CONSTRUCTION.
SEE DRAWING NO. PT-1 FOR EXISTING

STREET CUTS.

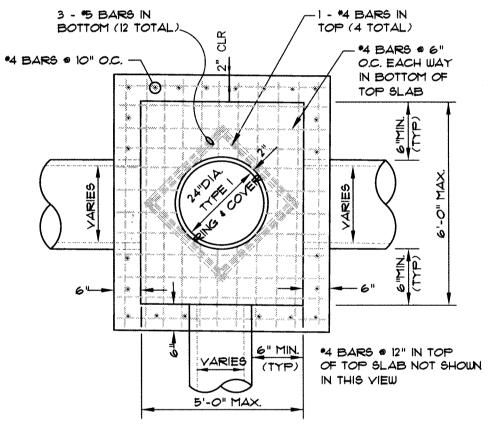

PLAN - JUNCTION BOX - LIGHT


NOTE: DO NOT USE UNDER VEHICULAR TRAFFIC.

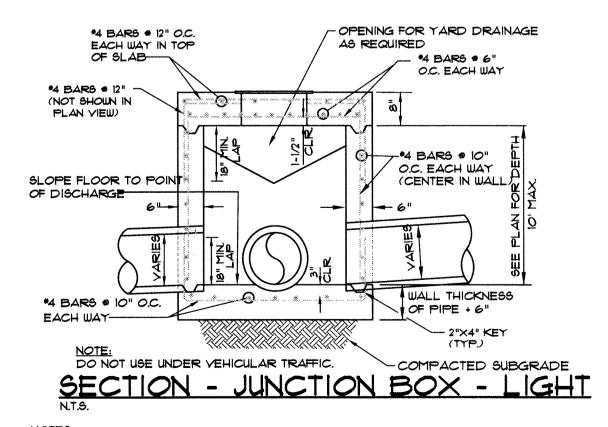


NOTES:

1. JUNCTION BOXES MORE THAN 3 FEET DEEP SHALL HAVE STANDARD MANHOLE STEPS PLACED # 15" O.C.

2. SEE REINFORCING DETAIL FOR OPENING IN WALL OR SLAB.

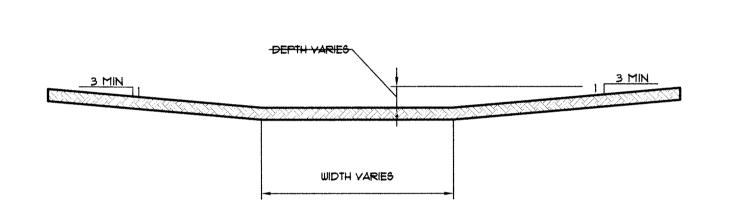

DETAIL - DRAINAGE SWALE - FLAT BOTTOM

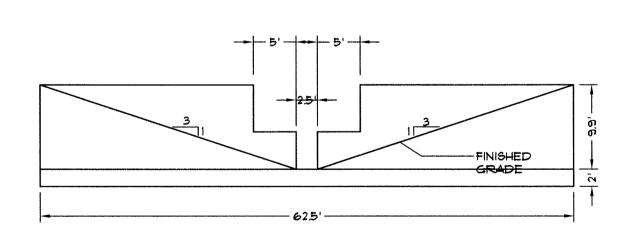

DETAIL - RECTANGULAR WEIR

ASSOCIATED ENGINEERING AND TESTING, LLC

CIVIL ENGINEERING, LAND SURVEYING AND MATERIALS TESTING

103 SOUTH CHURCH STREET - P.O. BOX 1462 - JONESBORO, AR 72403

PH: 870-932-3594 FAX: 870-935-1263

STANDARD DETAILS
PROPOSED COMMERCIAL PARK
CRAIGHEAD COUNTY FAIRGROUNDS

