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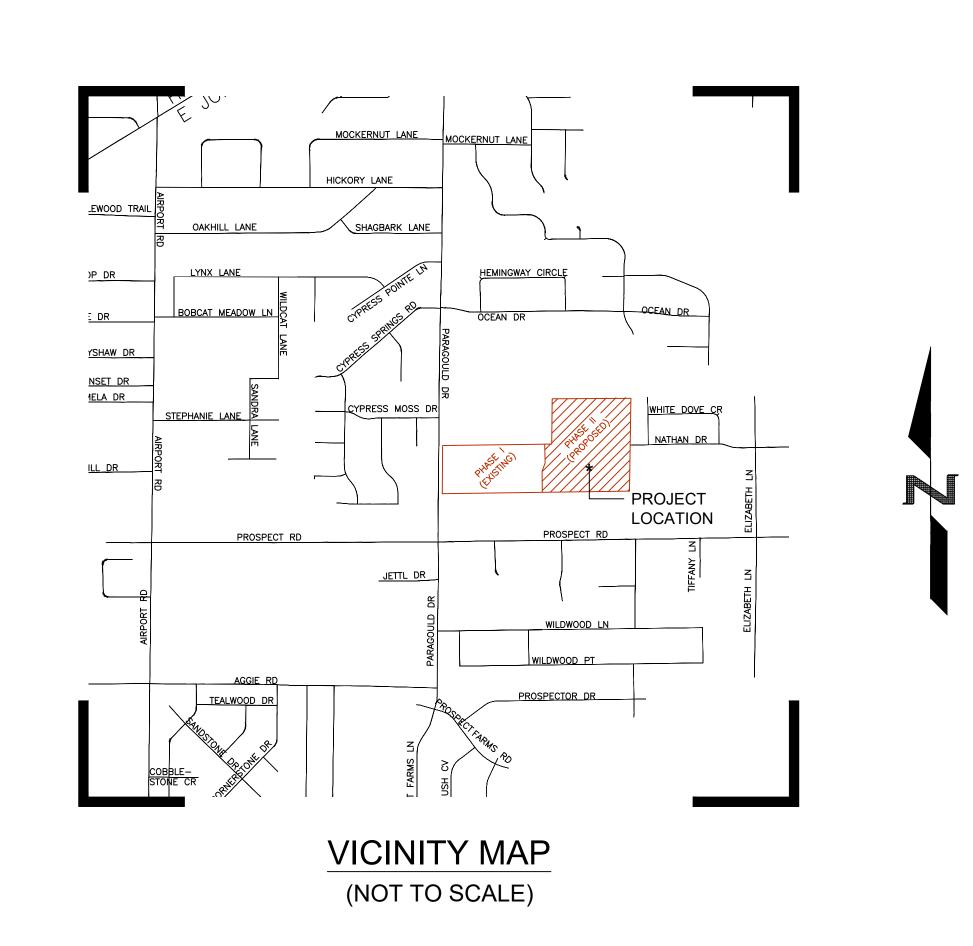
EDGEMONT PARK

EDGEMONT PARK PHASE II - SUBDIVISION PLANS


JONESBORO, CRAIGHEAD COUNTY, ARKANSAS


LOCAL CONTACTS

CITY OF JONESBORO	
ENGINEERING DEPT.	870-932-2438
CITY OF JONESBORO	
PLANNING AND ZONING	870-932-0406
CITY, WATER, & LIGHT	870-935-5581
AT&T	1-800-464-7928
RITTER COMMUNICATIONS	870-336-3400
SUDDENLINK	
COMMUNICATIONS	870-935-3615
CENTER POINT ENERGY	870-972-6682




INDEX OF SHEETS		
PAGE	DESCRIPTION	
C-1	COVER PAGE	
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OV-2	OVERALL UTILITY	
E-1	EROSION CONTROL	
WT-1	WATER PLAN	
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SW-2	SEWER PLAN&PROFILE	
GR-1	GRADING&DRAINAGE PLAN	
ST-1	STREET PLAN&PROFILE	
ST-2	STREET PLAN & PROFILE	
ST-3	STREET PLAN&PROFILE	
DT-1	EROSION CONTROL DETAILS	
DT-2	WATER DETAILS	
DT-3	SEWER DETAILS	
DT-4	STREET DETAILS	

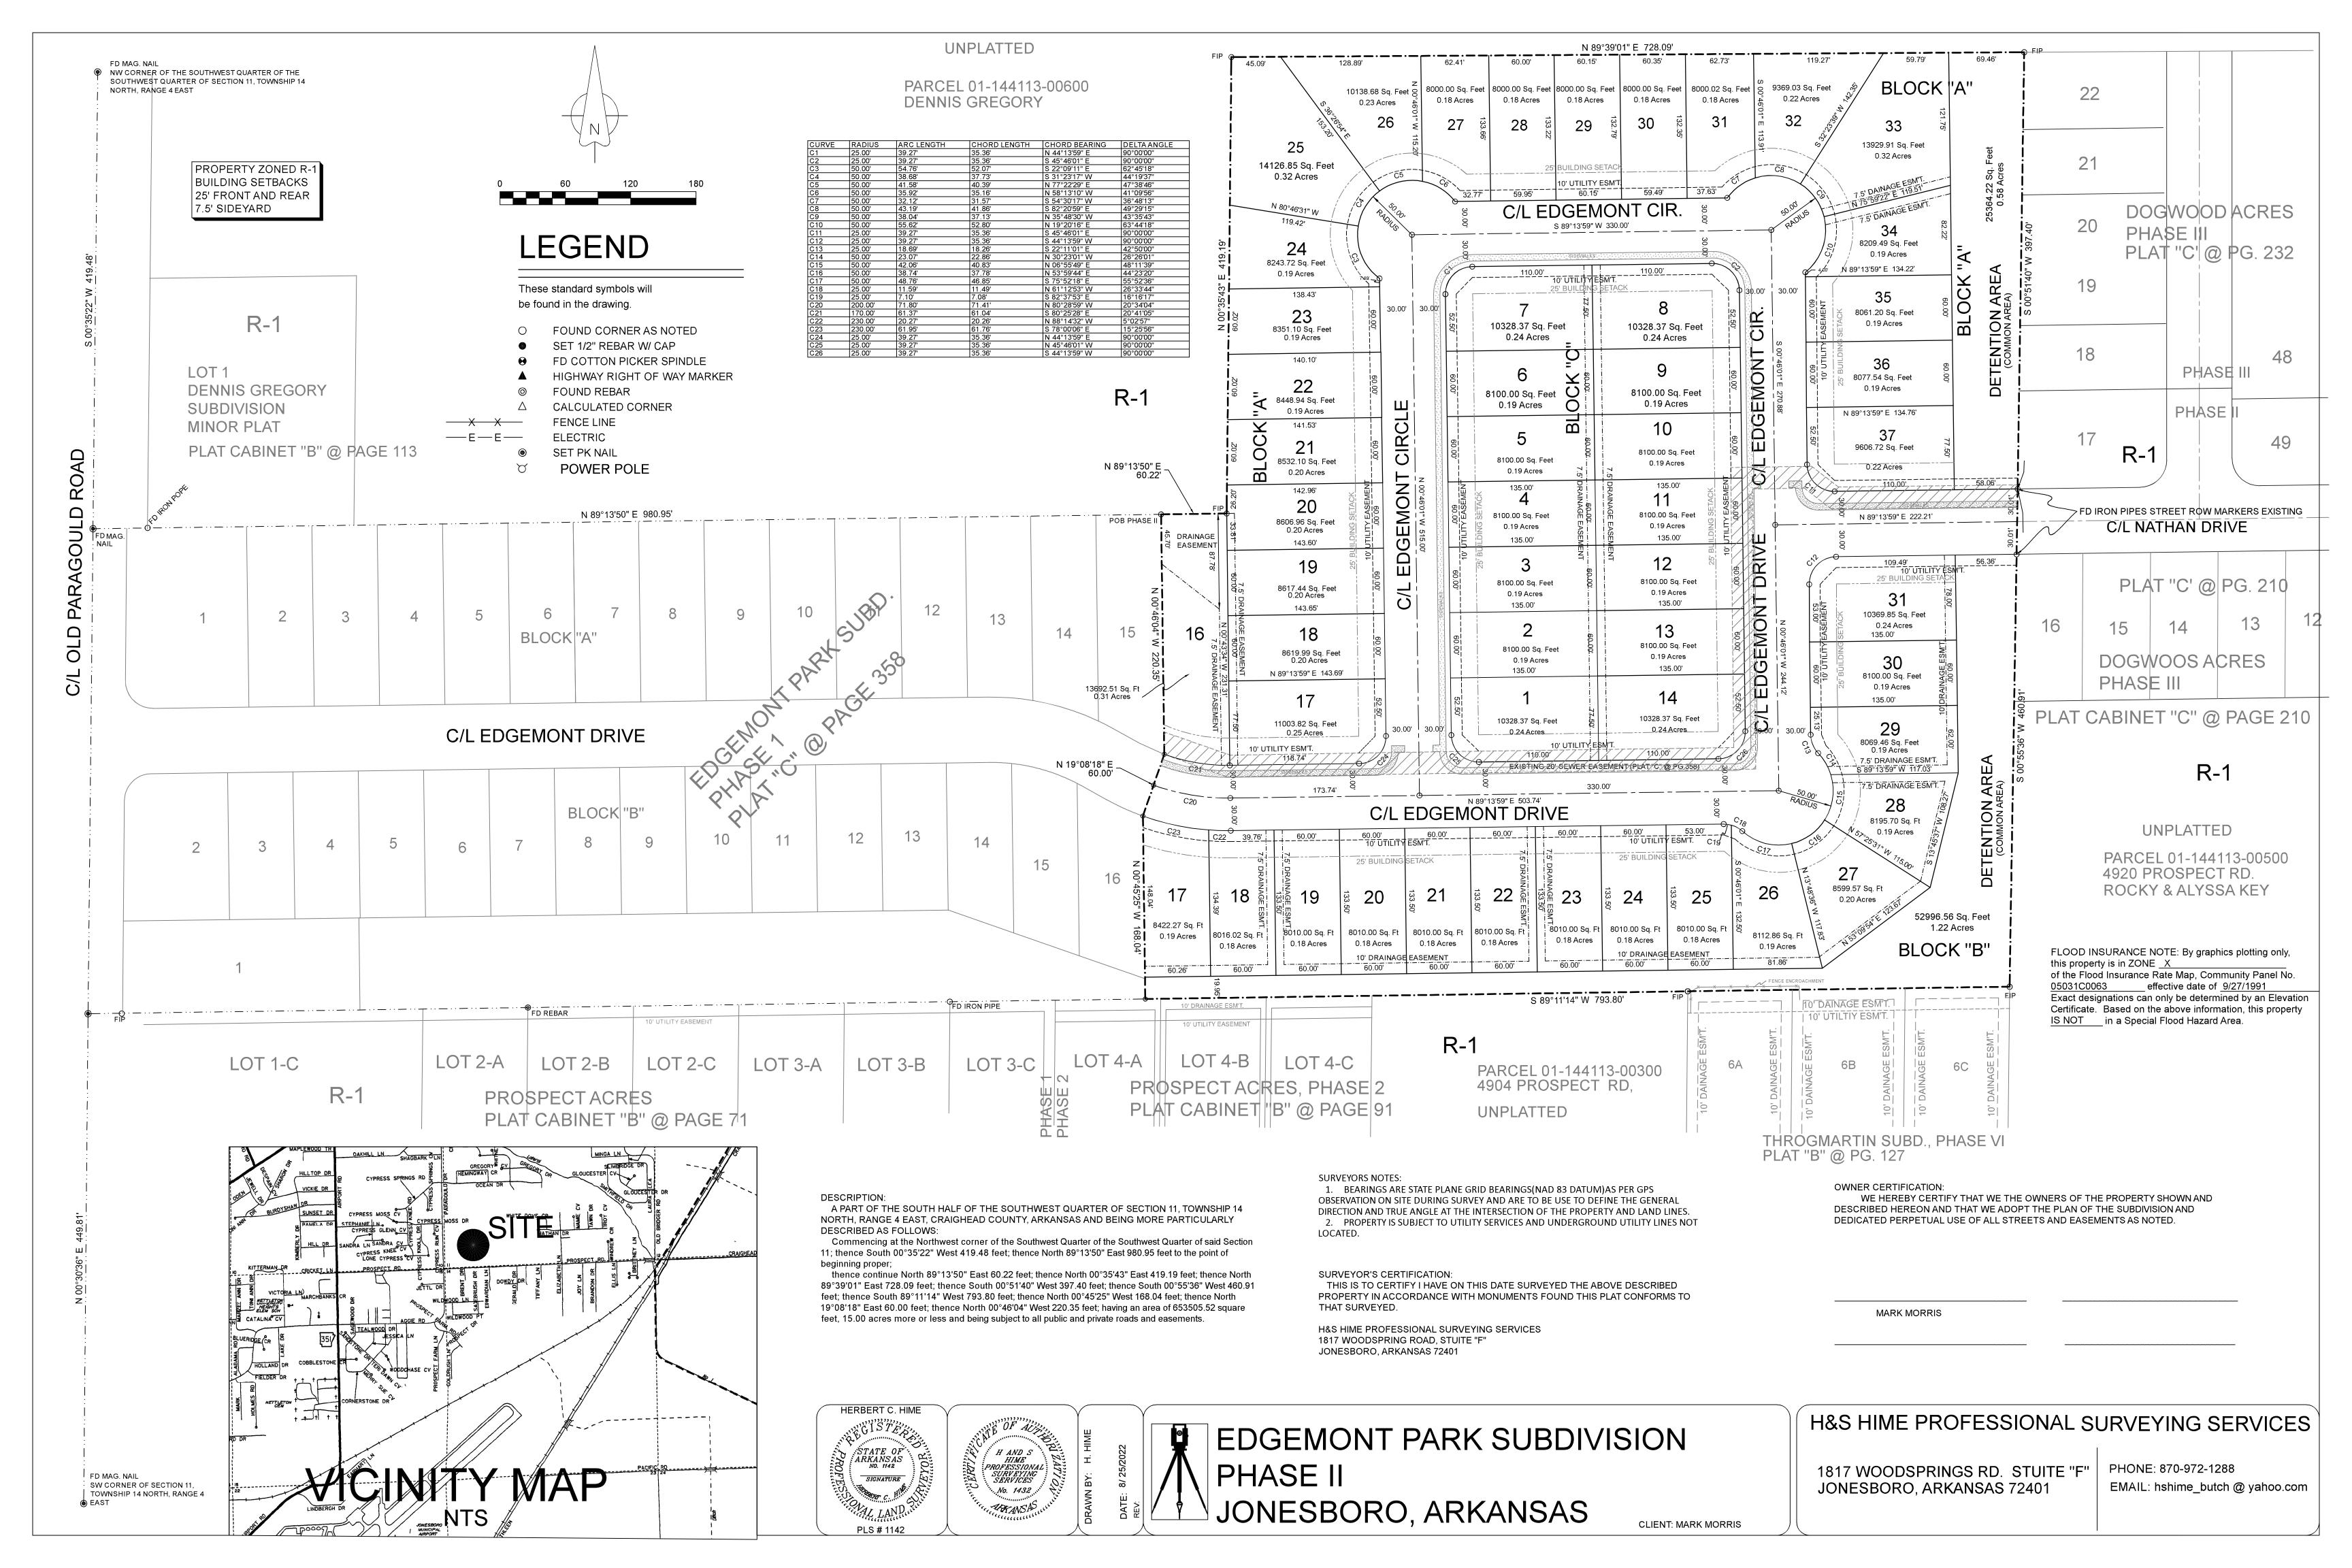

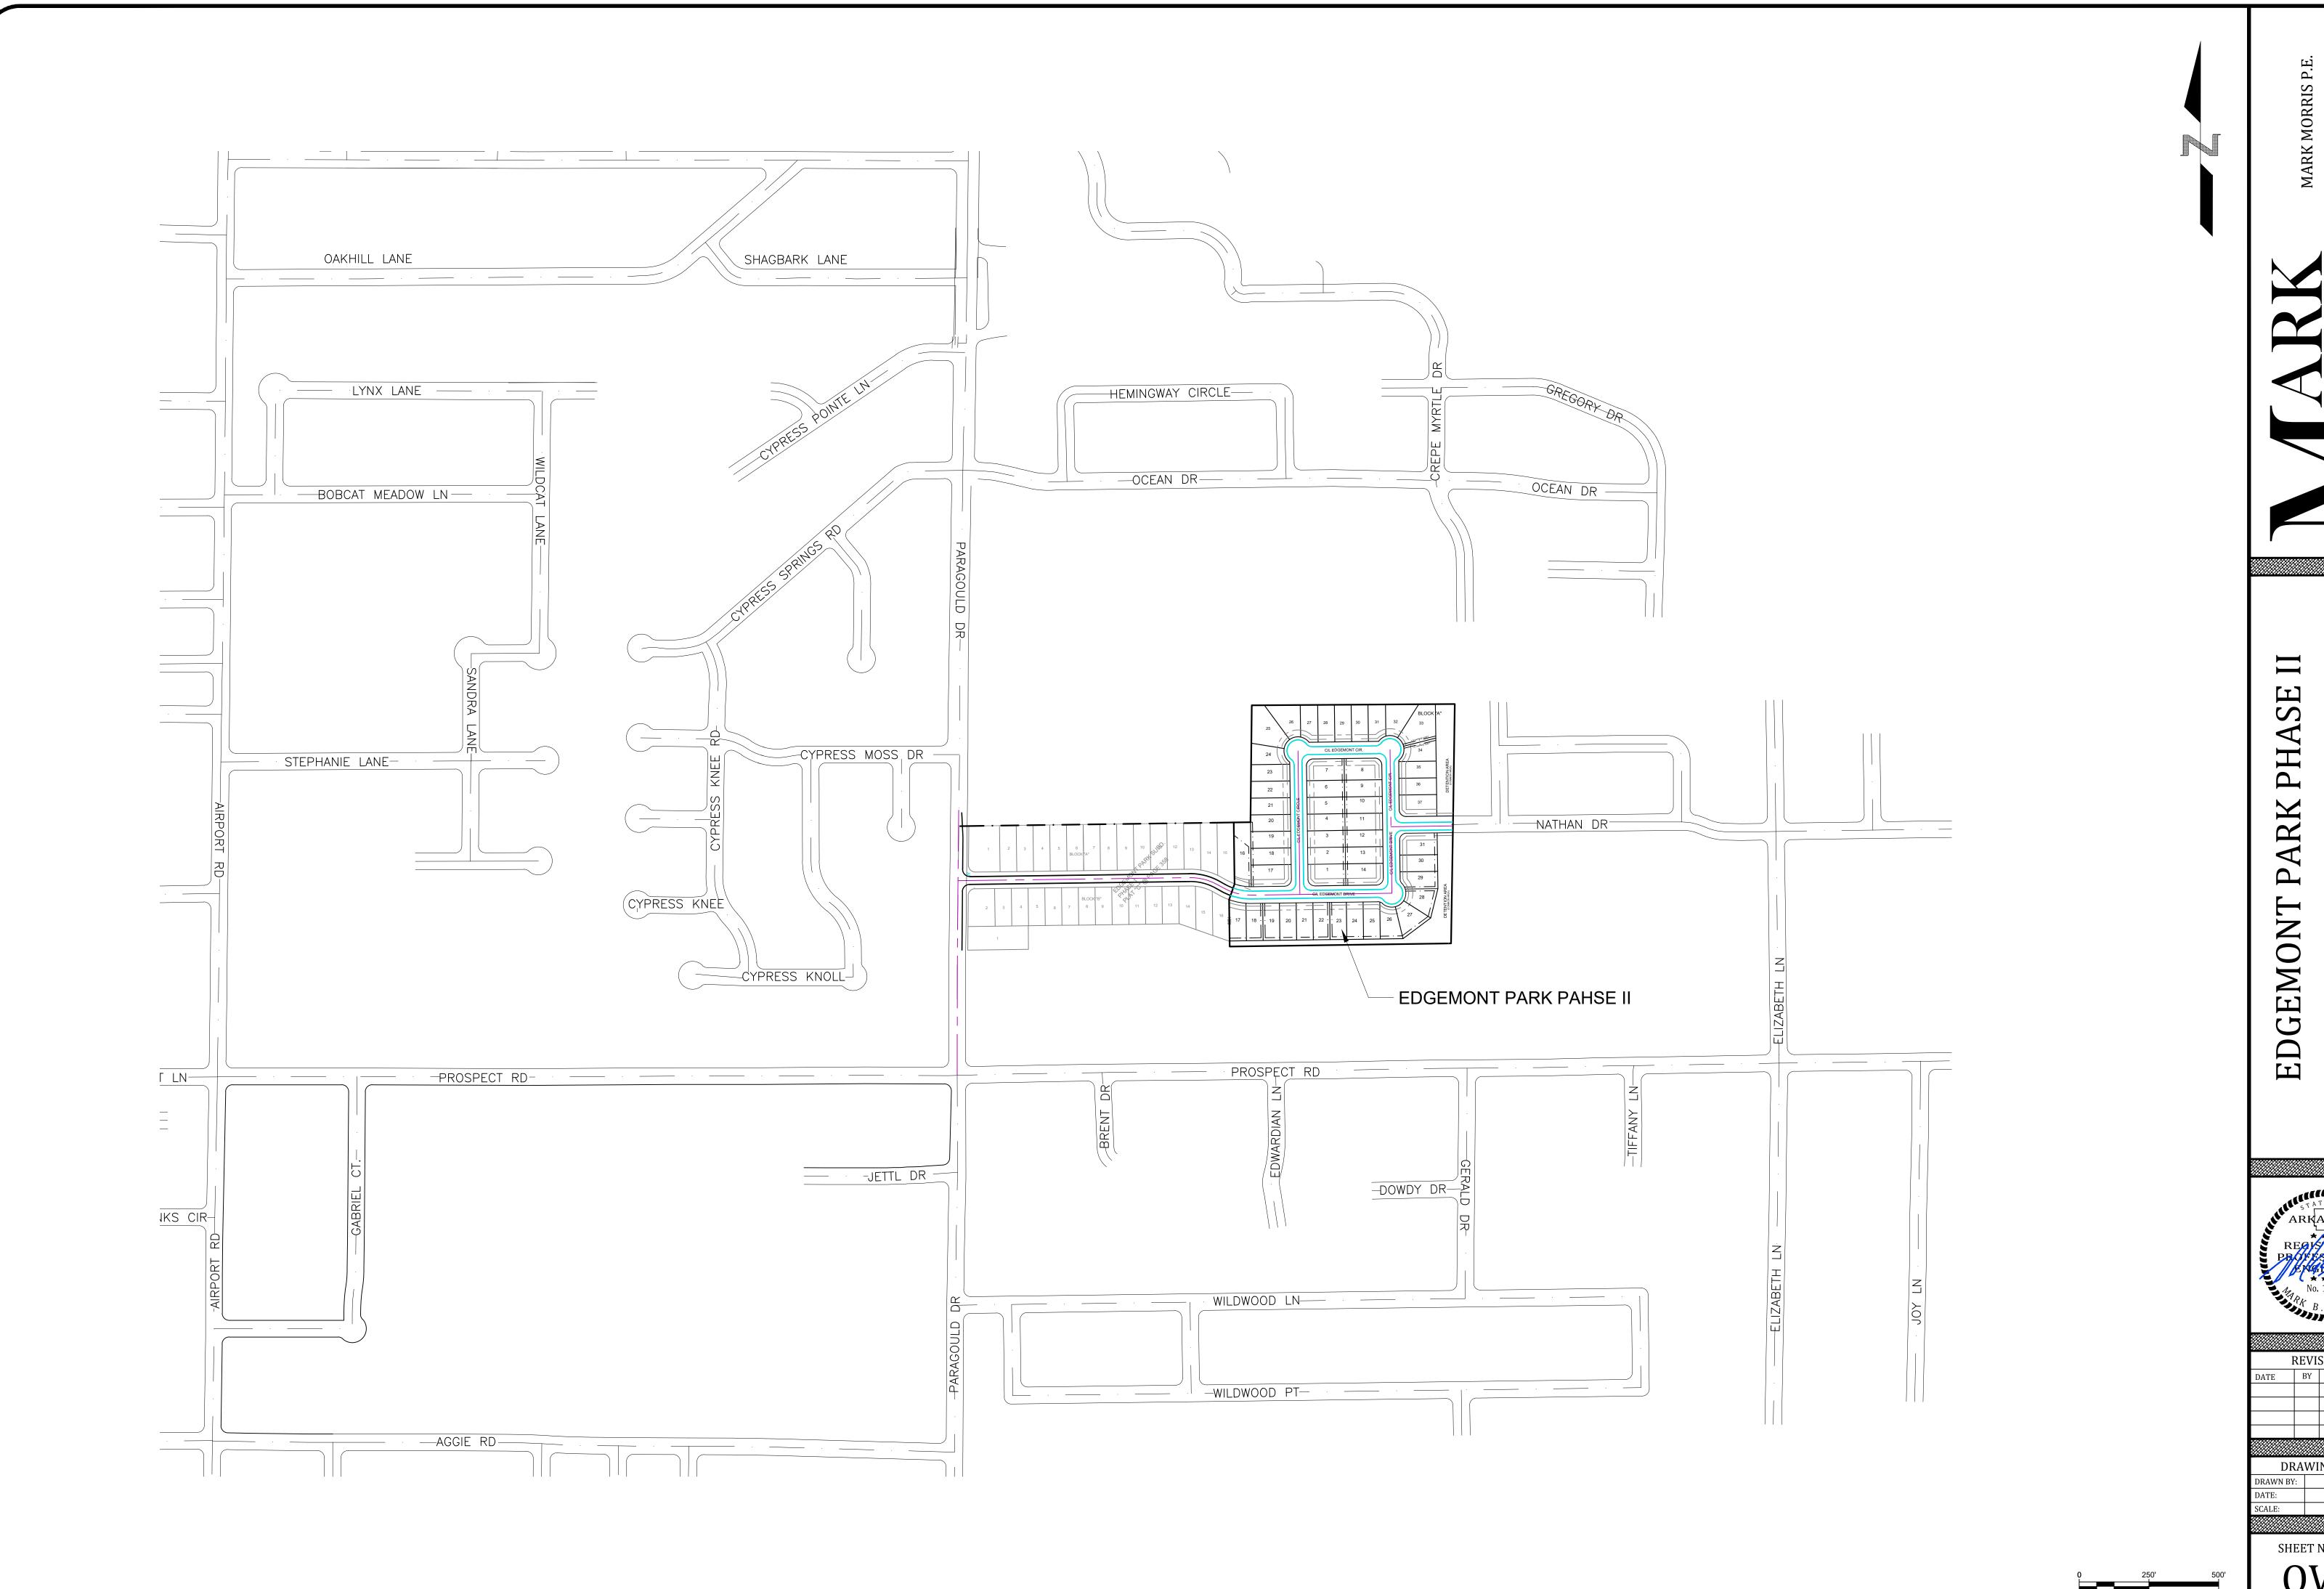

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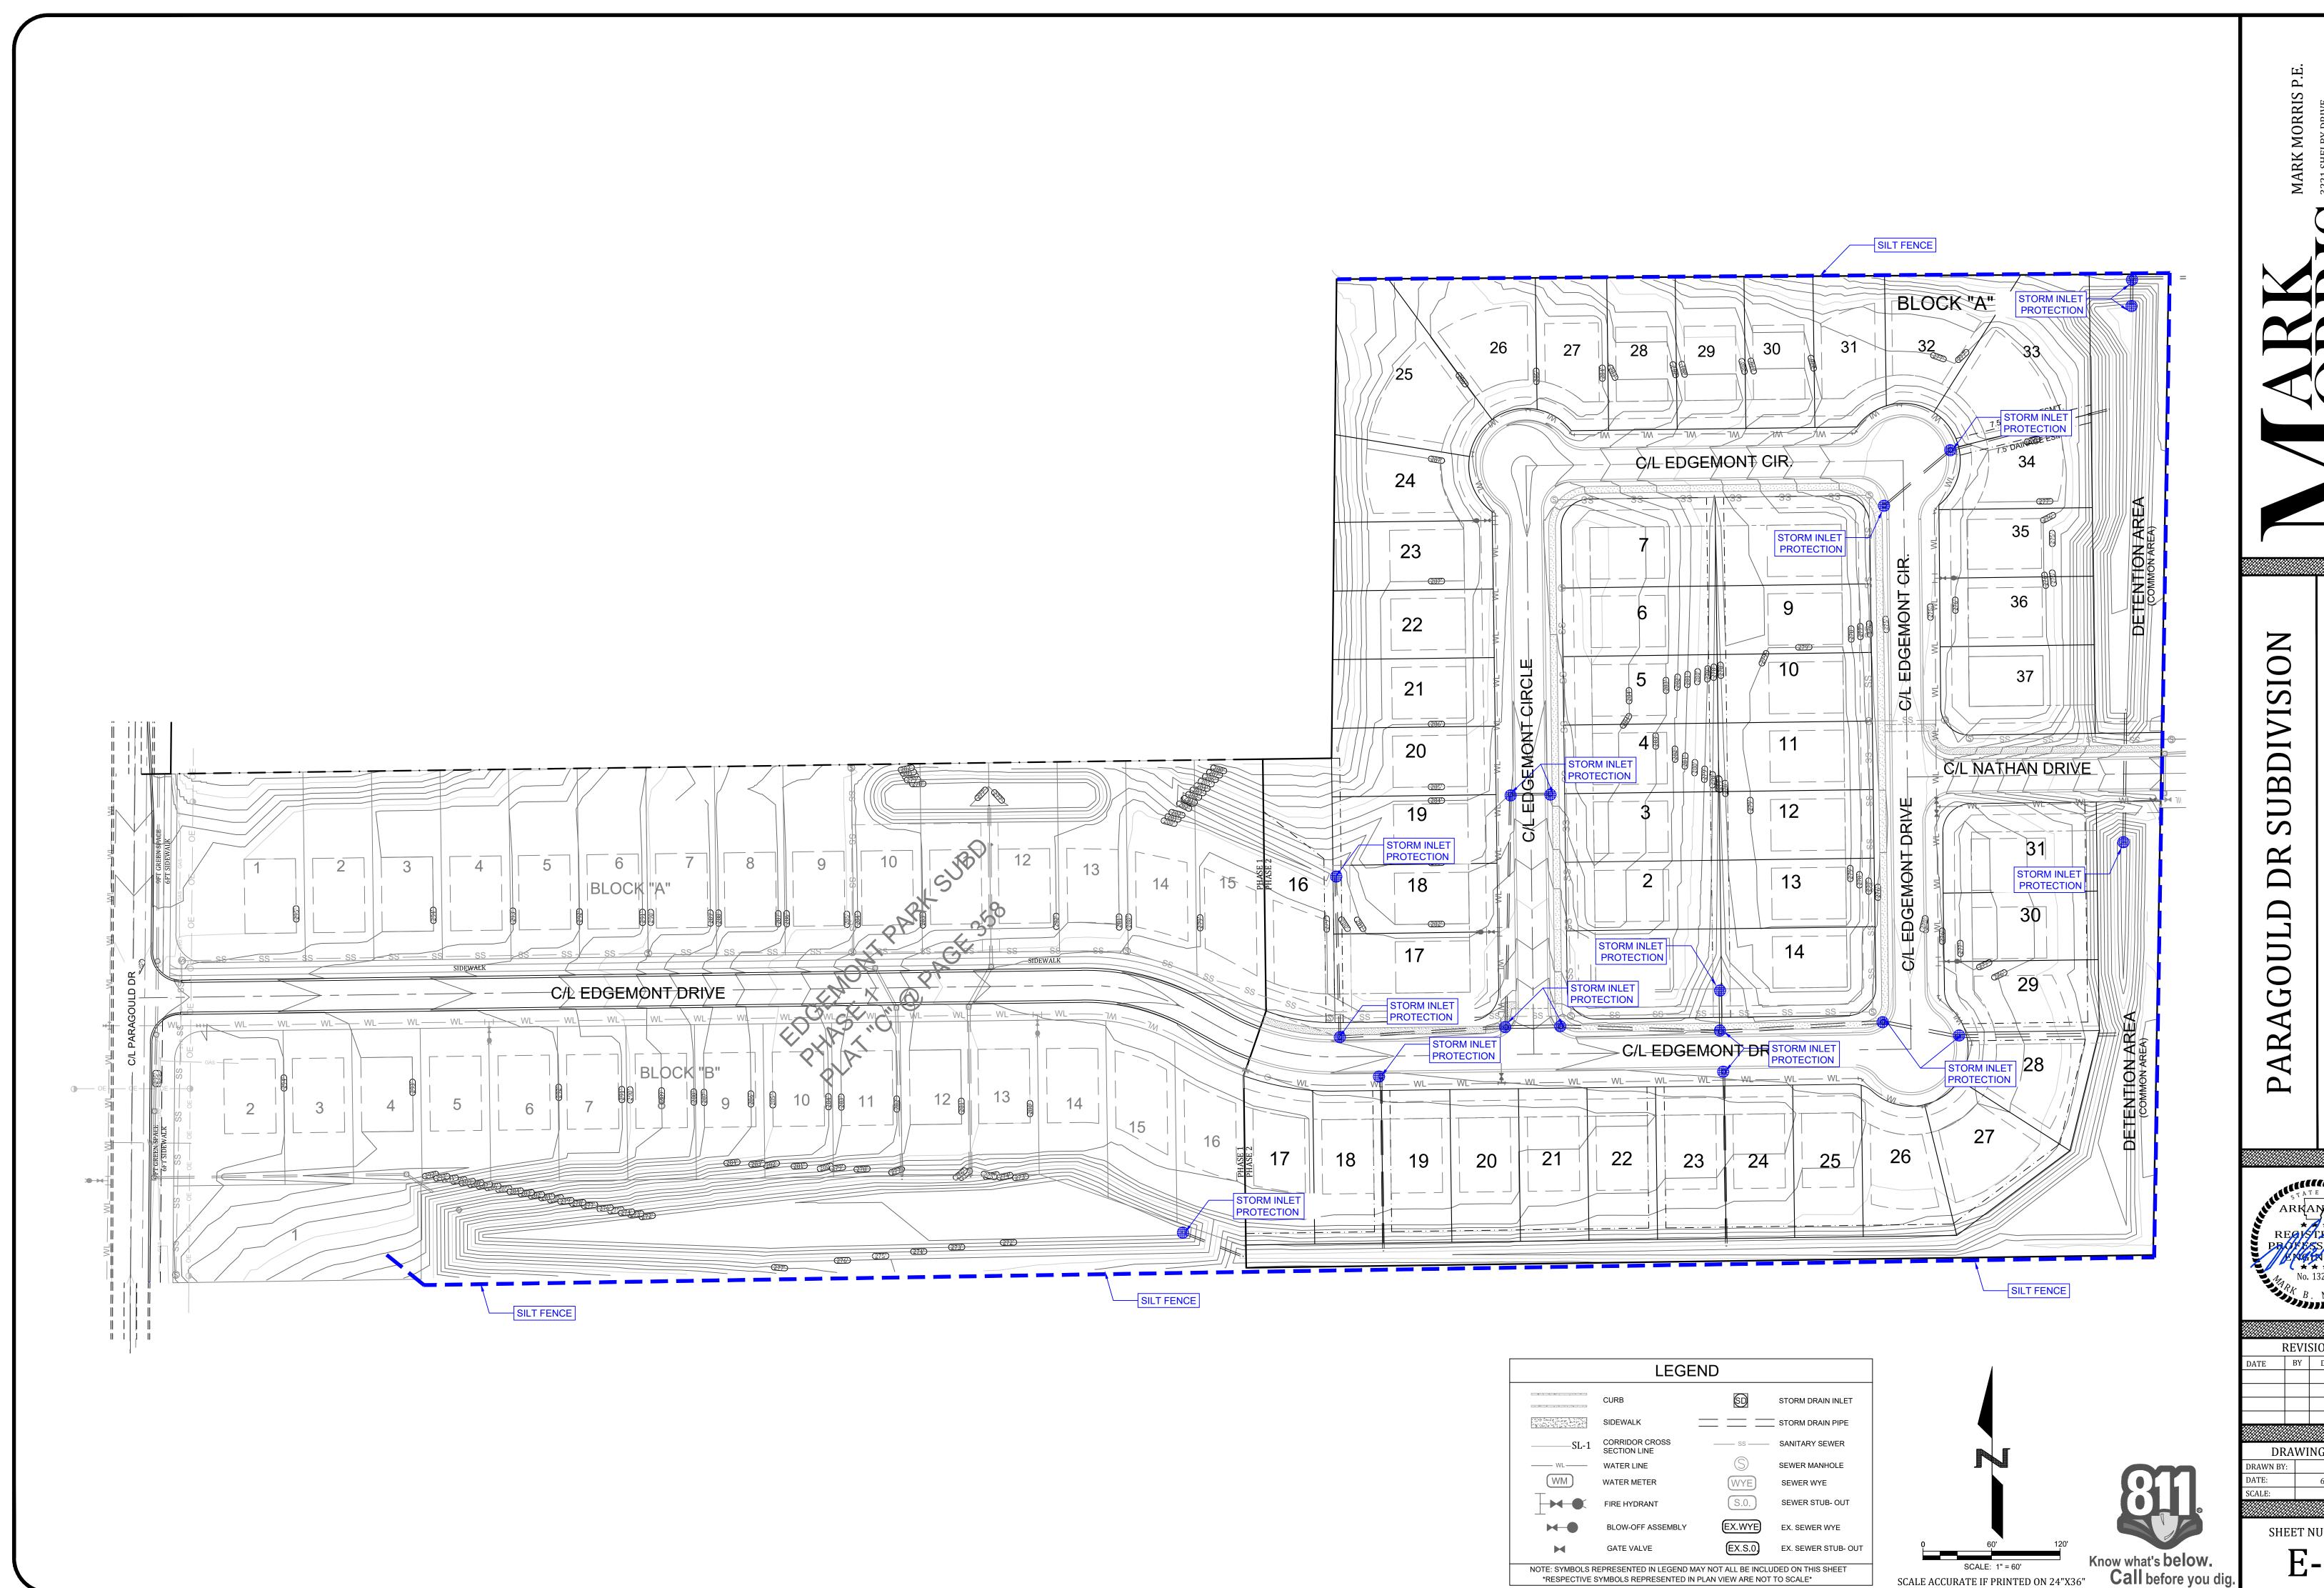


No. 1.
No. 1.
RR B. MON

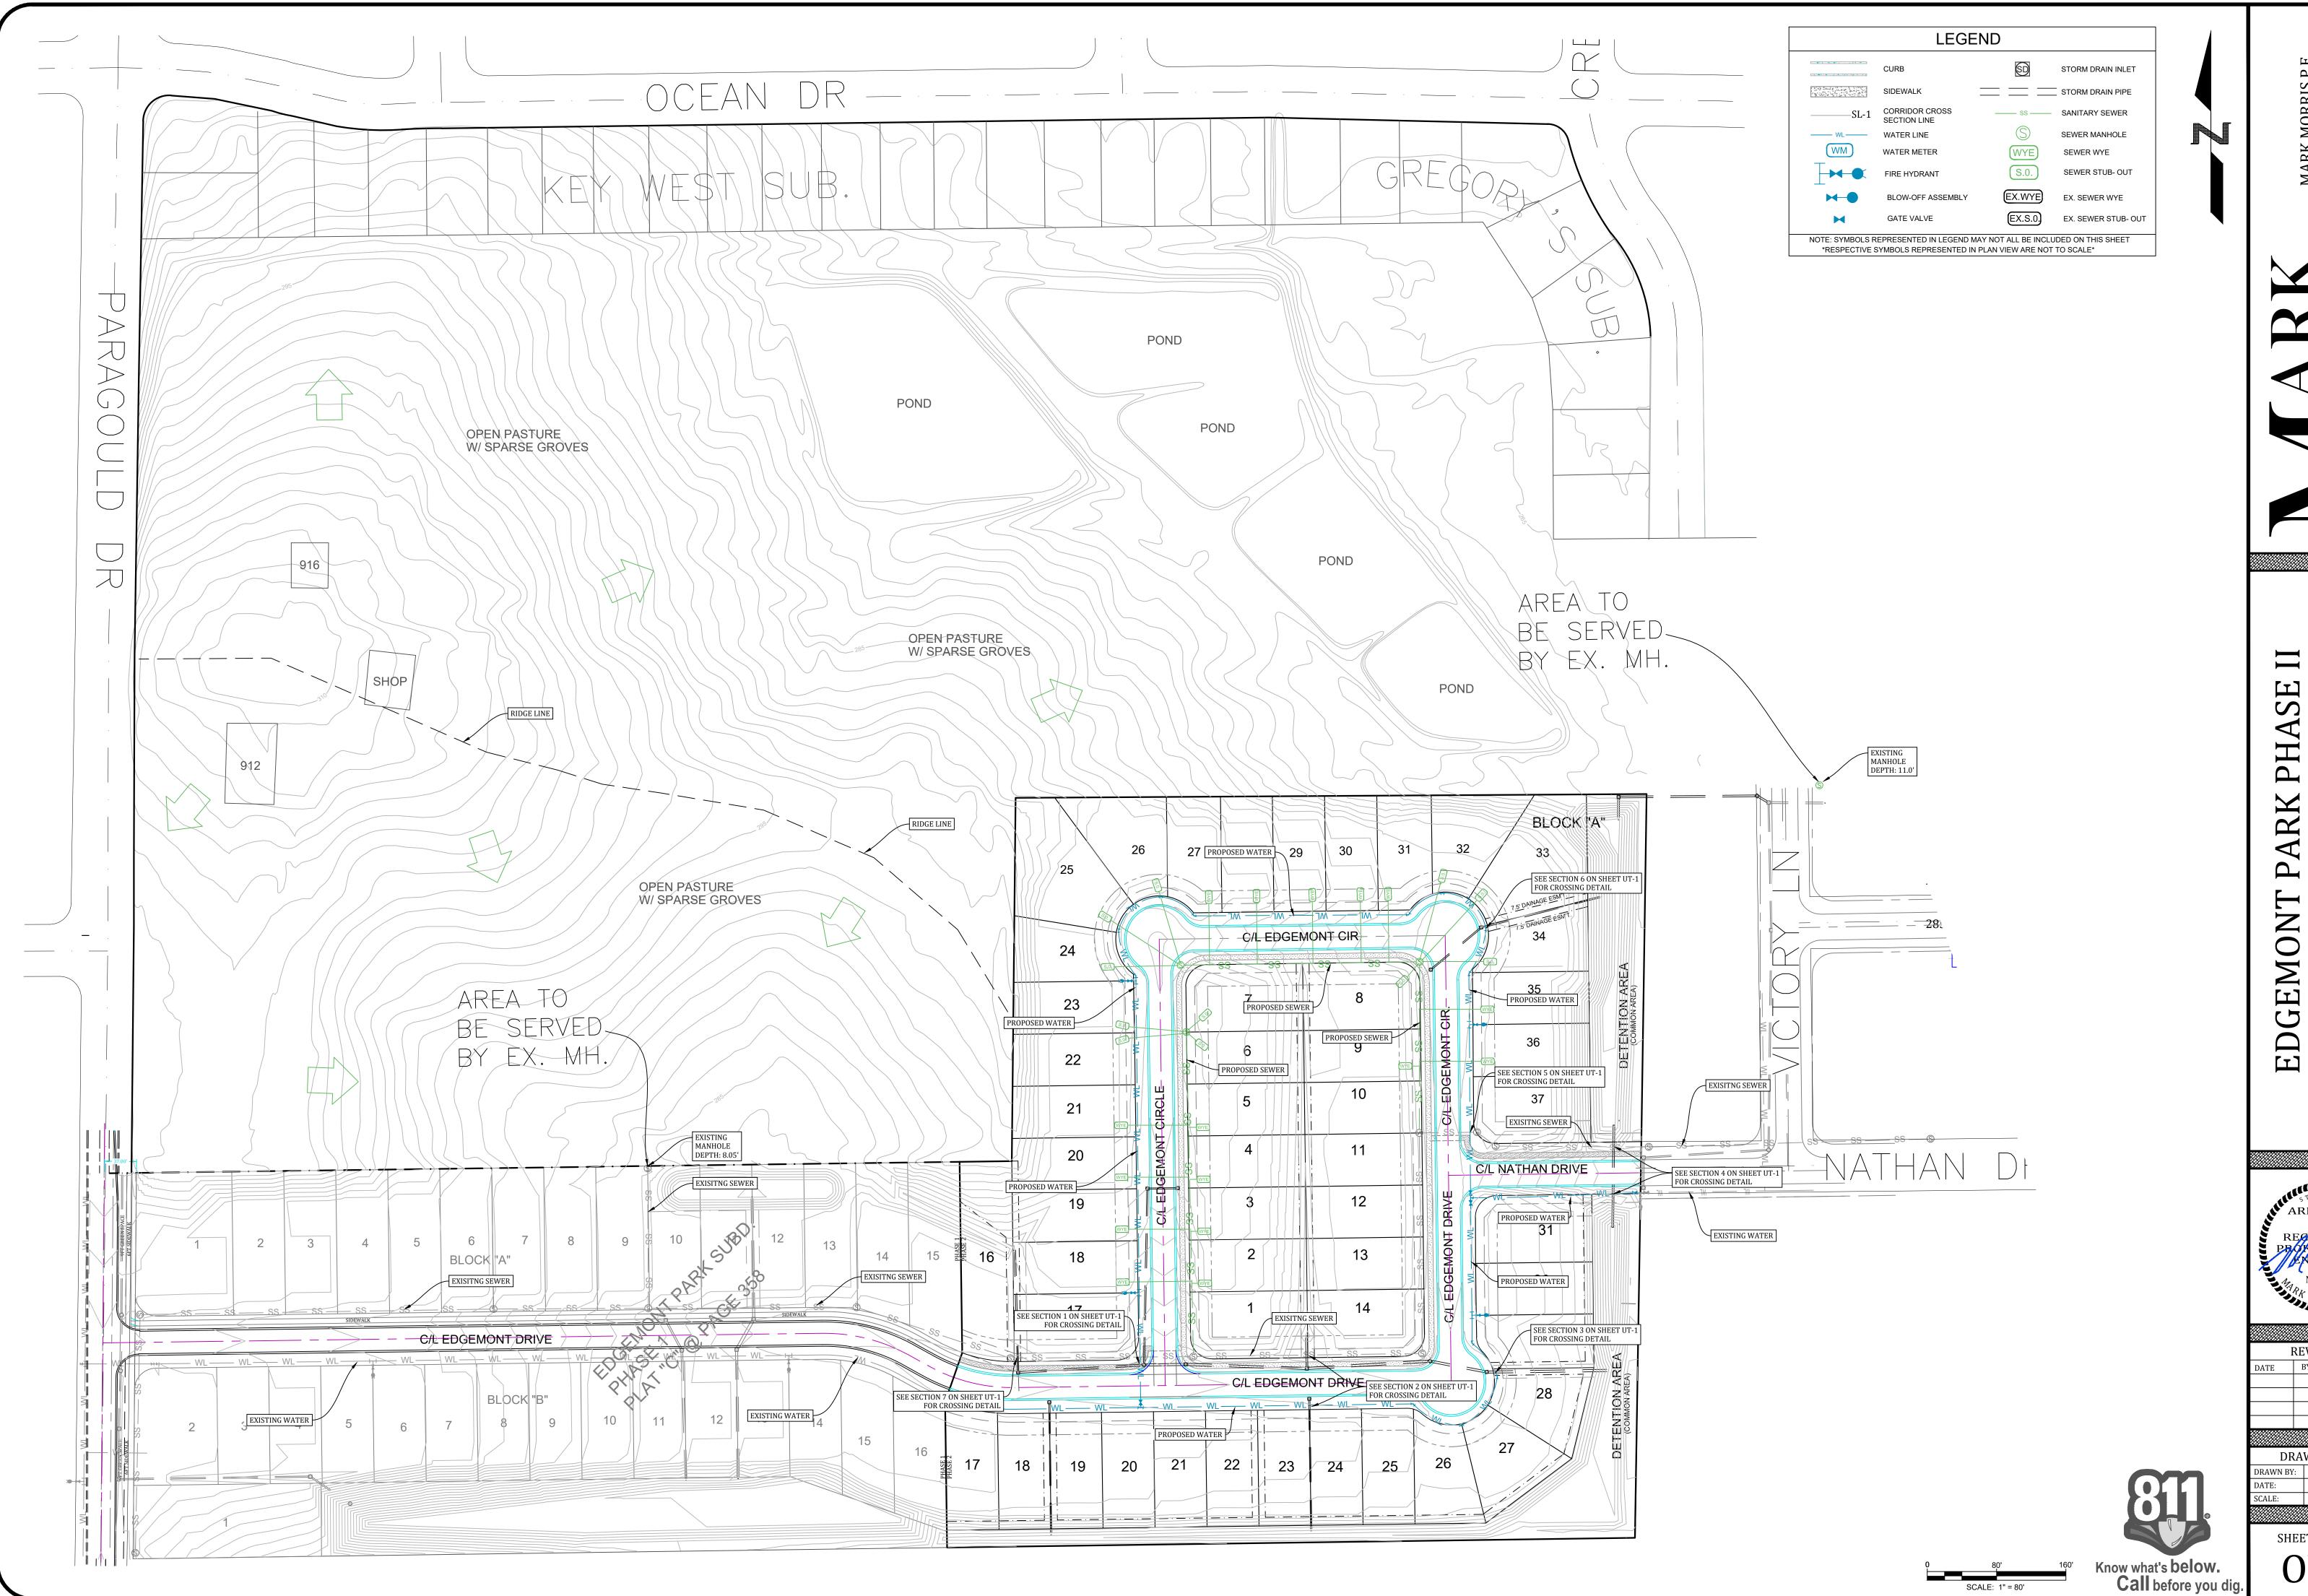I	REVI	SIONS
<u> </u>	BY	DESCRIPTION

DRAWING INFO.

9/6/2022 1"=80'



ONTROL

ARKANSAS REGISTERED PROFESSION ALL NO. 13212

No. 13212

ARK B. MORR

		111111111111111111111111111111111111111
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DATE	BY	DESCRIPTION

DRAWING INFO. GMD 6/1/2020 1"=??'

SHEET NUMBER:

E-1

	4111	7111111
	REVI	SIONS
DATE	BY	DESCRIPTION

DRAWING INFO.
RAWN BY: JMH
ATE: 9/6/2022

ATE: 9/6/2022
ALE: 1"=50'

SHFFT NIIMBER:

SHEET NUMBER:
UT-1

Know what's below.
Call before you dig.

SOUTHWEST INTERSECTION CROSSING

(CROSS SECTION 1)

280

275

24" RCP

30" RCP

30" RCP

44" RCP

30" RCP

44" RCP

30" RCP

44" RCP

30" RCP

45 AND 10" HORIZONTAL

SEPARATION

EXISTING 8" SEWER MAIN

270

270


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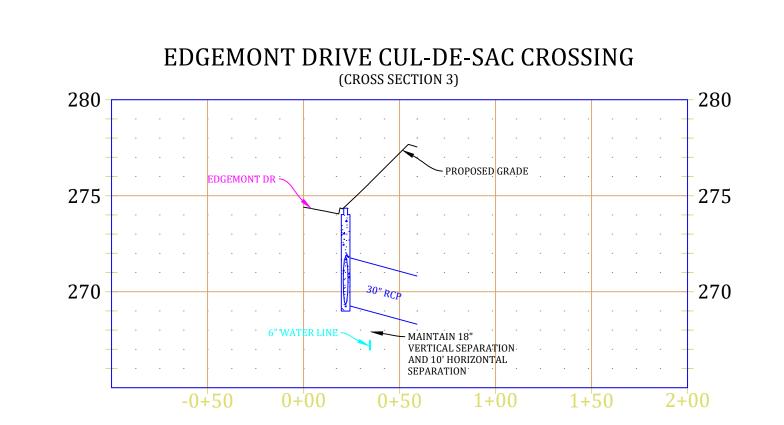
270

270

270

270



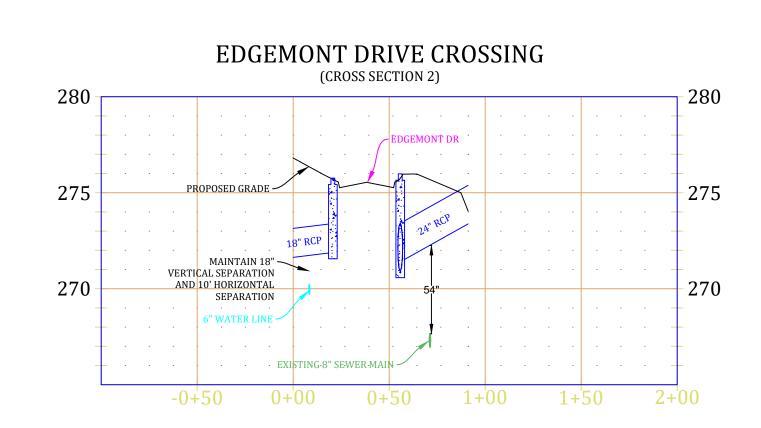

275

270

EDGEMONT CIRCLE CUL-DE-SAC CROSSING

MAINTAIN 18"

VERTICAL SEPARATION

AND 10' HORIZONTAL

SEPARATION


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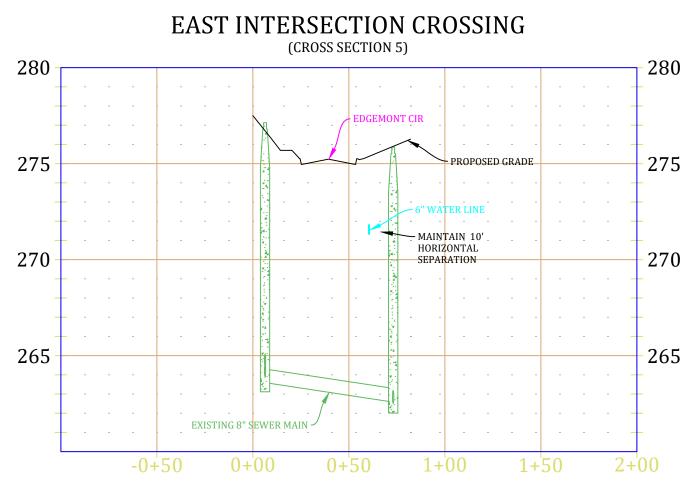
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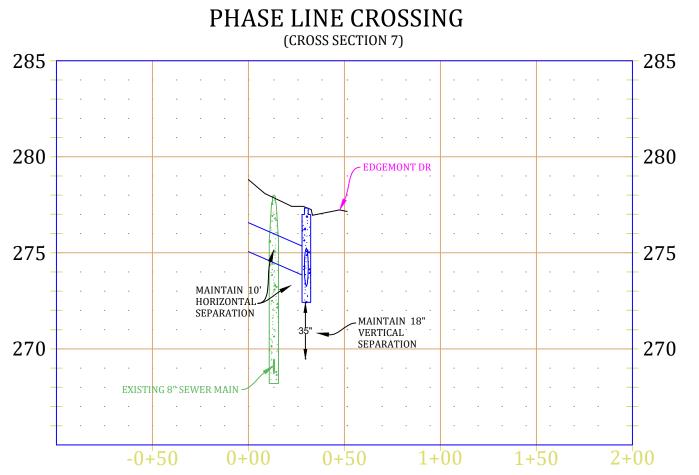
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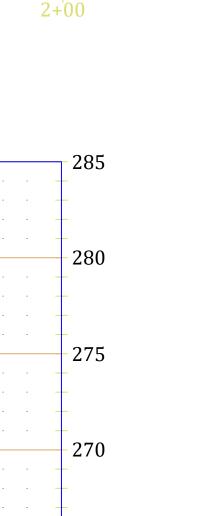
VERTICAL SCALE 1:5

HORIZONTAL SCALE 1:50







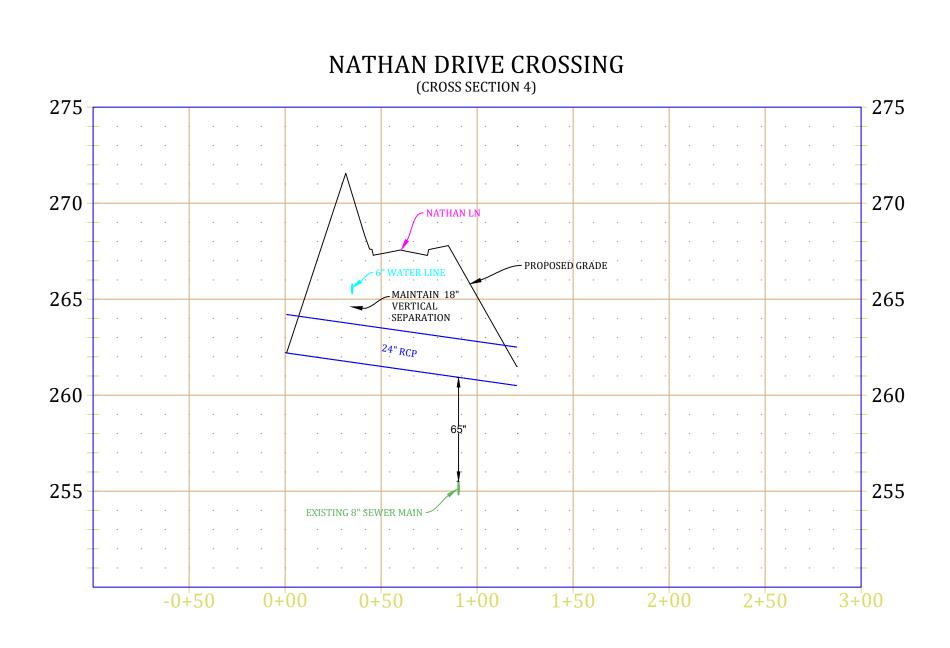

CONTAMINATION OF THE WATER IN THE DISTRIBUTION SYSTEM. WATER MAINS AND SANITARY SEWERS SHALL BE CONSTRUCTED AS FAR APART AS PRACTICABLE, AND SHALL BE SEPARATED BY UNDISTURBED AND COMPACTED |EARTH. A MINIMUM HORIZONTAL DISTANCE OF 10' SHOULD BE MAINTAINED| BETWEEN WATER LINES AND SEWER LINE OR OTHER SOURCES OF CONTAMINATION. WATER LINES AND SEWER SHALL NOT BE LAID IN THE SAME TRENCH EXCEPT OF THE WRITTEN APPROVAL OF THE ARKANSAS DEPARTMENT OF HEALTH. WATER MAINS NECESSARILY CLOSE PROXIMITY TO SEWERS MUST BE PLACED SO THAT THE BOTTOM OF THE WATERLINE WILL BE AT LEAST 18" ABOVE THE TOP OF THE SEWER LINE AT ITS HIGHEST POINT. IF THIS DISTANCE MUST UNAVOIDABLY BE REDUCED, THE WATER LINE OR THE SEWER LINE MUST BE ENCASED IN A WATERTIGHT PIPE WITH SEALED WATERTIGHT ENDS EXTENDING AT LEAST 10' EITHER SIDE OF THE CROSSING. ANY JOINT IN THE ENCASEMENT PIPE IS TO BE MECHANICALLY RESTRAINED. THE ENCASEMENT PIPE MAY BE VENTED TO THE SURFACE IF CARRYING WATER OR SEWER UNDER PRESSURE. WHERE A WATER LINE MUST UNAVOIDABLY PASS BENEATH THE SEWER LINE, AT LEAST 18" OF SEPARATION MUST BE MAINTAINED BETWEEN THE OUTSIDE OF THE TWO PIPES IN ADDITION TO THE PRECEDING ENCASEMENT REQUIREMENTS. EXCEPTIONS TO THIS MUST BE APPROVED IN WRITING BY THE ARKANSAS DEPARTMENT OF HEALTH. A MINIMUM HORIZONTAL DISTANCE OF 3' SHALL BE MAINTAINED BETWEEN WATER LINES AND OTHER UNDERGROUND UTILITIES OF A NON-SANITATRY NATURE (GAS, ELECTRIC, ETC.), EXCEPTIONS TO THIS MUST BE APPROVED IN WRITING BY THE ARKANSAS DEPARTMENT OF HEALTH AND HUMAN SERVICES.

CITY WATER & LIGHT IS NOT RESPONSIBLE FOR ANY SETTLEMENT OVER WATER

WATER METERS ARE SHOWN PICTORIALLY ONLY. WATER METERS SHALL BE LOCATED AT THE RIGHT OF WAY APPROXIMATELY AT THE

CENTER OF THE LOT. THERE SHOULD BE A MINIMUM OF 10 FEET SEPARATION BETWEEN WATER METERS AND SANITARY SEWER SERVICES.

CONTRACTOR SHALL NOT INITIATE TIE IN CONNECTION TO EXISTING WATER MAIN AFTER 3 P.M. DURING NORMAL WORKING DAYS OR ON FRIDAY AFTER 12 P.M., UNLESS APPROVED BY CITY WATER & LIGHT ENGINEERING DEPT. CONTRACTOR SHALL NOTIFY CWL INSPECTOR OF TENTATIVE TIME FRAME FOR CONNECTION 24 HOURS PRIOR TO ACTIVITY.

ALL SEWER WYES SHALL BE A MINIMUM OF 10' FOOT AWAY FROM PROPERTY

ELECTRICAL CONDUIT NOTE

ALL ELECTRICAL CONDUIT SHALL HAVE A MINIMUM 48" OF COVER BELOW FINISHED GRADE.

NO TRANSFORMER, JUNCTION BOX, OR PULL BOX TO BE PLACED OVER WATER FITTINGS WITHOUT CITY WATER AND LIGHT APPROVAL.

SEWER MANHOLE WATER LINE (WM) WATER METER SEWER WYE SEWER STUB- OUT (EX.WYE) **BLOW-OFF ASSEMBLY** EX. SEWER WYE EX.S.0.) EX. SEWER STUB- OUT **GATE VALVE** NOTE: SYMBOLS REPRESENTED IN LEGEND MAY NOT ALL BE INCLUDED ON THIS SHEET *RESPECTIVE SYMBOLS REPRESENTED IN PLAN VIEW ARE NOT TO SCALE* TOTAL WATERLINE QUANTITIES: | PRESSURES: 2405 LF - 6" C-900 PVC WATERLINE | STATIC PRESSURE = 81 PSI 36 - 3/4" SHORT SERVICES RESIDUAL PRESSURE = 71 PSI

LEGEND

SIDEWALK

CORRIDOR CROSS

SECTION LINE

STORM DRAIN INLET

____ STORM DRAIN PIPE

SANITARY SEWER

WATER AND ELECTRIC NOTES:

15 - 3/4" LONG SERVICES

PROVIDE MATERIAL COMPACTION TESTS AT 2' INTERVALS.

- 1. CONTRACTOR SHALL PROVIDE NECESSARY ELECTRICAL CONDUIT & PERMANENT MARKERS W/ GRAY PVC SCH 40 (2") & PVC SCH 40 (4") & 36" RAD ELBOWS FOR RISERS AND A STRING & MOUSE BLOWN IN THE CONDUIT. CONTRACTOR SHALL OBTAIN AN ELECTRICAL PLAN FROM CWL AND INSTALL THE ELECTRICAL CONDUIT AS SPECIFIED BY CWL.(CONTRACTOR SHALL OBTAIN CWL SPECIFICATIONS).
- 2. CONTRACTOR SHALL PROVIDE 3/4" METER STOP, TAP, SERVICE LINE & METER BOX AS REQUIRED BY CWL & INSTALL AS
- 3. CONTRACTOR SHALL PROVIDE ENGINEER W/ "AS-BUILT" DIMENSIONS FOR WYE'S, VALVES, TEES, BENDS, FIRE 4. CONTRACTOR SHALL PROVIDE LABOR AND MATERIALS FOR ALL SEWER, WATER, & ELECTRICAL LINE LATERALS & PROVIDE LABOR & MATERIAL TO BACKFILL ALL SEWER, WATER & ELECTRICAL STREET CUTS WITH SANDY MATERIAL (P.I. <15) TO TOP OF EXCAVATION & COMPACT FILL TO 95% COMPACTION & PROVIDE COMPACTION TESTS AT 2' INTERVALS. CONTRACTOR SHALL PROVIDE LABOR AND MATERIAL FOR ALL SEWER & WATER LINE MAINS THAT CROSS A STREET AND BACKFILL THEM WITH SANDY (P.I. <15) TO TOP OF EXCAVATION & COMPACT FILL TO 95% COMPACTION &
- 5. A 12 GA SOLID TRACER WIRE SHALL BE INSTALLED WITH WATER LINE MAIN WHERE. THERE SHALL BE A PERMANENT WATER LINE MARKER INSTALLED @ THE BEGINNING, THE END, AND 750' INTERVALS IN BETWEEN WHERE THE TRACER WIRE IS INSTALLED. THE TRACER WIRE SHALL BE INSTALLED ABOVE THE WATER LINE AND CONNECTED TO THE PERMANENT MARKERS IN A MANNER THAT WILL ENSURE A CONTINUOUS CONNECTION OF THE TRACER LINE.
- CONTRACTOR SHALL CALL ARK ONE CALL FOR LOCATES PRIOR TO CONSTRUCTION. 7. CWL SHALL PROVIDE FIRE HYDRANT, 6" D.I. GATE VALVE, VALVE BOX W/ LID, AND 6" BY LINE SIZE D.I. TEE. CONTRACTOR SHALL PROVIDE LABOR FOR INSTALLATION AND CONCRETE BLOCKING. (SEE DETAIL SHEET)
- 8. CONTRACTOR SHALL NOTIFY ENGINEER TO DETERMINE ELEVATIONS FOR MANHOLE TOPS, WATERLINE ELEVATION WHERE IT CROSSES PROPOSED STORM DRAINS, WATER METER BOX ELEVATIONS, VALVE BOX ELEVATIONS, AND FIRE HYDRANT ELEVATIONS, AND WATER LINE LOCATION AROUND INLETS. WATER LINE SHALL BE INSTALLED AT AN ELEVATION WHERE HYDRANTS ARE LOCATED TO ENSURE HYDRANT WILL BE AT PROPER HEIGHT WHEN FINISHED GRADE HAS BEEN OBTAINED.
- 9. CONTRACTOR SHALL FAMILIARIZE HIMSELF WITH PLANS TO ENSURE THE WATER LINE DEPTH OF INSTALLATION IS BELOW THE PROPOSED STORM DRAIN ELEVATION, CONTRACTOR WILL BE REQUIRED TO COME BACK AND LOWER NATER LINE (AT THE CONTRACTOR'S EXPENSE) IF IT INTERFERES WITH THE STORM DRAIN INSTALLATION.
- 10. IF CONTRACTOR CAN NOT ENSURE WATER LINE INSTALLATION TO BE BELOW STORM DRAIN, THEN THE CONTRACTOR SHALL POSTPONE WATER LINE INSTALLATION UNTIL STORM DRAIN HAS BEEN INSTALLED.
- 11. CONTRACTOR SHALL PROVIDE OWNER WITH ONE YEAR WARRANTY FOR MATERIALS AND WORKMANSHIP. 12. CONTRACTOR SHALL PROVIDE ENGINEER WITH LIEN RELEASES FOR MATERIALS AND LABOR; BACTERIAL SAMPLE RESULTS; AND MODEL & YEAR OF WATER LINE VALVES WITHIN 30 DAYS OF COMPLETION OF WORK.
- 13. CONTRACTOR SHALL DRESS UP PROJECT AFTER INSTALLATION TO THE CONDITION IT AS PRIOR TO BEGINNING CONSTRUCTION. MOUND BACKFILL OVER TRENCHES 1' TO 2' TO ALLOW FOR SETTLING IN AREAS OUT OF THE STREET.
- 14. CONTRACTOR SHALL REVIEW DETAIL SHEETS TO ENSURE PROPER INSTALLATION OF VALVES, FIRE HYDRANTS CONCRETE BLOCKING. SERVICE LINES. MANHOLE INVERTS. AND DROP ASSEMBLIES. 15. CONTRACTOR SHALL OBTAIN A CURRENT SET OF CWL SPECIFICATIONS AND REVIEW THEM. CWL SPECIFICATIONS ARE TO BE ADHERED TO AND MADE A PART OF THIS SET OF PLANS. CONTRACTOR SHALL USE CWL SPECIFICATIONS TO
- BE DISPOSED OF BY CONTRACTOR ON THE ADJACENT LOTS OR AS DIRECTED BY OWNER 16. ALL STREET EXCAVATION MATERIAL SHALL BE DISPOSED OF BY CONTRACTOR ON THE ADJACENT LOTS OR AS
- 17. CONTRACTOR SHALL PLACE 8 MIL POLYWRAP OVER DUCTILE IRON FITTINGS PRIOR TO PLACING CONCRETE BLOCKING TO PREVENT CONCRETE FROM ENCASING BOLTS & NUTS. 18. ALL WATER LINES 4"-12" DIAMETER SHALL BE AWWA C-900 PRESSURE CLASS 150 DR 18. ALL 2" AND 3" DIAMETER

INCLUDE ITEMS NOT SHOWN OR REFERRED TO IN THIS SET OF PLANS.18) ALL STREET EXCAVATION MATERIAL SHALL

- WATER LINES SHALL BE SDR 21 CLASS 200 (ASTM 2241). ALL SEWER LINES SHALL BE ASTM 2241 SDR-2
- 19. WATER LINE AND SANITARY SEWER LINE SHALL MAINTAIN 18" MINIMUM VERTICAL SEPARATION. WATER LINE AND STORM DRAIN SHALL MAINTAIN 36" MINIMUM HORIZONTAL SEPARATION TO PREVENT FREEZING. MAINTAIN 10' HORIZONTAL SEPARATION BETWEEN SEWER AND WATER LINE
- 20. CONSTRUCTION SHALL BEGIN ONLY AFTER APPROVED PLANS FROM THE ARKANSAS DEPARTMENT OF HEALTH ARE SUBMITTED TO CWL, AND ALL NECESSARY FEES ARE PAID IN FULL. CONSTRUCTION BY CONTRACTORS SHALL THEN BEGIN ONLY AFTER THE RIGHT OF WAY HAS BEEN CLEARED, THE ENTIRE SECTION STAKED, THE ELEVATIONS CAREFULLY CHECKED, AND A PRE-CONSTRUCTION MEETING HAS BEEN HELD. A POST CONSTRUCTION MEETING WILL BE HELD W/ CONTRACTOR PRESENT TO VERIFY ALL CONSTRUCTION IS ACCEPTABLE TO CWL PRIOR TO THE
- INSTALLATION OF ELECTRICAL WIRE. 21. DEVELOPER MUST SHOW PROOF OF ADEQUATE INSURANCE COVERAGE. (ARKANSAS WORKER'S COMPENSATION, \$1,000,000.00 MINIMUM GENERAL LIABILITY, AND \$1,000,000.00 MINIMUM AUTO LIABILITY.) CONTRACTOR MUST HAVE A STATE CONTRACTORS LICENSE. CONTRACTOR MUST HAVE A COMPETENT PERSON AT THE JOB SITE AS DEFINED BY
- 22. FINAL CLEAN-UP OF THE SITE SHALL INCLUDE THE REMOVAL AND DISPOSAL OFF-SITE OF ALL CONSTRUCTION DEBRIS, AND SURPLUS MATERIALS.
- 23. DURING CONSTRUCTION, WORK SHALL BE INSPECTED BY THE DEVELOPER'S CONSULTING ENGINEER FOR NECESSARY SAFETY PRACTICES, PROPER MATERIALS, AND WORKMANSHIP. CWL WILL PROVIDE RANDOM INSPECTIONS TO ENSURE THAT THE PLANS APPROVED BY THE ARKANSAS DEPARTMENT OF HEALTH AND CWL ARE FOLLOWED CONCERNING WORKMANSHIP AND MATERIALS.
- 24. IF SEWER AND WATER LINES HAVE NOT BEEN ACCEPTED BY CWL WITHIN 360 DAYS AFTER MANDREL TESTS, LOW PRESSURE AIR TESTS, HYDROSTATIC TESTS AND BACTERIAL TESTS, ALL TESTS WILL BE REQUIRED TO BE REPEATED
- 25. INSTALLATION OF DOMESTIC WATER METER TAPS ARE REQUIRED TO BE MADE DURING THE INSTALLATION OF THE NEW 26. OBSTRUCTING DRAINAGE PIPES, SHALL BE REMOVED. IF IN SOUND, UNDAMAGED CONDITION, THEY MAY BE CLEANED AND RE-INSTALLED. IF UNSOUND OR DAMAGED, THEY SHALL BE REPLACED WITH THE SAME TYPE OF MATERIAL. WHEN THE ANGLE BETWEEN CENTER LINES OF A DRAINAGE PIPE AND WATER MAIN WILL PERMIT, THE WATER MAIN MAY BE INSTALLED BY TUNNELING, PROVIDED THE DRAINAGE PIPE IS NOT DAMAGED AND THE WATER MAIN IS LAID PROPERLY. AS AN ALTERNATIVE IN THE CASE OF CORRUGATED METAL PIPE, A SECTION MAY BE CUT FROM THE DRAINAGE PIPE,
- AND RESTORATION ACCOMPLISHED WITH NEW PIPE AND COUPLING BANDS. 27. CWL ENGINEERING DEPT. MUST APPROVE ANY WATER OR SEWER LINES THAT WILL BE INSTALLED CLOSER THAN 5' PARALLEL WITH EDGE OF PAVED STREET SURFACE.
- 28. REPAIRS SHALL BE MADE IN ACCORDANCE WITH AWWA. IF VALVE IS CLOSED BY THE CONTRACTOR WITHOUT CWL'S KNOWLEDGE, THE NEW SECTION MUST BE TESTED FOR WATER QUALITY AND FLUSHED. THE CWL INSPECTOR WILL
- WITNESS ALL REPAIRS. 29. WATER LINE FITTINGS SHALL BE CLASS 350 DUCTILE IRON OR CAST IRON. 30. TRENCH DEPTH WILL BE SUCH AS TO ALLOW A MINIMUM COVER OF 42" OVER WATER MAIN.
- 31. LEAKAGE TESTS SHALL BE MADE PRIOR TO STERILIZATION OPERATIONS. THE TEST PERIOD SHALL BE TWO (2) HOURS. TEST PRESSURE SHALL BE 1.5 TIMES THE CALCULATED WORKING PRESSURE OF THE MAIN, BUT NOT LESS THAN 100. PSI. THE LINE WILL NOT BE ACCEPTED UNLESS OR UNTIL THE TOTAL IS LESS THAN THAT SPECIFIED IN AWWA C-600-93
- FOR DUCTILE IRON AND AWWA C-605-94 FOR PVC PIPE. 32. ALL WATER LINES SHALL BE STERILIZED IN ACCORDANCE WITH AWWA C-651-94. ANY NEW CONSTRUCTION OR REPAIRED WATER MAIN MUST BE THOROUGHLY CLEANED (FLUSHED), DISINFECTED, AND TESTED FOR BACTERIOLOGICAL QUALITY BEFORE IT CAN BE PLACED IN SERVICE. FOLLOWING A CONTACT PERIOD OF NOT LESS THAN 24 HOURS, THE CHLORINATED WATER SHALL BE FLUSHED FROM THE SYSTEM, AND THE SYSTEM FILLED WITH WATER OF NORMAL CHLORINE CONTENT. SAMPLES OF WATER THEN SHALL BE TAKEN ON TWO CONSECUTIVE DAYS FROM THE LINES AND DELIVERED TO THE CWL - LABORATORY FOR BACTERIAL ANALYSIS. THIS PROCESS SHALL BE CONTINUED UNTIL THE SAMPLES SHOW THE WATER IS SAFE FOR DOMESTIC REQUIREMENTS. FLUSHING DEVICES SHOULD BE SIZED TO PROVIDE FLOWS WHICH WILL GIVE A VELOCITY OF AT LEAST 2.5 FEET PER SECOND IN THE WATER MAIN BEING FLUSHED. NO FLUSHING DEVICE SHALL BE DIRECTLY CONNECTED TO ANY SEWER. IF THE LINE HAS SET FOR A ONE MONTH OR LONGER BEFORE FINAL ACCEPTANCE, IT SHALL BE RESTERILIZED, FLUSHED, AND
- 33. THE DEVELOPER AND ENGINEER ARE RESPONSIBLE FOR METER BOX LOCATIONS. ANY CONFLICTS THAT REQUIRE PLASTIC BOX(S) TO BE CHANGED OUT TO CONCRETE BOX(S) WILL BE AT THE EXPENSE OF THE DEVELOPER AND/ OR CONTRACTOR
- 34. IF UNSAFE PRACTICES ARE DISCOVERED BY CWL DURING INSPECTIONS OF WORKMANSHIP AND MATERIALS. CWL WILL NOTIFY OSHA. THIS PROCEDURE IN NO WAY OBLIGATES CWL FOR THE RESPONSIBILITY OF THE CONTRACTOR'S SAFETY
- 35. DURING CONSTRUCTION, WORK SHALL BE INSPECTED DAILY BY THE ENGINEER OF RECORD FOR PROPER MATERIALS, WORKMANSHIP, AND INSTALLATION IN ACCORDANCE WITH THE APPROVED ARKANSAS DEPARTMENT OF HEALTH AND CITY WATER AND LIGHT APPROVED PLANS.



Know what's **below** Call before you dig

REGISTERED PROFESSIONAL ENGENEER No. 13212 ARK B. MU REVISIONS BY DESCRIPTION DRAWING INFO.

Alliterate

ARKANSAS

9/6/2022 1"=50'

STORM DRAIN INLET

____ STORM DRAIN PIPE

LEGEND

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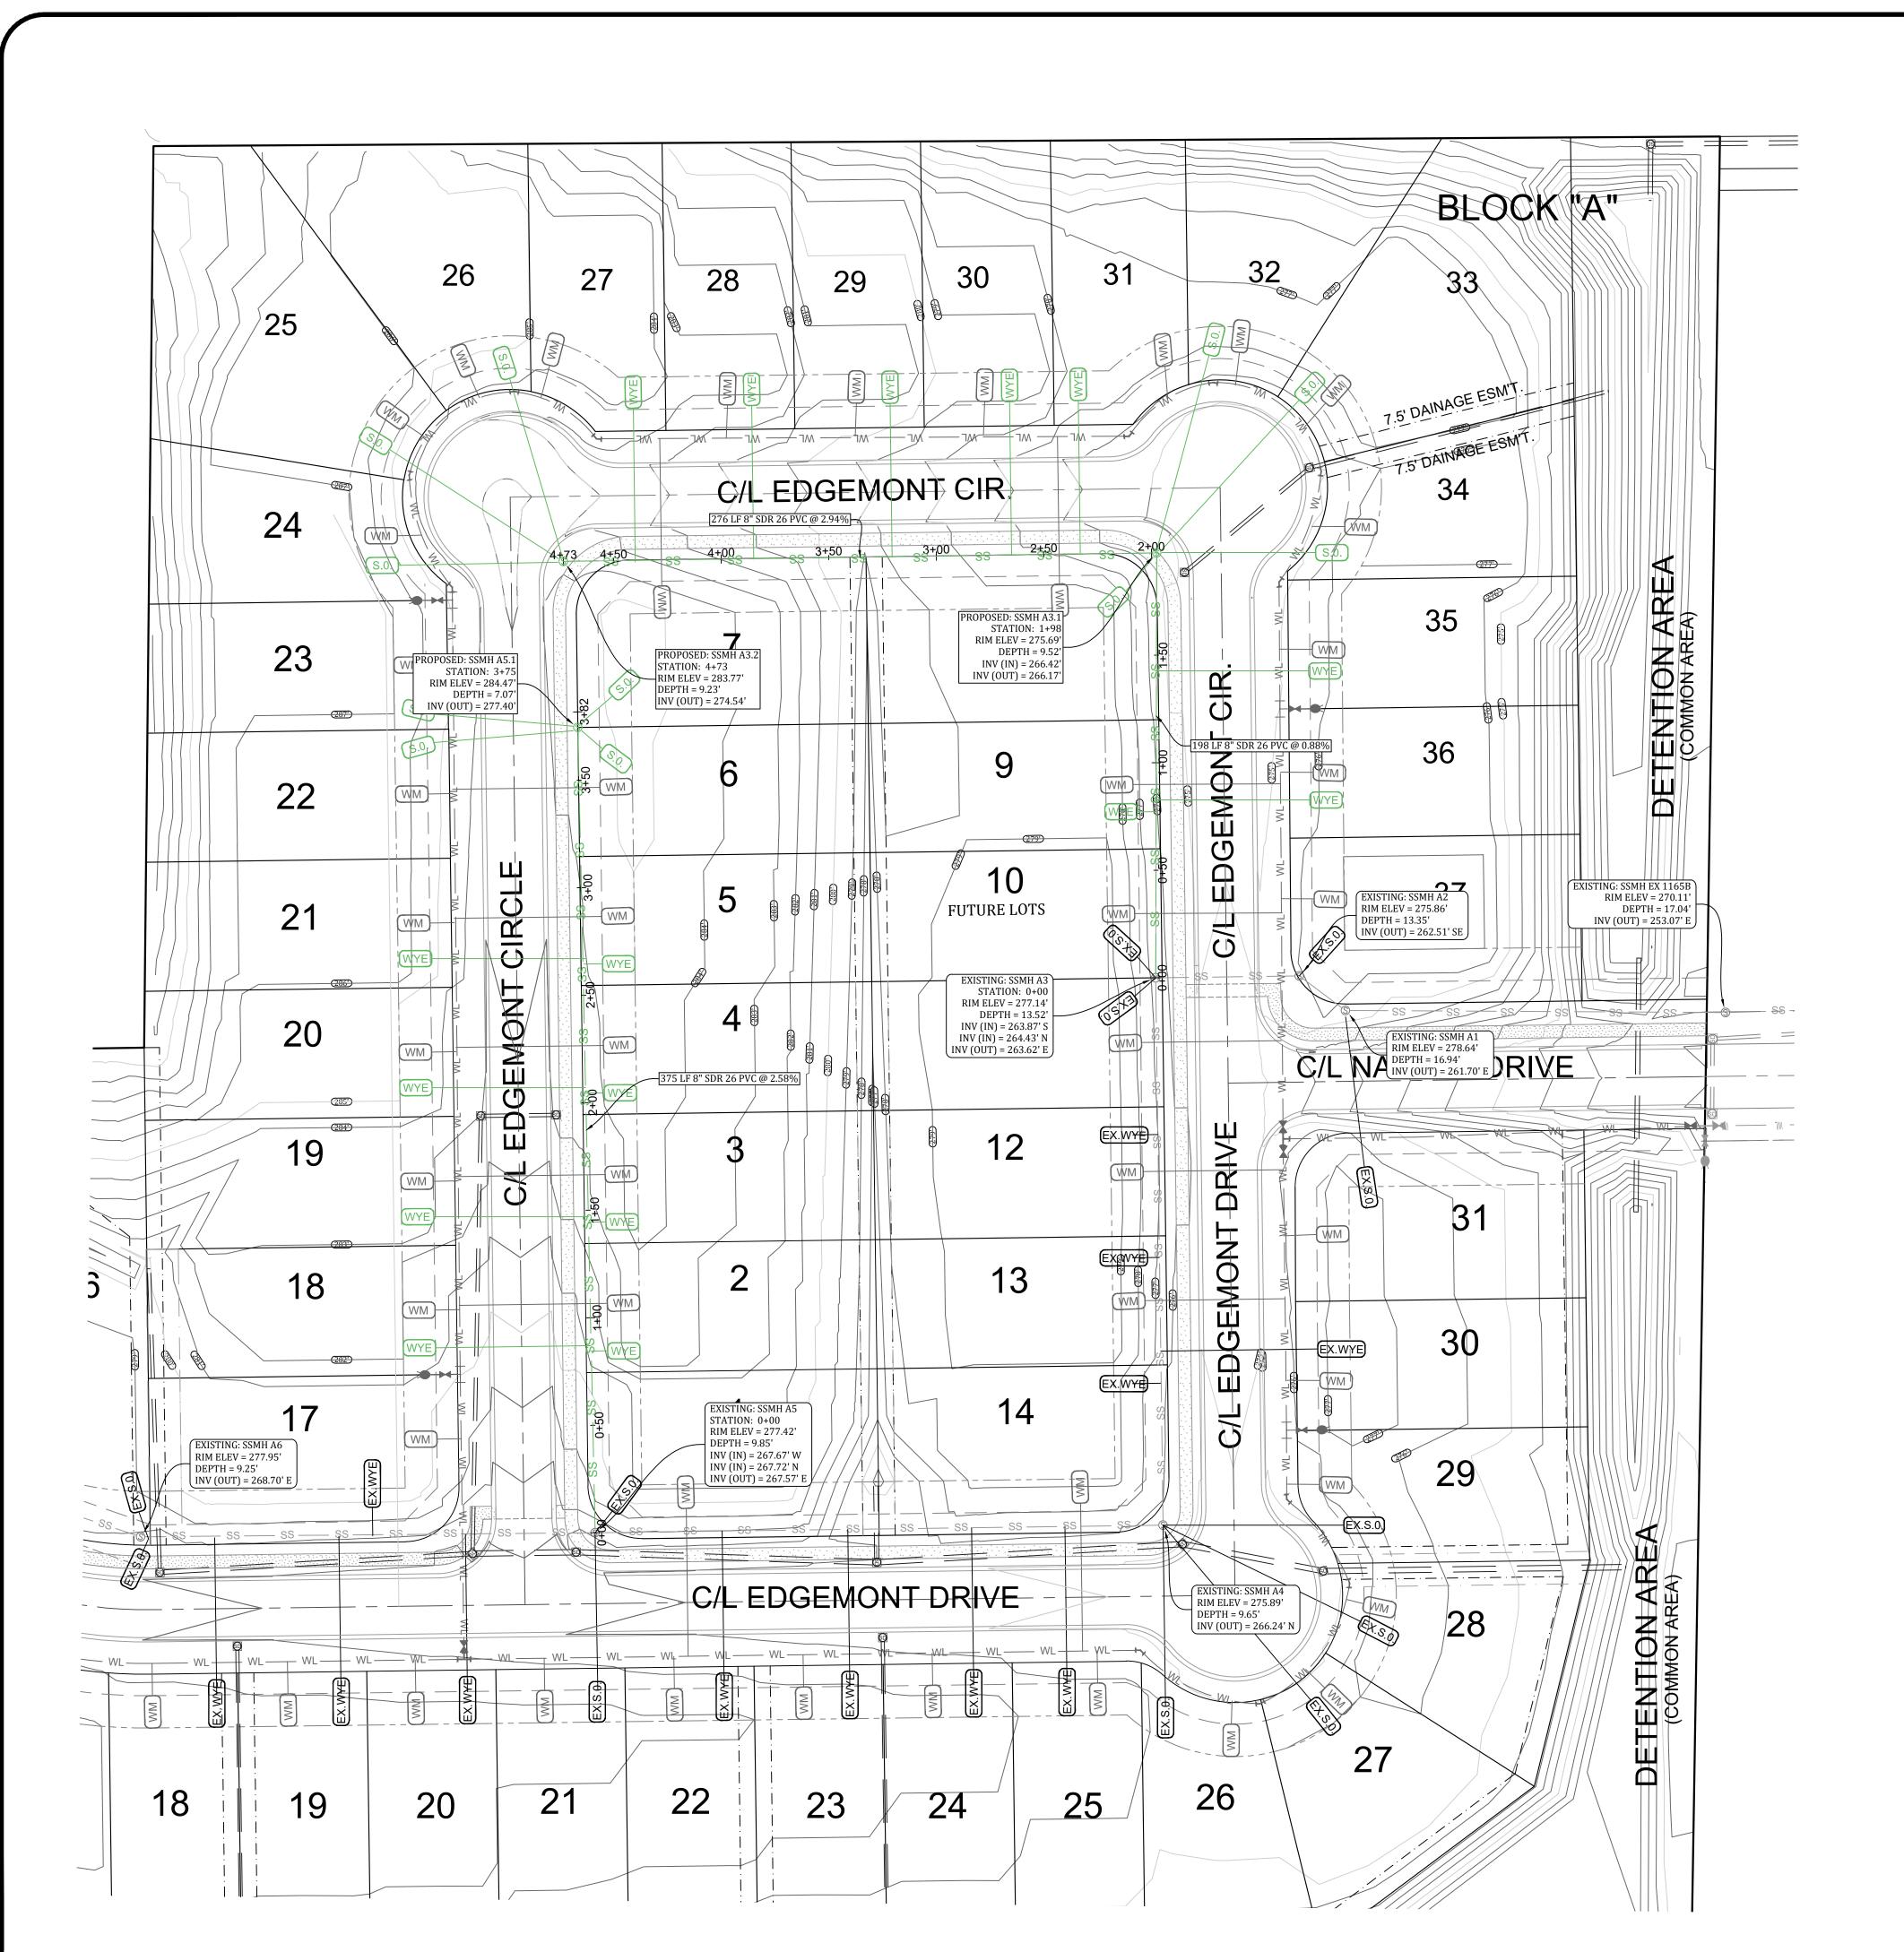
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> REVISIONS BY DESCRIPTION

DRAWING INFO. 9/6/2022

1"=40' SHEET NUMBER:

SW-1



SANITARY SEWER NOTES:


- CONTRACTOR SHALL PROVIDE WYES OR STUBOUTS FOR EACH LOT. THEY SHALL BE PLACED ON THE LOW ELEVATION SIDE OF LOT OR IN THE CENTER OF THE LOT IF THE ELEVATION IS FLAT.
- CONTRACTOR SHALL PROVIDE ENGINEER W/ "AS-BUILT" DIMENSIONS FOR WYE'S, VALVES, TEES, BENDS, FIRE HYDRANTS, & WATER METERS.
- 3. CONTRACTOR SHALL PROVIDE LABOR AND MATERIALS FOR ALL SEWER, WATER, & ELECTRICAL LINE LATERALS & PROVIDE LABOR & MATERIAL TO BACKFILL ALL SEWER, WATER & ELECTRICAL STREET CUTS WITH SANDY MATERIAL (P.I. <15) TO TOP OF EXCAVATION & COMPACT FILL TO 95% COMPACTION & PROVIDE COMPACTION TESTS AT 2' INTERVALS. CONTRACTOR SHALL PROVIDE LABOR AND MATERIAL FOR ALL SEWER & WATER LINE MAINS THAT CROSS A STREET AND BACKFILL THEM WITH SANDY (P.I. <15) TO TOP OF EXCAVATION & COMPACT FILL TO 95% COMPACTION & PROVIDE MATERIAL COMPACTION TESTS AT 2' INTERVALS.
- 4. CONTRACTOR SHALL CALL ARK ONE CALL FOR LOCATES PRIOR TO CONSTRUCTION.
- 5. CONTRACTOR SHALL NOTIFY ENGINEER TO DETERMINE ELEVATIONS FOR MANHOLE WHERE IT CROSSES PROPOSED STORM DRAINS, WATER METER BOX ELEVATIONS, VALVE BOX ELEVATIONS, AND FIRE HYDRANT ELEVATIONS, AND WATER LINE LOCATION AROUND INLETS. WATER LINE SHALL BE INSTALLED AT AN ELEVATION WHERE HYDRANTS ARE LOCATED TO ENSURE HYDRANT WILL BE AT PROPER HEIGHT WHEN FINISHED GRADE HAS BEEN OBTAINED.
- CONTRACTOR SHALL PROVIDE OWNER WITH ONE YEAR WARRANTY FOR MATERIALS AND WORKMANSHIP ELEVATION CONTRACTOR SHALL PROVIDE ENGINEER WITH LIEN RELEASES FOR MATERIALS AND LABOR; BACTERIAL SAMPLE RESULTS; AND MODEL & YEAR OF WATER LINE VALVES WITHIN 30 DAYS OF COMPLETION OF WORK.
- 8. CONTRACTOR SHALL DRESS UP PROJECT AFTER INSTALLATION TO THE CONDITION IT AS PRIOR TO BEGINNING CONSTRUCTION. MOUND BACKFILL OVER TRENCHES 1' TO 2' TO ALLOW FOR SETTLING IN AREAS OUT OF THE STREET.
- 10. ALL STREET EXCAVATION MATERIAL SHALL BE DISPOSED OF BY CONTRACTOR ON THE ADJACENT LOTS OR AS DIRECTED BY OWNER.
- 11. CONTRACTOR SHALL REVIEW DETAIL SHEETS TO ENSURE PROPER INSTALLATION OF VALVES, FIRE HYDRANTS, CONCRETE BLOCKING, SERVICE LINES, MANHOLE INVERTS, AND DROP ASSEMBLIES.
- 12. ALL SEWER LINES SHALL BE ASTM 2241 SDR-26.
- 13. WATER LINE AND SANITARY SEWER LINE SHALL MAINTAIN 18" MINIMUM SEPARATION, WATER LINE AND STORM DRAIN SHALL MAINTAIN 36" MINIMUM SEPARATION TO PREVENT FREEZING. MAINTAIN 10' HORIZONTAL SEPARATION BETWEEN SEWER AND WATER LINE. WHERE A WATER LINE MUST UNAVOIDABLY PASS BENEATH THE SEWER LINE, AT LEAST 18" OF SEPARATION MUST BE MAINTAINED BETWEEN THE OUTSIDE OF THE TWO PIPES IN ADDITION TO THE PRECEDING ENCASEMENT REQUIREMENTS.
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- 16. DURING CONSTRUCTION, WORK SHALL BE INSPECTED BY THE DEVELOPER'S CONSULTING ENGINEER FOR NECESSARY SAFETY PRACTICES, PROPER MATERIALS, AND WORKMANSHIP. CWL WILL PROVIDE RANDOM INSPECTIONS TO ENSURE THAT THE PLANS APPROVED BY THE ARKANSAS DEPARTMENT OF HEALTH AND CWL ARE FOLLOWED CONCERNING WORKMANSHIP AND MATERIALS.
- 17. IF SEWER AND WATER LINES HAVE NOT BEEN ACCEPTED BY CWL WITHIN 360 DAYS AFTER MANDREL TESTS, LOW PRESSURE AIR TESTS, HYDROSTATIC TESTS AND BACTERIAL TESTS, ALL TESTS WILL BE REQUIRED TO BE REPEATED AND RE-CERTIFIED.
- 18. CWL ENGINEERING DEPT. MUST APPROVE ANY WATER OR SEWER LINES THAT WILL BE INSTALLED CLOSER THAN 5' PARALLEL WITH EDGE OF PAVED STREET SURFACE.
- 19. REPAIRS SHALL BE MADE IN ACCORDANCE WITH AWWA.
- 20. ALL SEWER WYES & STUBOUTS SHALL BE EXTENDED ACROSS STREETS TO THE APPROPRIATE LOT LINES. CONTRACTOR IS RESPONSIBLE FOR ENSURING ALL LOTS HAVE A SEWER SERVICE.

TRENCH SETTLEMENT NOTE:

CITY WATER & LIGHT IS NOT RESPONSIBLE FOR ANY SETTLEMENT OVER WATER & SEWER TRENCHES THAT OCCURS BEFORE OR AFTER THE WARRANTY PERIOD.

ALL SEWER WYES SHALL BE A MINIMUM OF 10' FOOT AWAY FROM PROPERTY CORNERS.

NOTE: IF UNSAFE PRACTICES ARE DISCOVERED BY CWL DURING OUR INSPECTIONS OF WORKMANSHIP AND MATERIALS, CWL WILL NOTIFY THE OSHA. THIS NO WAY OBLIGATES CWL FOR THE RESPONSIBILITY OF THE CONTRACTORS SAFETY PRACTICES.

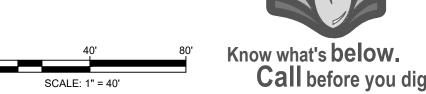

EDGE SSIONAL PROFESSIONAL PROFE

REVISIONS

DATE BY DESCRIPTION

DRAWING INFO.

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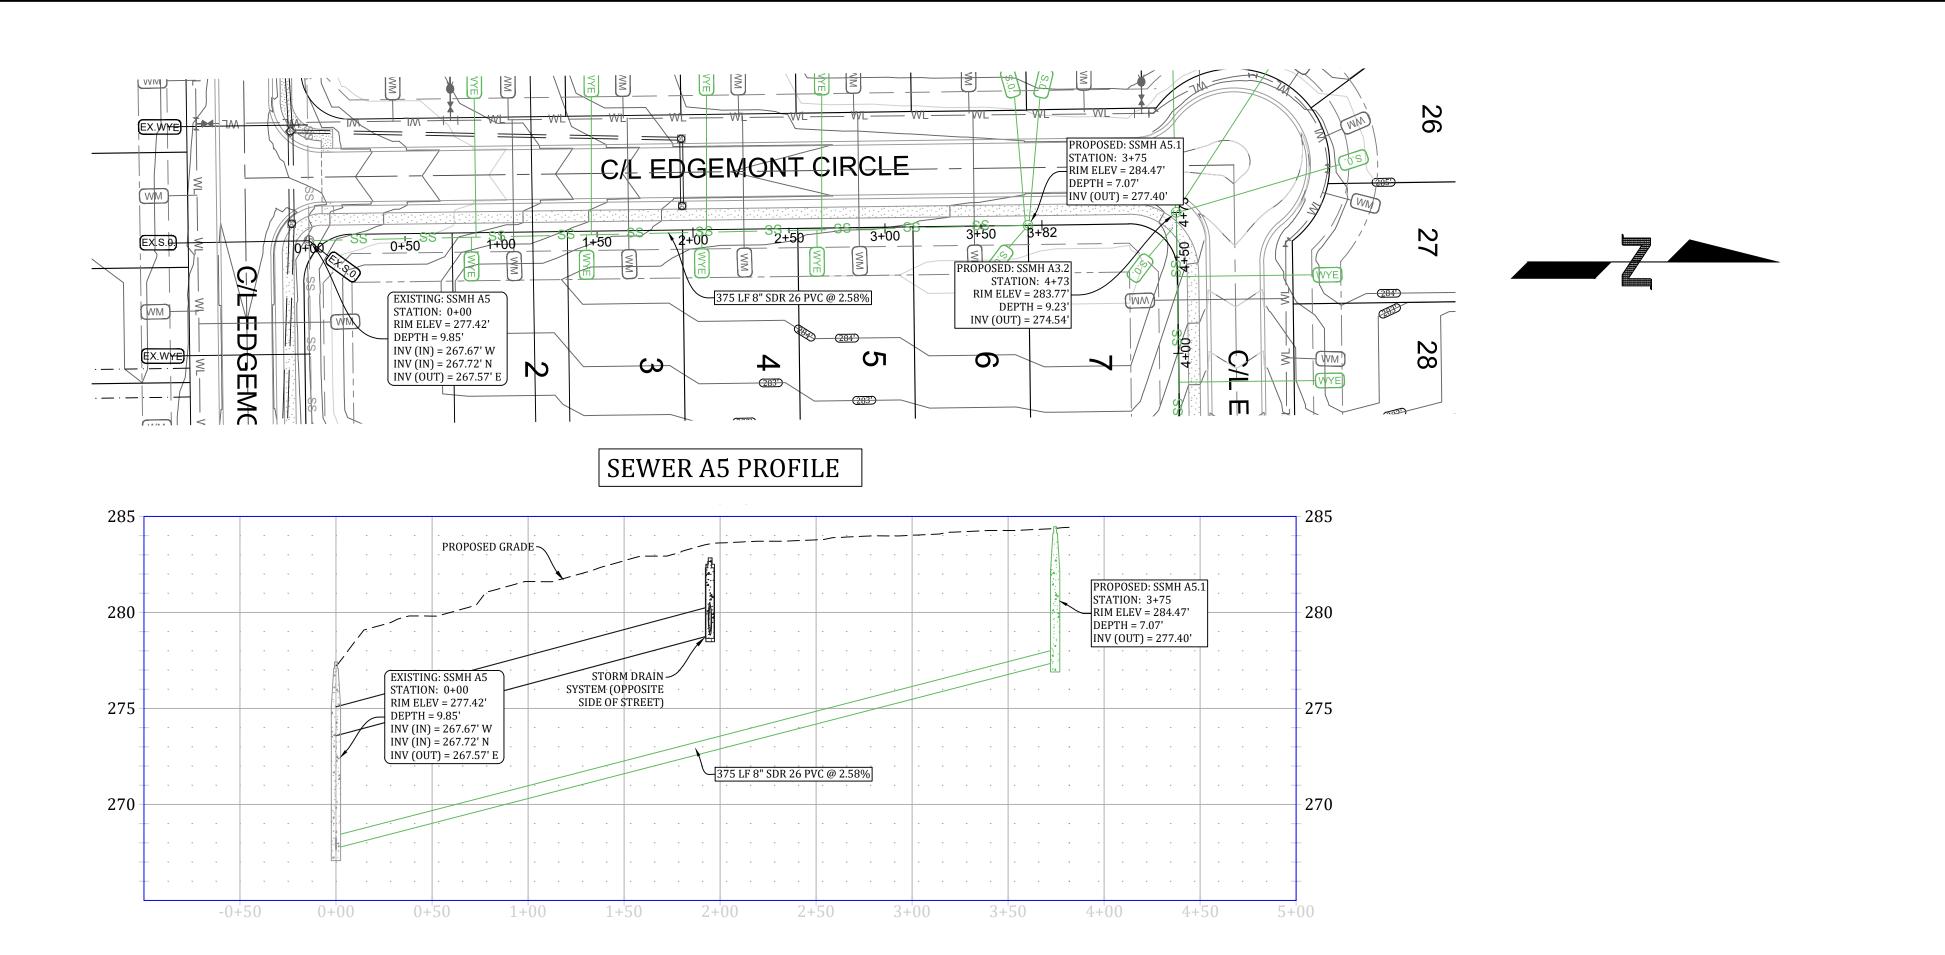
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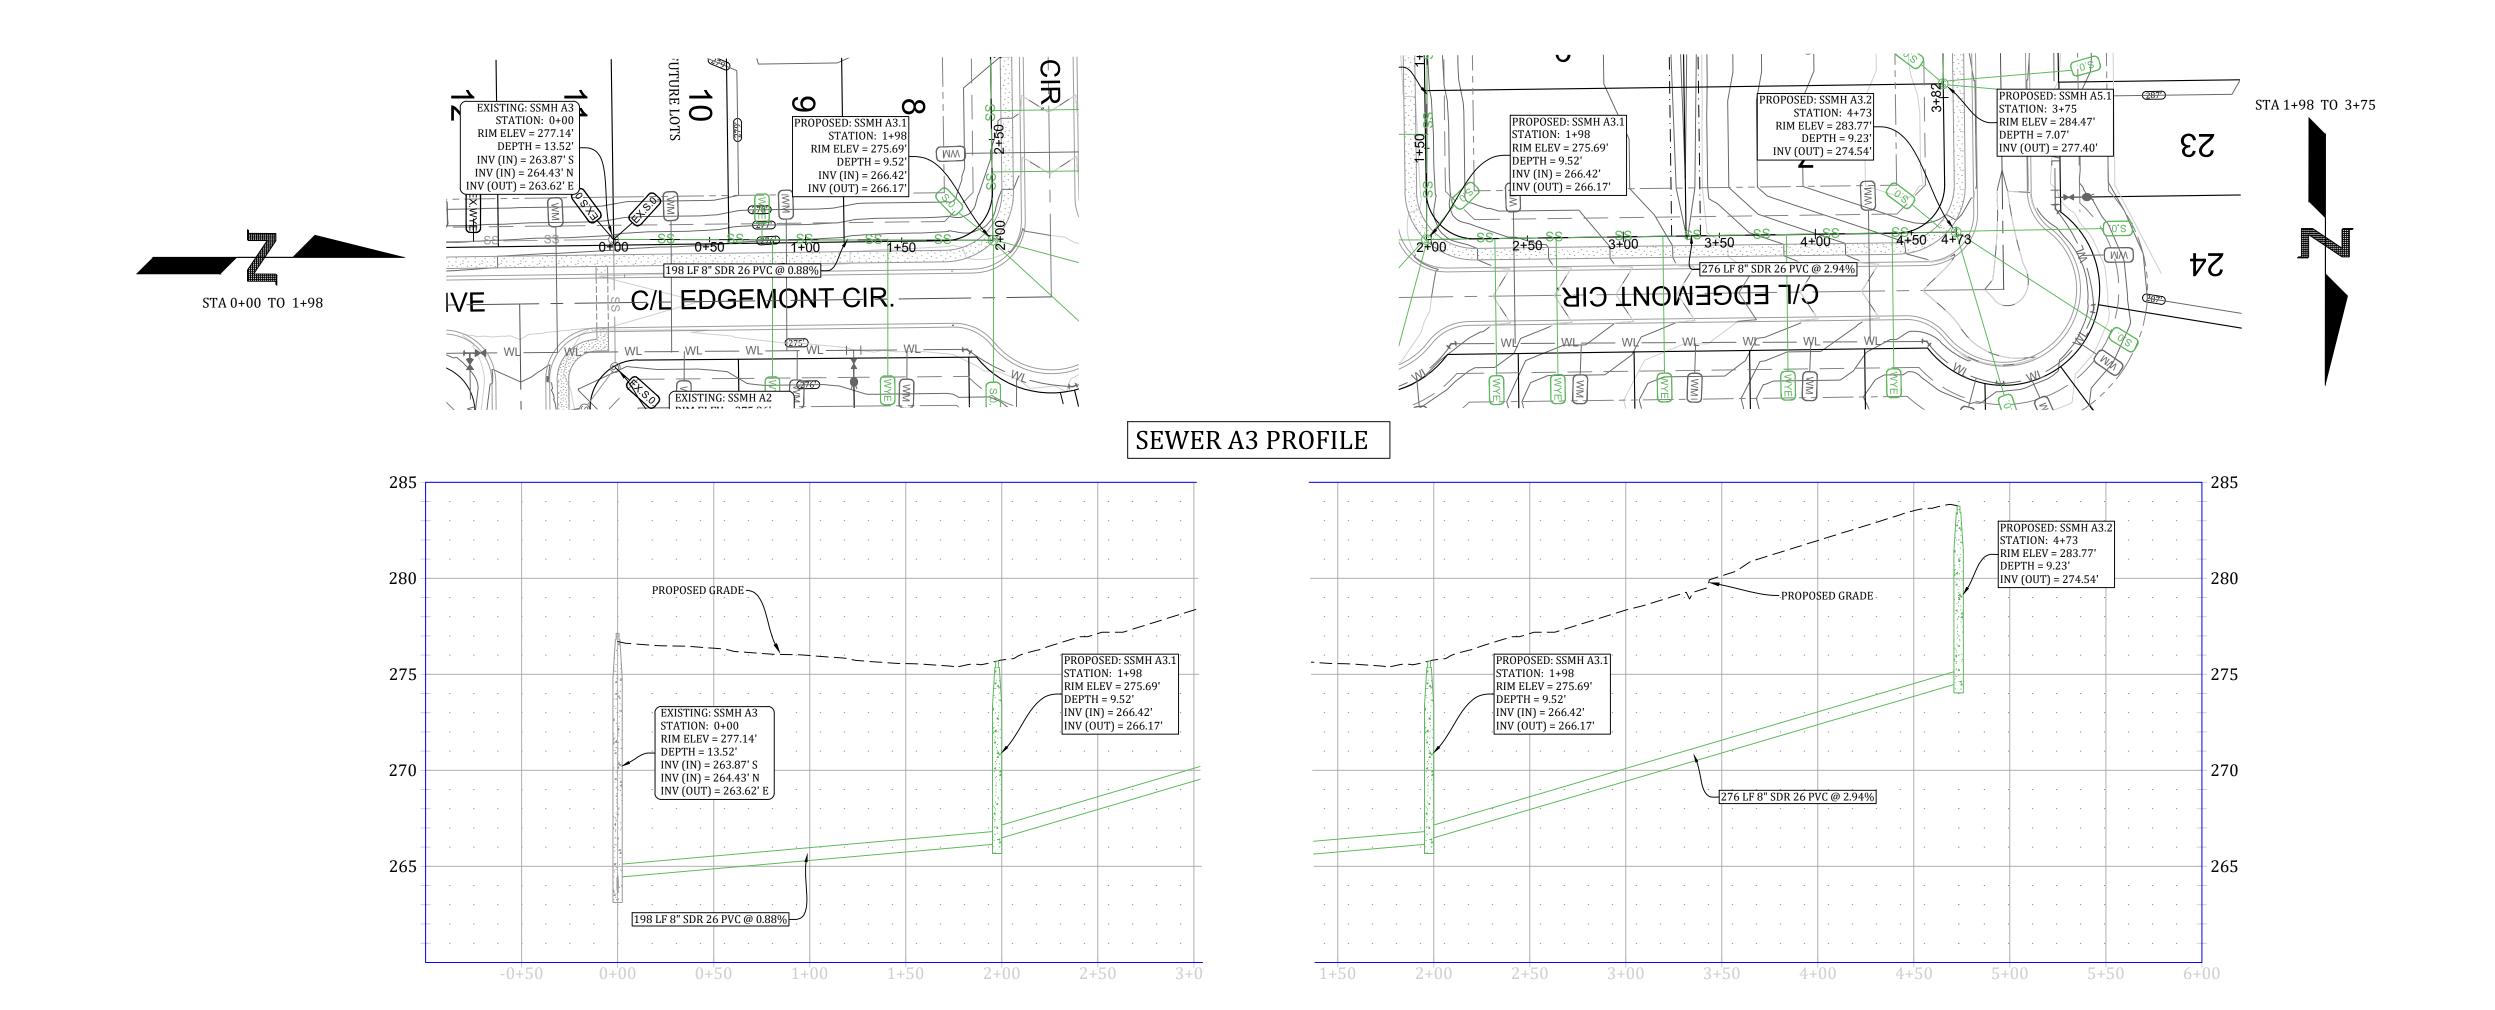
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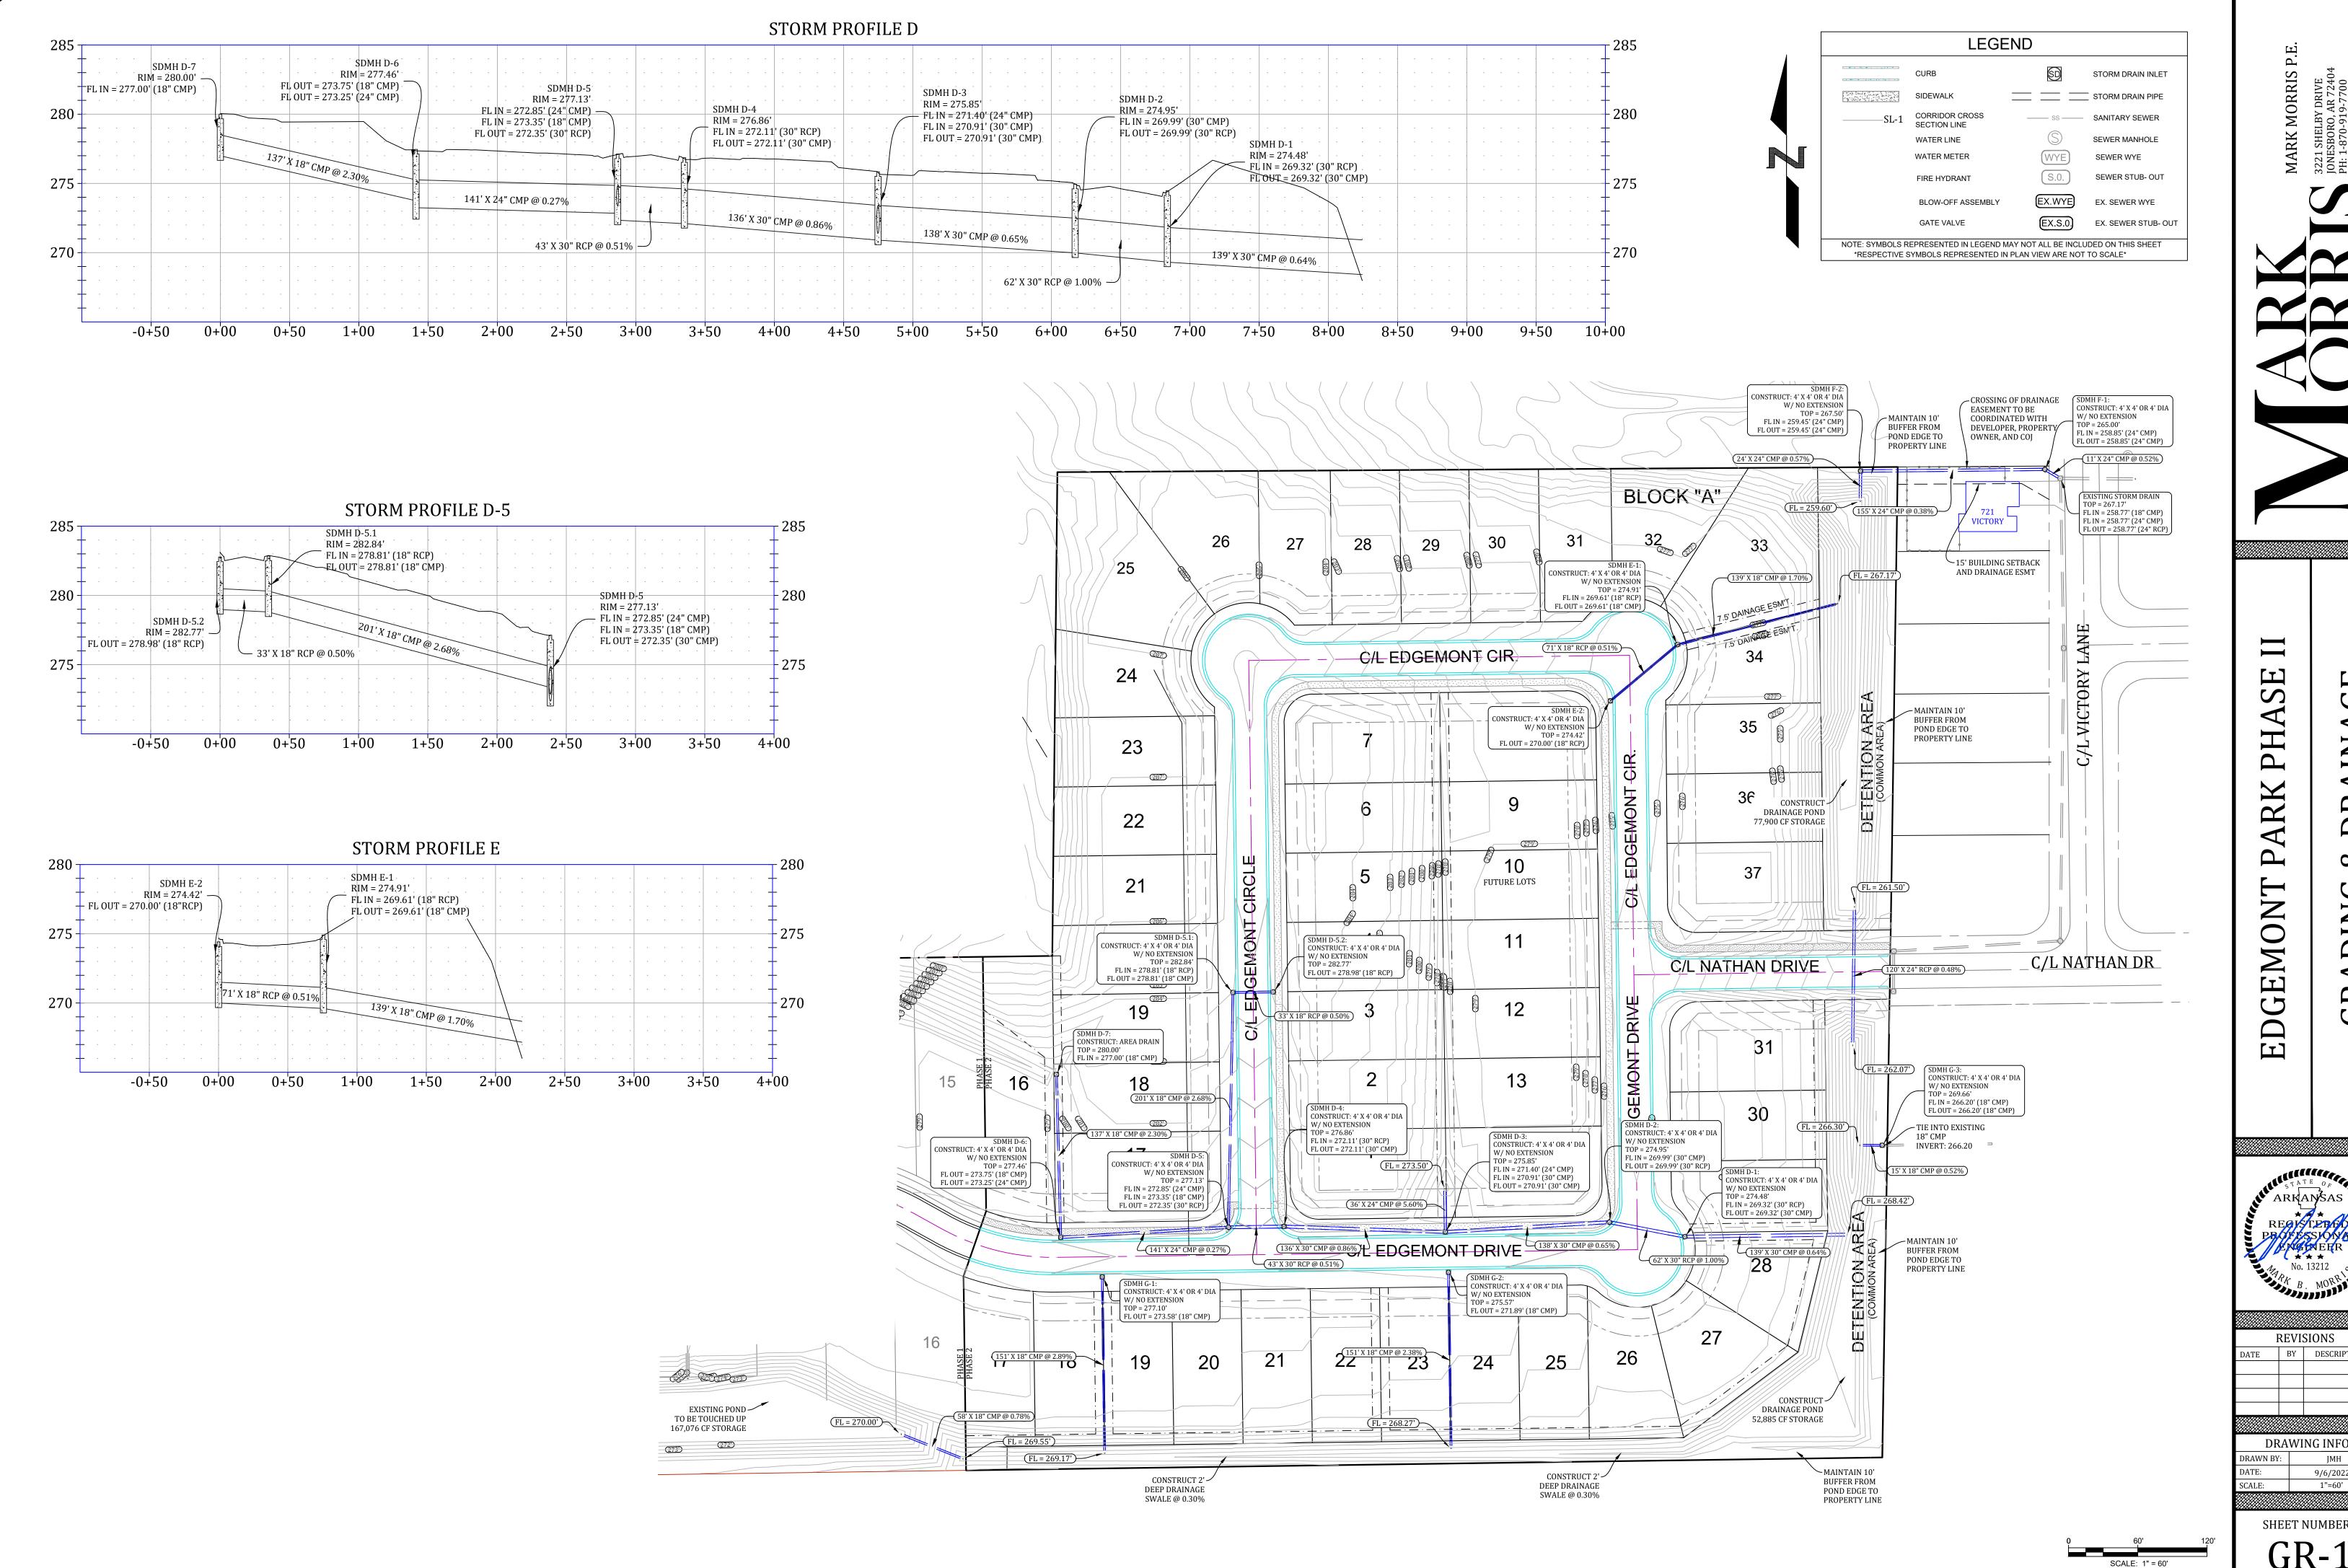
SW-2

1"=50'

VERTICAL SCALE 1:5







ALATE OF ARKANSAS

8


REVISIONS DATE BY DESCRIPTION DRAWING INFO. JMH 9/6/2022


SHEET NUMBER:

GR-1




EDGEMONT DRIVE PROFILE

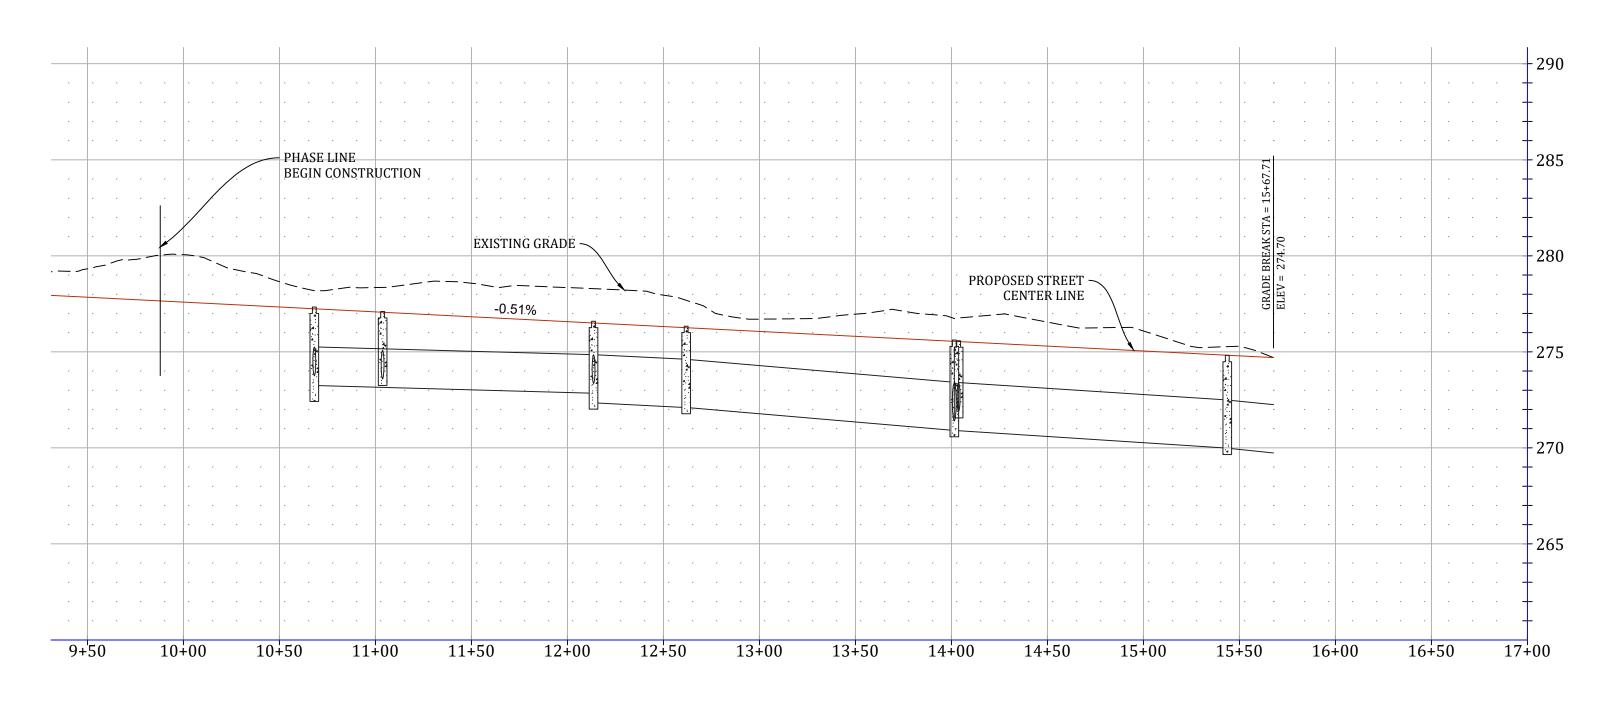


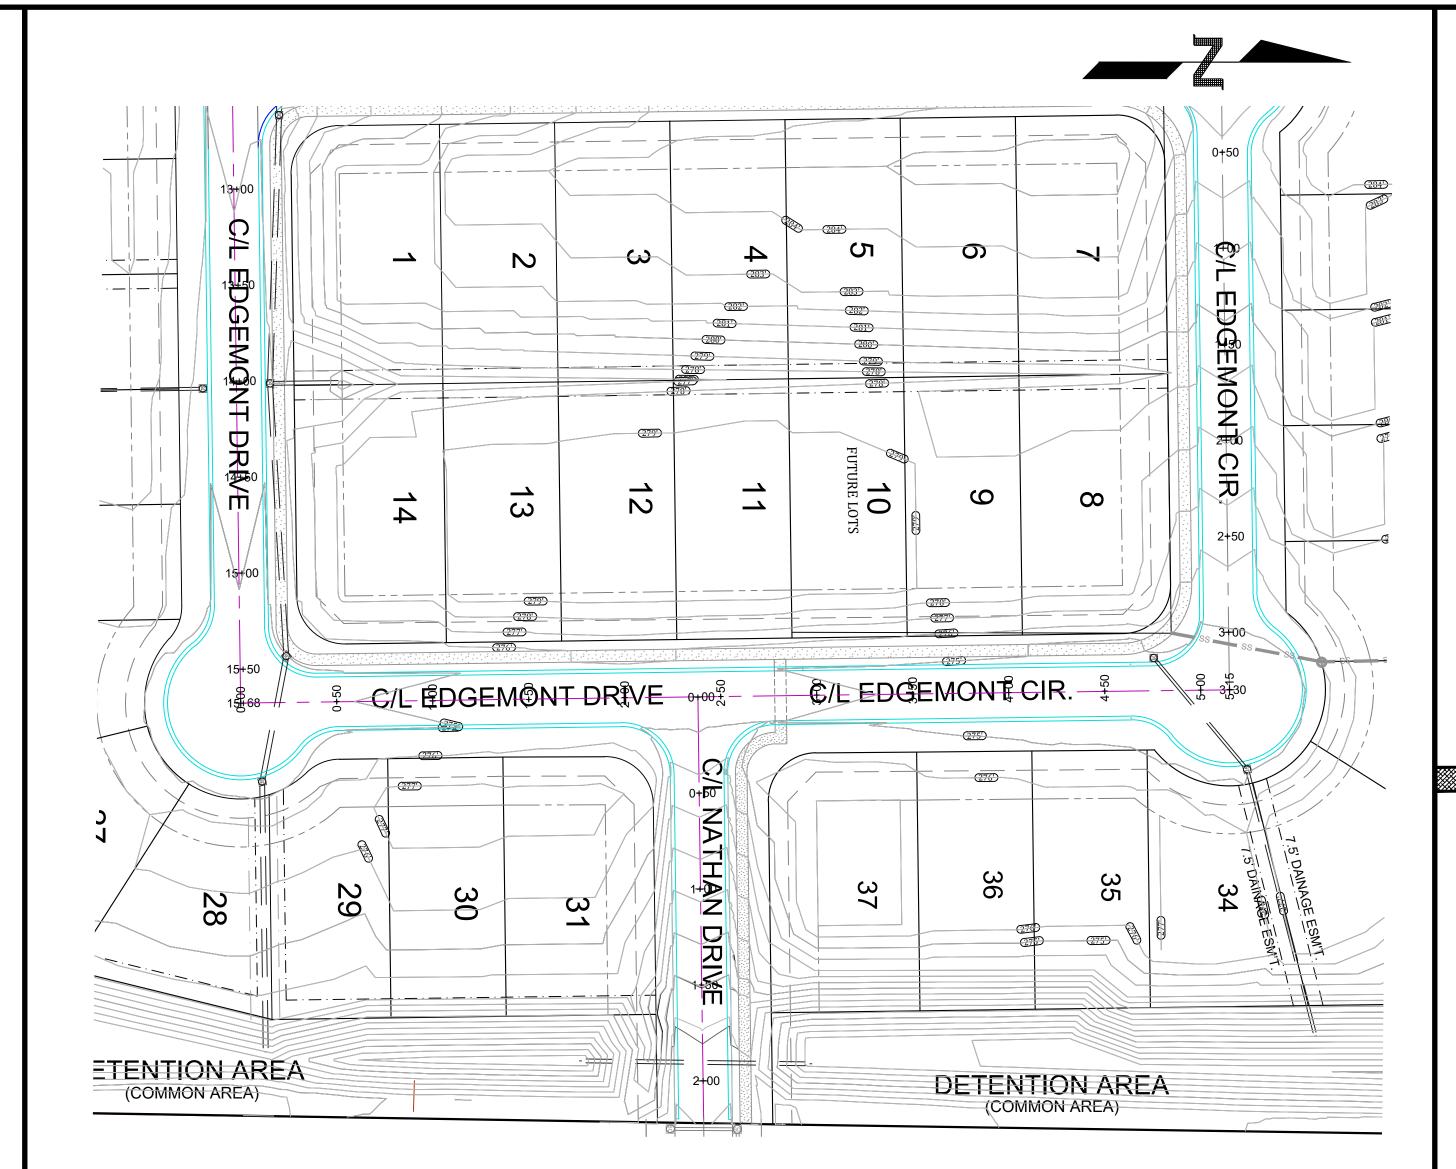

EDGEMONT DRIVE/EDGEMONT CIRCLE PROFILE

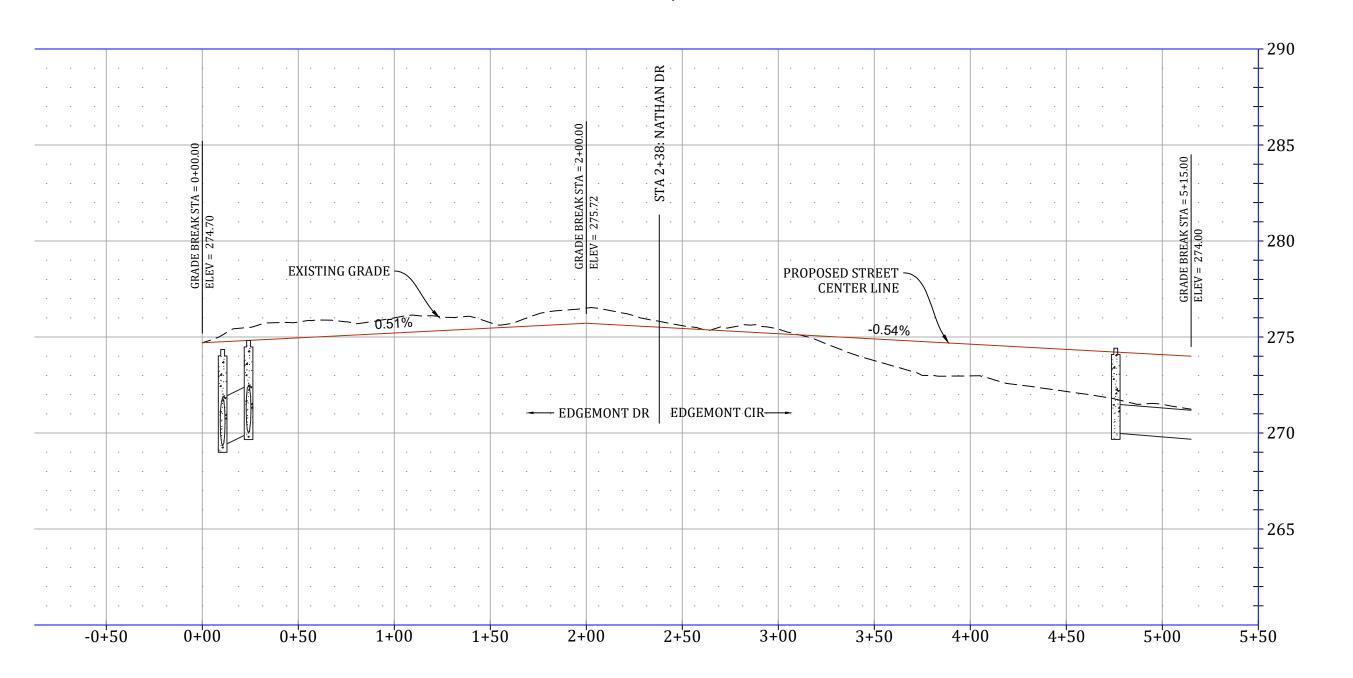

VERTICAL SCALE 1:5 HORIZONTAL SCALE 1:50

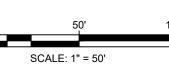

REVISIONS

DATE BY DESCRIPTION

DRAWING INFO.

DRAWN BY: JMH


DATE: 9/6/2022


RK PHASE


EDGEMONT

E 1:50 SHEET NUMBER:


ST-1

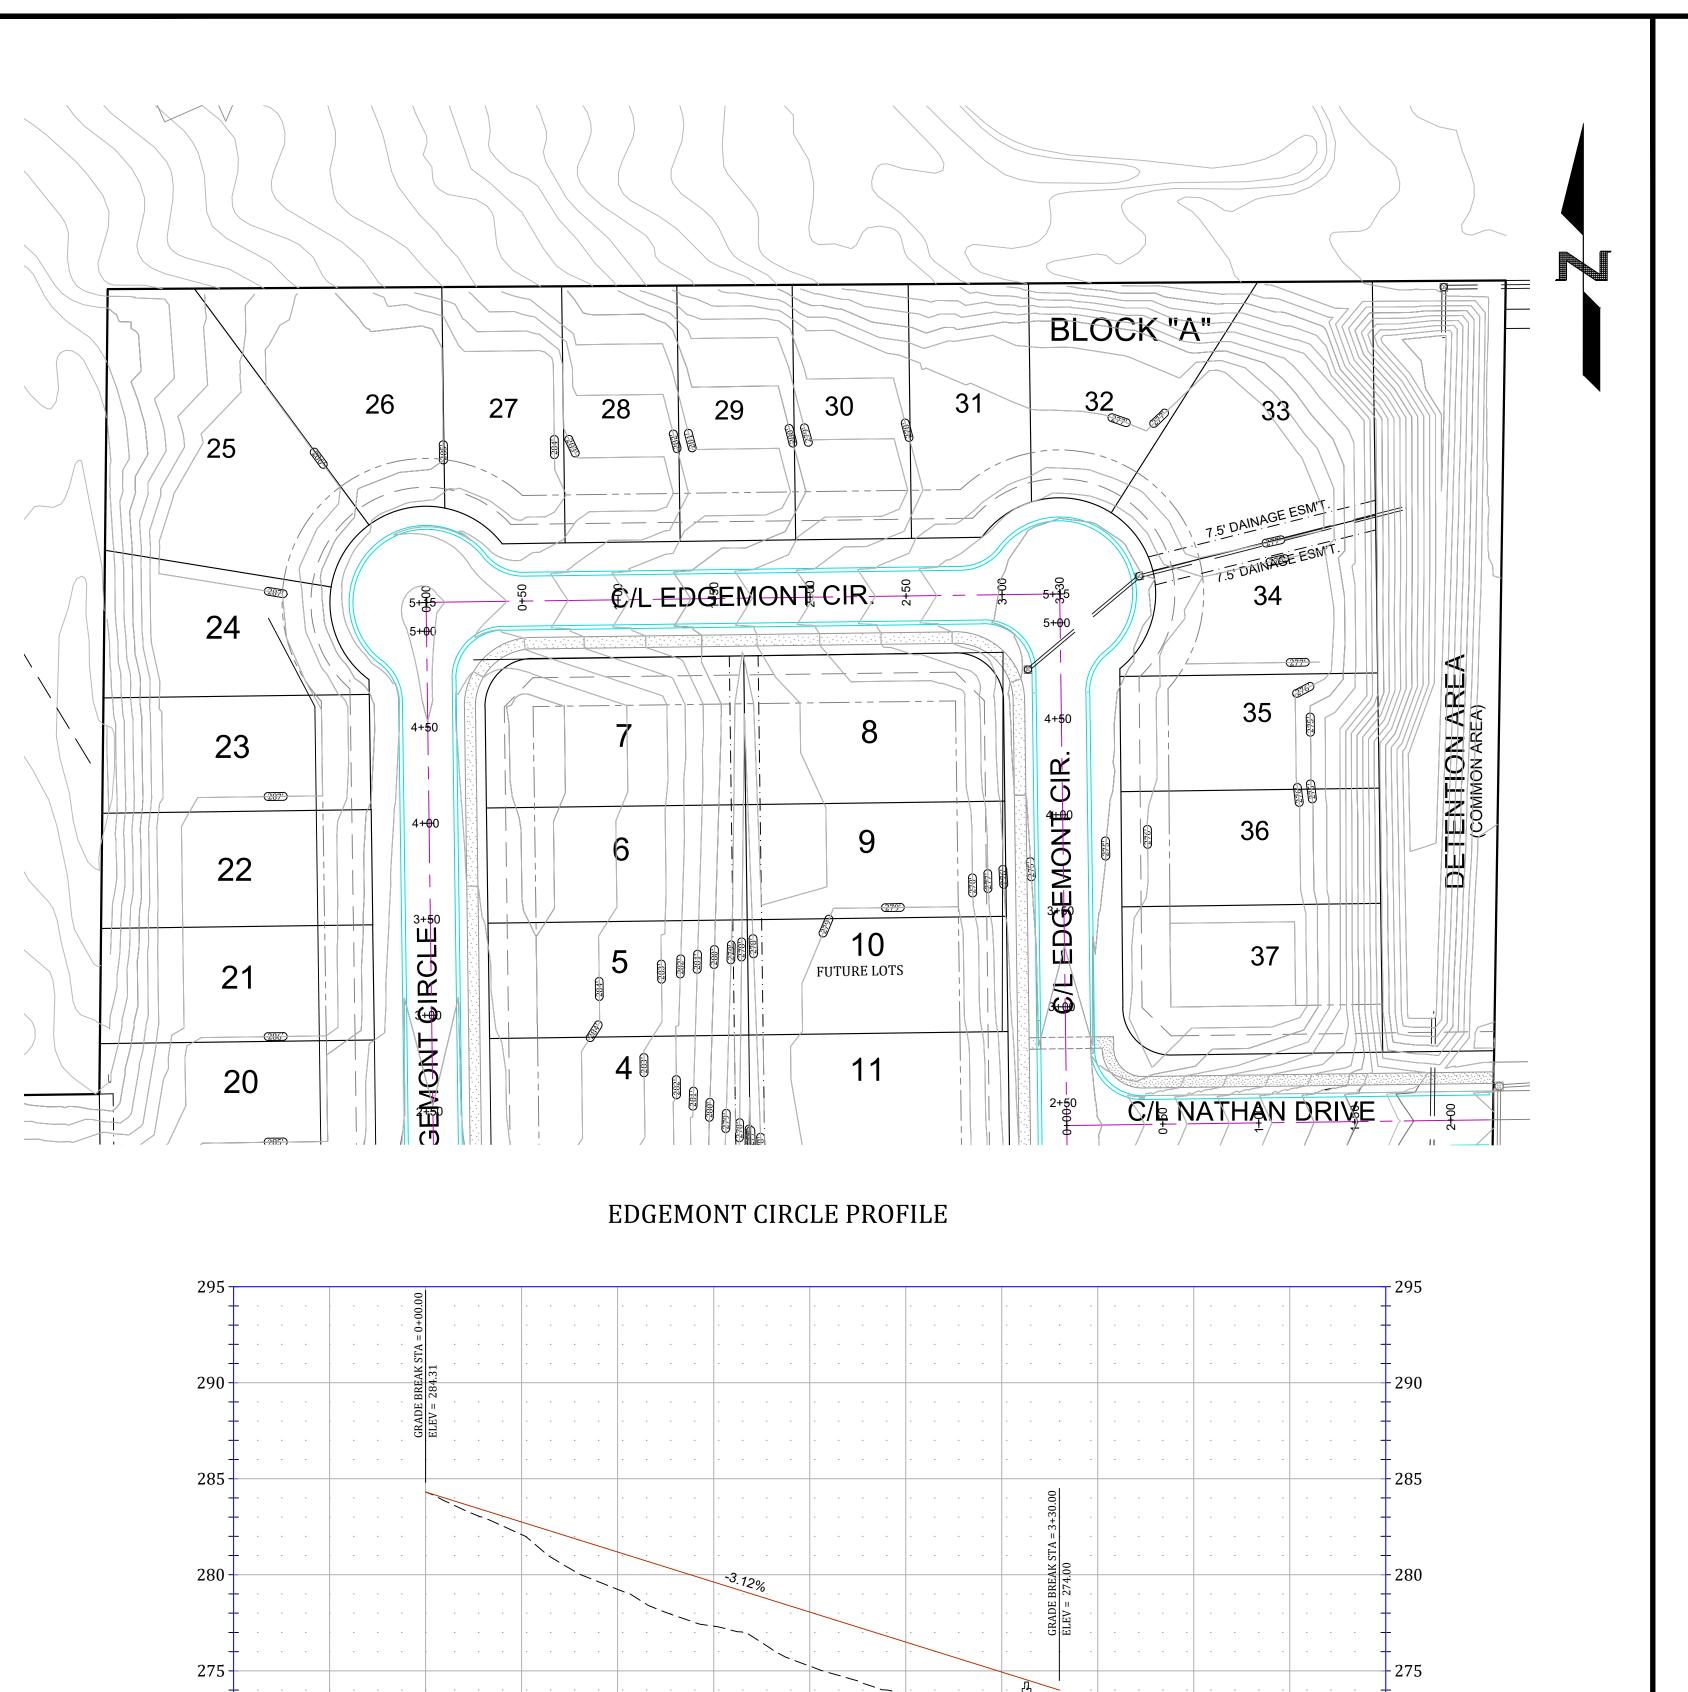


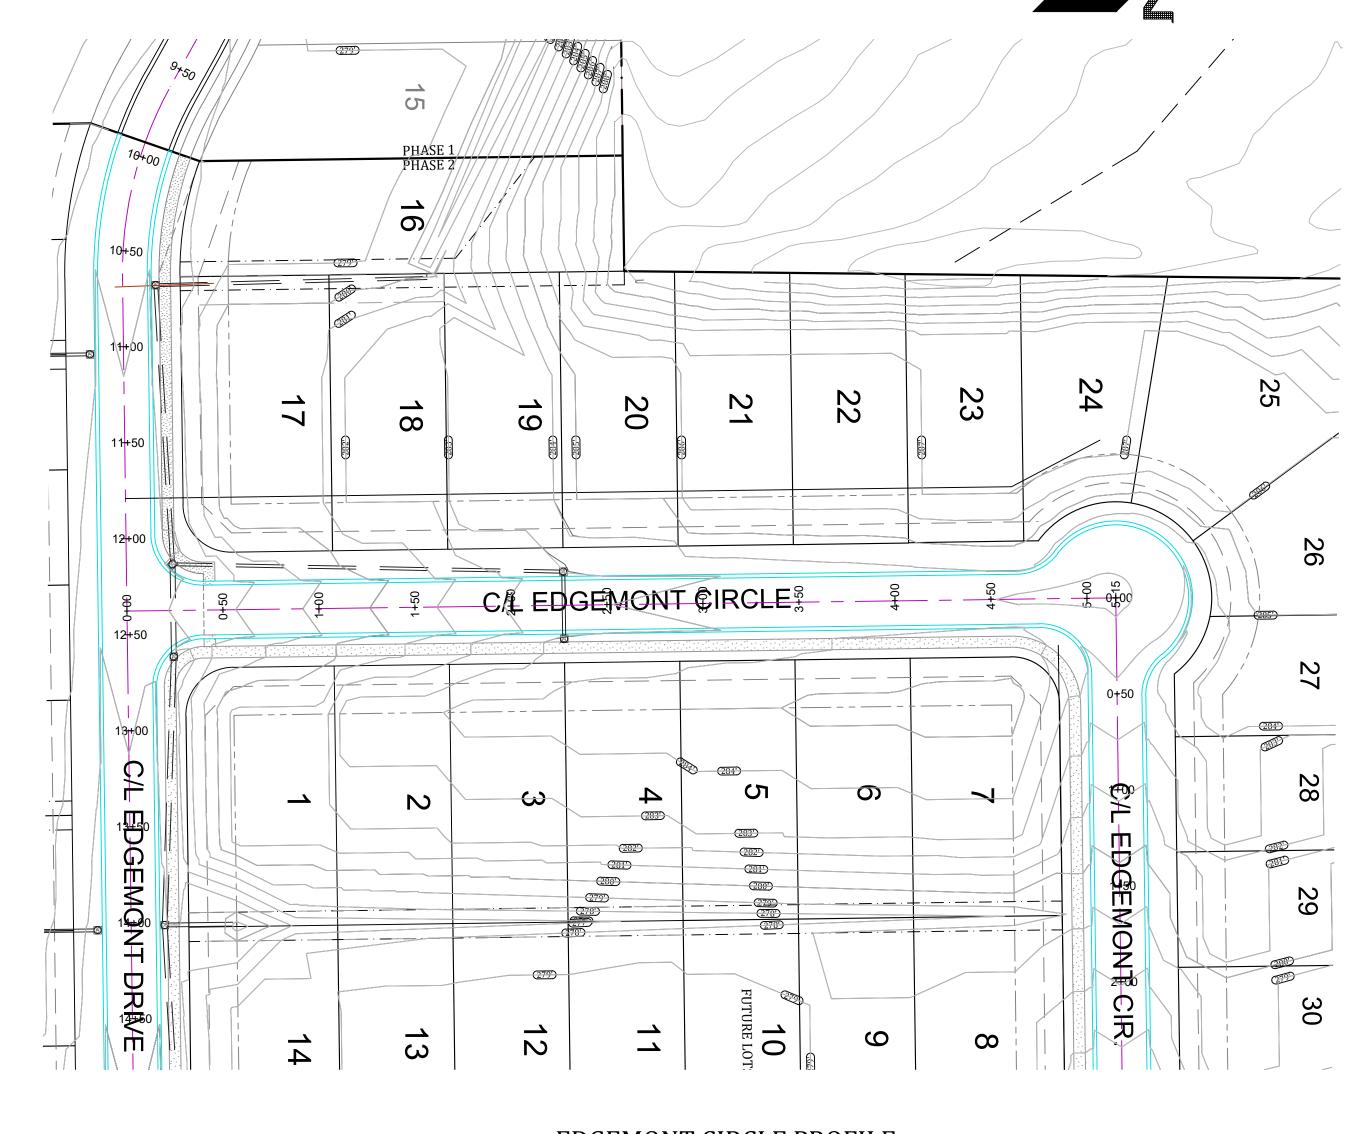

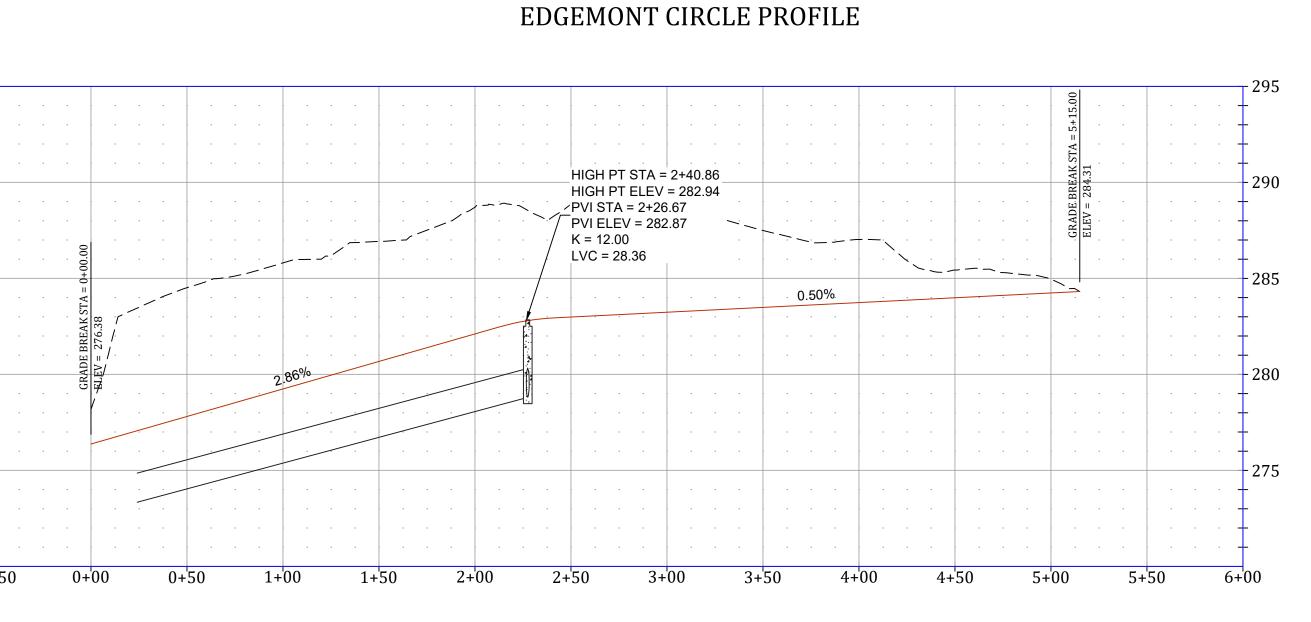

VERTICAL SCALE 1:5 HORIZONTAL SCALE 1:50

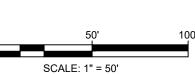

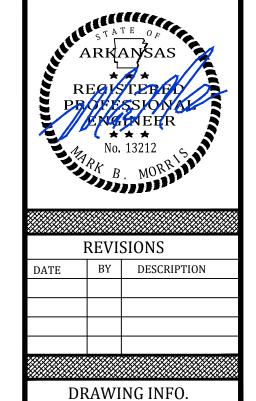

RK PHASE

EDGEMONT

SHEET NUMBER:

ST-2

JMH 9/6/2022 1"=50'

	REVIS	SIONS
DATE	BY	DESCRIPTION

DRAWING INFO.

DRAWN BY: JMH


DATE: 9/6/2022

VERTICAL SCALE 1:5


HORIZONTAL SCALE 1:50

LE: 1"=50'
SHEET NUMBER:


SHEET NUMBER: ST-3

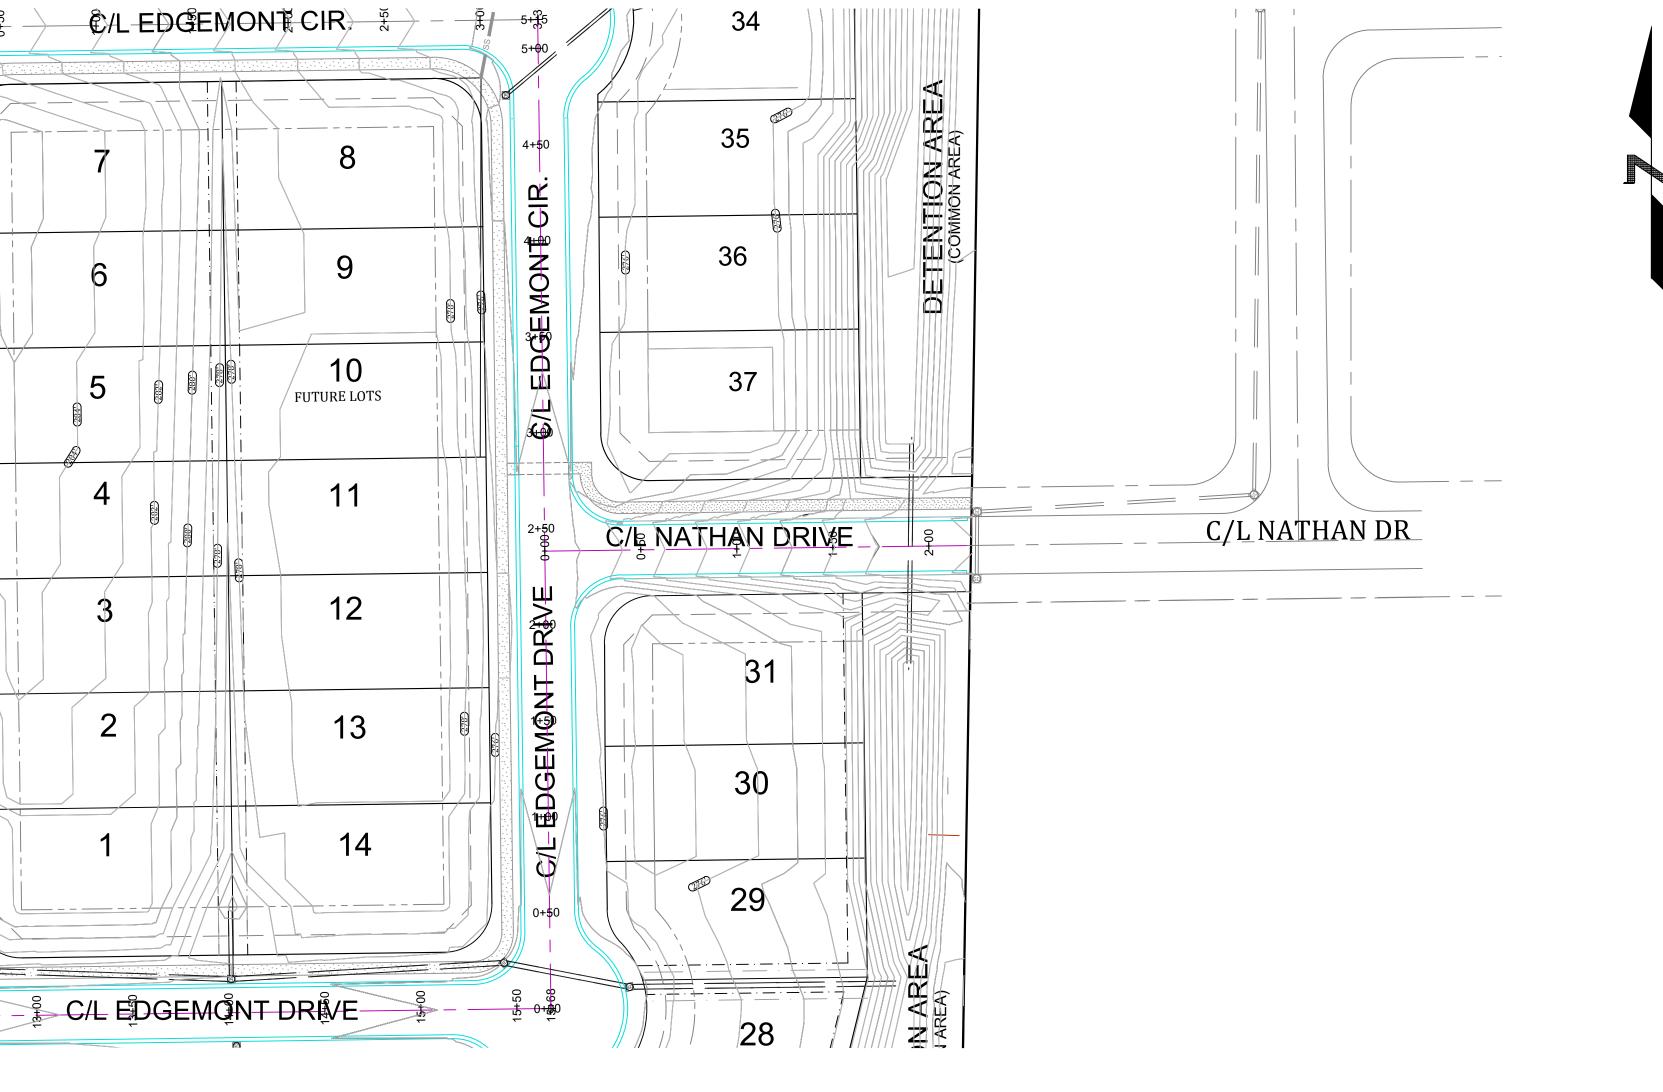

NATHAN DRIVE PROFILE

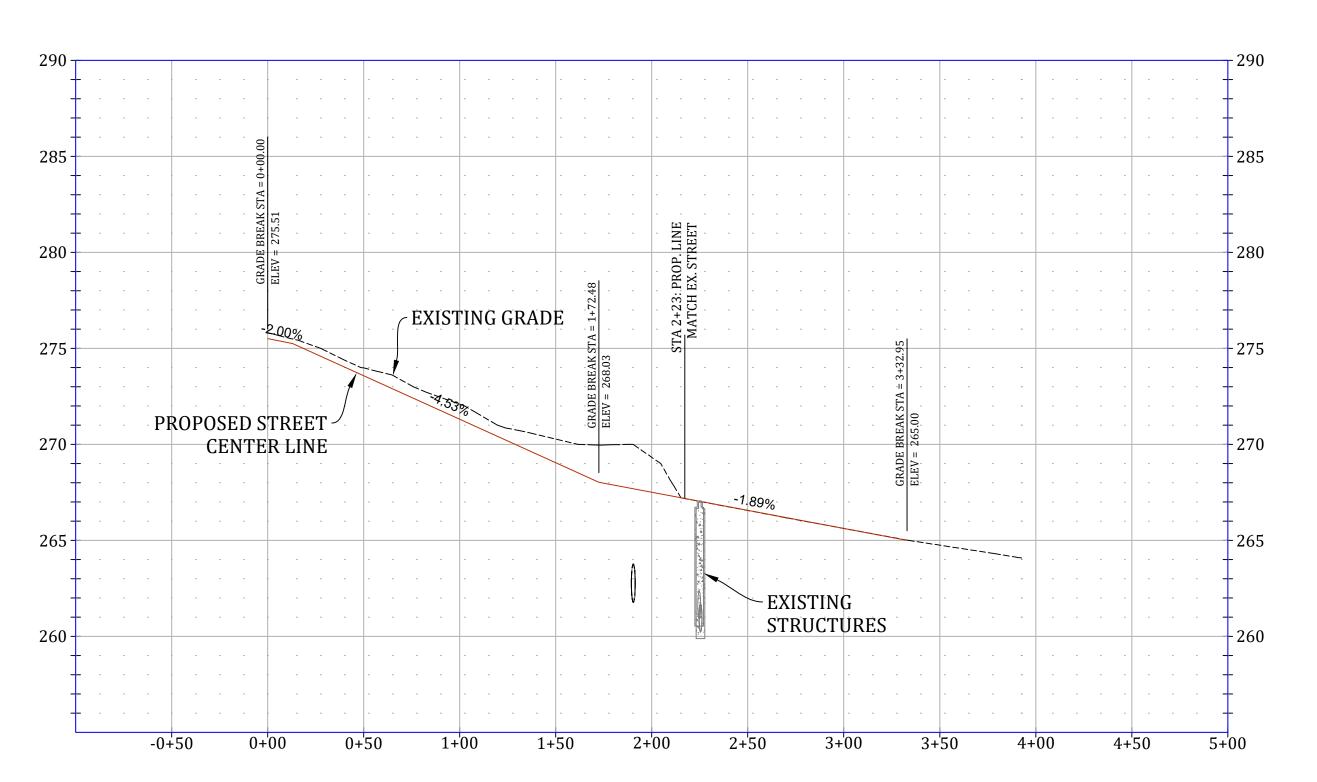

S 0 GEM Ш

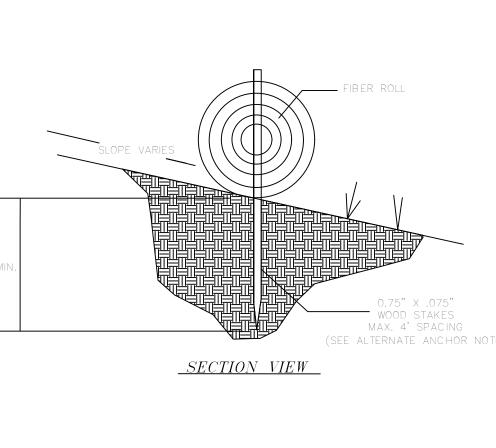

(SEE ALTERNATE ANCHOR NOTE)

FIBER ROLLS AND WATTLES

NOT TO SCALE

- STEEL FENCE POST OR 2 x 2 WOOD POST

TOP OF LEVY – 1FT (H) X 20 FT (W) BROAD CRESTED WEIR ROCK OUTFALL **PROTECTION** OUTFLOW PIPE

WOVEN WIRE FENCE -


EMBED SILT FENCE IN -TRENCH AS SHOWN


SILT FENCE

FABRIC

SEDIMENT BASIN w/ FAIRCLOTH SKIMMER

NOT TO SCALE

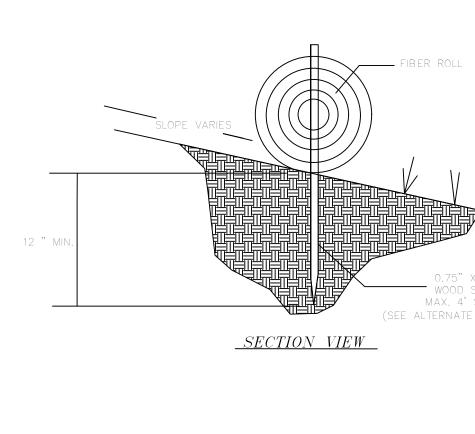

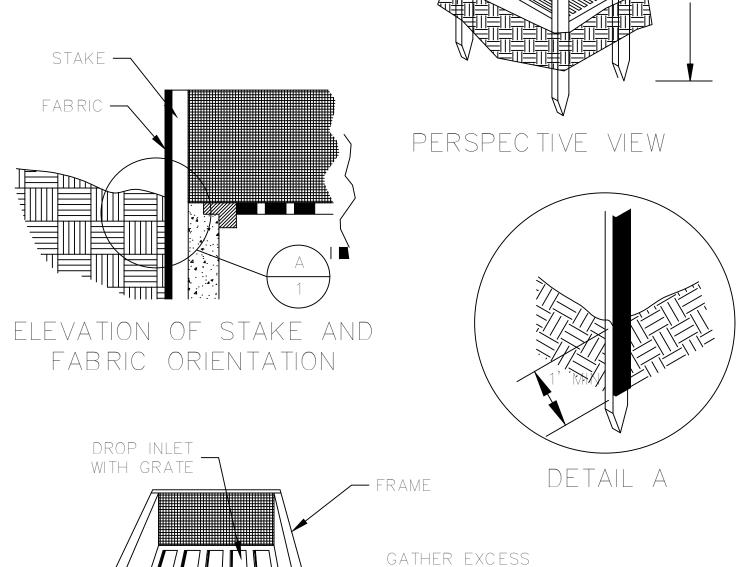

AT CORNERS

PERSPECTIVE VIEW

24" WOODEN STAKES

NOTES:

REACHES 50% CAPACITY.

EVERY 12"

ALTERNATE INSTALLATION:

FIBER ROLLS (WATTLES) MAY BE

SUBSTITUTED TO PREVENT SITE

AS DEEMED NECESSARY BY CONTRACTOR.

FLOODING FROM OCCURRING.

STAKE —

FABRIC —

FILTER FABRIC INLET PROTECTION

NOT TO SCALE

ASSURE DIRECT CONTACT

WITH SOIL

DIAMETER

CONTROL

1. EROSION CONTROL LOG CONTAINMENT MESH SHALL BE 100% BIODEGRADABLE, PHOTODEGRADABLE OR RECYCLABLE;

2. DAILY INSPECTION SHALL BE MADE BY THE CONTRACTOR AND SILT ACCUMULATION MUST BE REMOVED WHEN DEPTH

3. CONTRACTOR SHALL MONITOR THE PERFORMANCE OF INLET PROTECTION DURING EACH RAINFALL EVENT AND

100% RECYCLABLE FIBERS, OR ANY OTHER ACCEPTABLE MATERIAL EXCLUDING STRAW AND HAY.

4. INLET PROTECTIONS SHALL BE REMOVED AS SOON AS THE SOURCE OF SEDIMENT IS STABILIZED.

IMMEDIATELY CLEAN THE INLET PROTECTION IF EXCESSIVE PONDING OCCURS.

AND FILL MATERIAL SHALL CONSIST OF MULCH, ASPEN EXCELSIOR FIBERS, CHIPPED SITE VEGETATION, COCONUT FIBERS,

EROSION


EXTEND 12" MINIMUM

BEYOND INLET OPENING —

CROSS SECTION

AROUND PERIMITER

WOOD FRAME

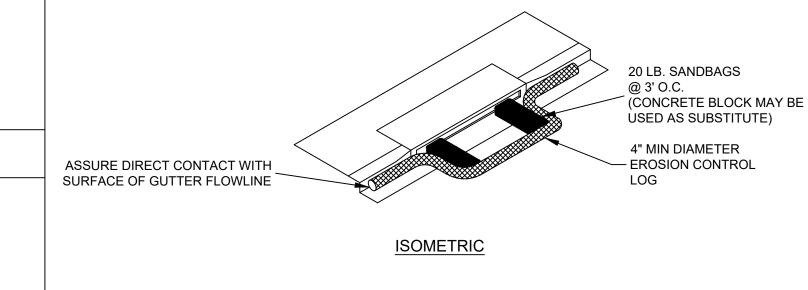

RADIUS = 25' MIN.

8" MIN. DEPTH

NOT TO SCALE

*20' MIN. FOR SINGLE FAMILY AND DUPLEX RESIDENTIAL

1. THE ENTRANCE SHALL BE MAINTAINED IN A CONDITION THAT WILL PREVENT TRACKING OR FLOWING OF SEDIMENT ONTO

3. WHEN WASHING IS REQUIRED, IT SHALL BE DONE ON AN AREA STABILIZED WITH CRUSHED STONE THAT DRAINS INTO AN

4. WHERE RUNOFF CONTAINING SEDIMENT-LADEN WATER IS LEAVING THE SITE VIA THE CONSTRUCTION ENTRANCE, OTHER

COMMERCIAL
50' LONG BY 20' WIDE, 3-6" DEEP CLEAN ROCK. GOVERNING AUTHORITY MAY REQUIRE GEOTEXTILE FABRIC TO

2. WHEN NECESSARY, WHEELS SHALL BE CLEANED PRIOR TO ENTRANCE ONTO PUBLIC RIGHT-OF-WAY.

MEASURES SHALL BE IMPLEMENTED TO DIVERT RUNOFF THROUGH AN APPROVED FILTERING SYSTEM.

PUBLIC RIGHT-OF-WAYS. THIS MAY REQUIRE TOP DRESSING, REPAIR AND/OR CLEAN OUT OF ANY MEASURES USED TO TRAP

SUBGRADE REINFORCEMENT GEOTEXTILE, AS REQUIRED

20' LONG BY 20' WIDE, 8" DEEP OF 3/4" MINUS CLEAN ROCK.


SEE NOTES BELOW FOR MATERIAL SPECS


APPROVED SEDIMENT TRAP OR SEDIMENT BASIN.

PREVENT SUB-SOIL PUMPING.

CONSTRUCTION ENTRANCE

DIMENSIONS:

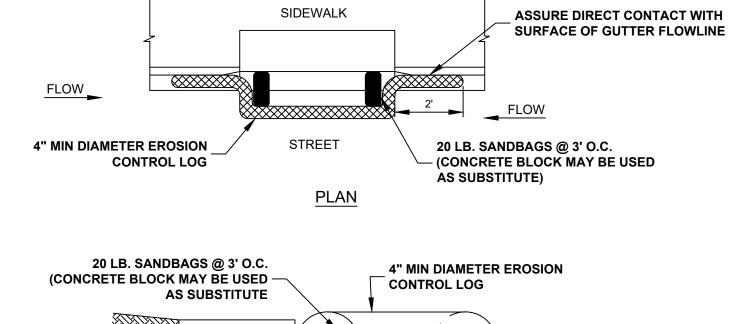


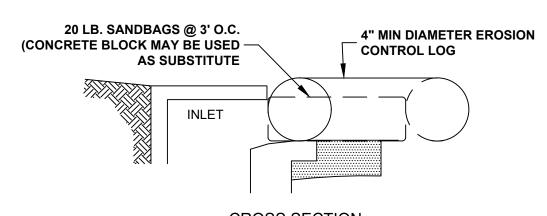

CROSS SECTION

- 1. EROSION CONTROL LOG CONTAINMENT MESH SHALL BE 100% BIODEGRADABLE, PHOTODEGRADABLE OR RECYCLABLE; AND FILL MATERIAL SHALL CONSIST OF MULCH, ASPEN EXCELSIOR FIBERS, CHIPPED SITE VEGETATION, COCONUT FIBERS, 100%
- RECYCLABLE FIBERS, OR ANY OTHER ACCEPTABLE MATERIAL EXCLUDING STRAW AND HAY. 2. DAILY INSPECTION SHALL BE MADE BY THE CONTRACTOR AND SILT ACCUMULATION MUST BE REMOVED WHEN DEPTH **REACHES 50% CAPACITY.**
- 3. CONTRACTOR SHALL MONITOR THE PERFORMANCE OF INLET PROTECTION DURING EACH RAINFALL EVENT AND IMMEDIATELY REMOVE THE INLET PROTECTIONS IF THE STORM WATER BEGINS TO OVERTOP THE CURB.
- 4. INLET PROTECTIONS SHALL BE REMOVED AS SOON AS THE SOURCE OF SEDIMENT IS STABILIZED.



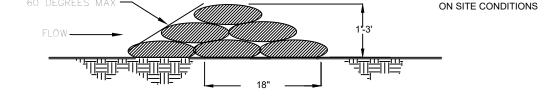

LENGTH = 2X

HEIGHT OF DAM

PROFILE

<u>PROFILE</u>

CROSS SECTION

(MIRAFI 100X OR -STEEL FENCE POST OR EQUAL) OVER WIR 6' MAX IF SLICING METHOD USED 2X2 CONSTRUCTION MESH (9 CA, 6X6 GRADE LUMBER, 4' LONG MESH) STEN WITH 3 DIAGONAL CABLE TIES AT END POSTS


1. PLACE SILT FENCE AT DOWNSLOPE LIMIT OF AREA TO BE GRADED. 2. SILT FENCE SHALL BE PLACED ALONG A LEVEL CONTOUR

3. SEDIMENT TRAPPED BY THIS PRACTICE SHALL BE DISPOSED OF IN AN APPROVED SITE IN A MANNER THAT WILL NOT CONTRIBUTE TO ADDITIONAL SILTATION. 4. SILT FENCE SHOULD BE SECURELY FASTENED TO EACH SUPPORT POST OR


DIAGONAL CABLE TIES

AT INTERIOR POSTS

- TO WOVEN WIRE, WHICH IS IN TURN ATTACHED TO THE STEEL FENCE POSTS. 5. INSPECTION SHALL BE FREQUENT AND REPAIR OR REPLACEMENT SHALL BE
- MADE PROMPTLY AS NEEDED. 6. SILT FENCE SHALL BE REMOVED WHEN IT HAS SERVED ITS USEFULNESS SO AS NOT TO BLOCK OR IMPEDE STORM FLOW OR DRAINAGE.
- 7. ACCUMULATED SILT SHALL BE REMOVED WHEN IT REACHES 50% CAPACITY 8. AT EACH END OF SILT FENCE, TURN FENCE UPSLOPE AND EXTEND UNTIL GROUND SURFACE RISES 18 INCHES.

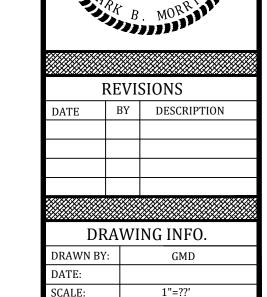

SHEET NUMBER:

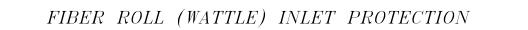

<u>ISOMETRIC</u>

1. NUMBER OF BAGS AND

ARRANGEMENT MAY VARY WITH

IF SLOPE IS 4:1 (H:V) ROLLS

4. IF SLOPE IS GREATER THAN 2: ROLLS SHOULD BE MAX. 10 FT

3. IF SLOPE IS BETWEEN 4:1 & 2:1 ROLLS SHOULD BE MAX. 15

> SLOPE WHERE IT TRANSITIONS INTO A STEEPER SLOPE

> > — FAIRCLOTH SKIMMER OR

EQUIVALENT (SEE PLANS FOR SIZE)

TYPICAL FIBER ROLL INSTALLATION

__100 YR Hw _____

CMP ELBOW SECTION

– PROPOSED GRADE

LEVEL CENTER SECTION


BOTH SIDES TO CAUSE FLOW OVER, NOT AROUND CHECK DAM

CROSS SECTION

EACH SIDE TO ENSURE CONTACT T

INFLOW PIPE

GROUND SURFACE.

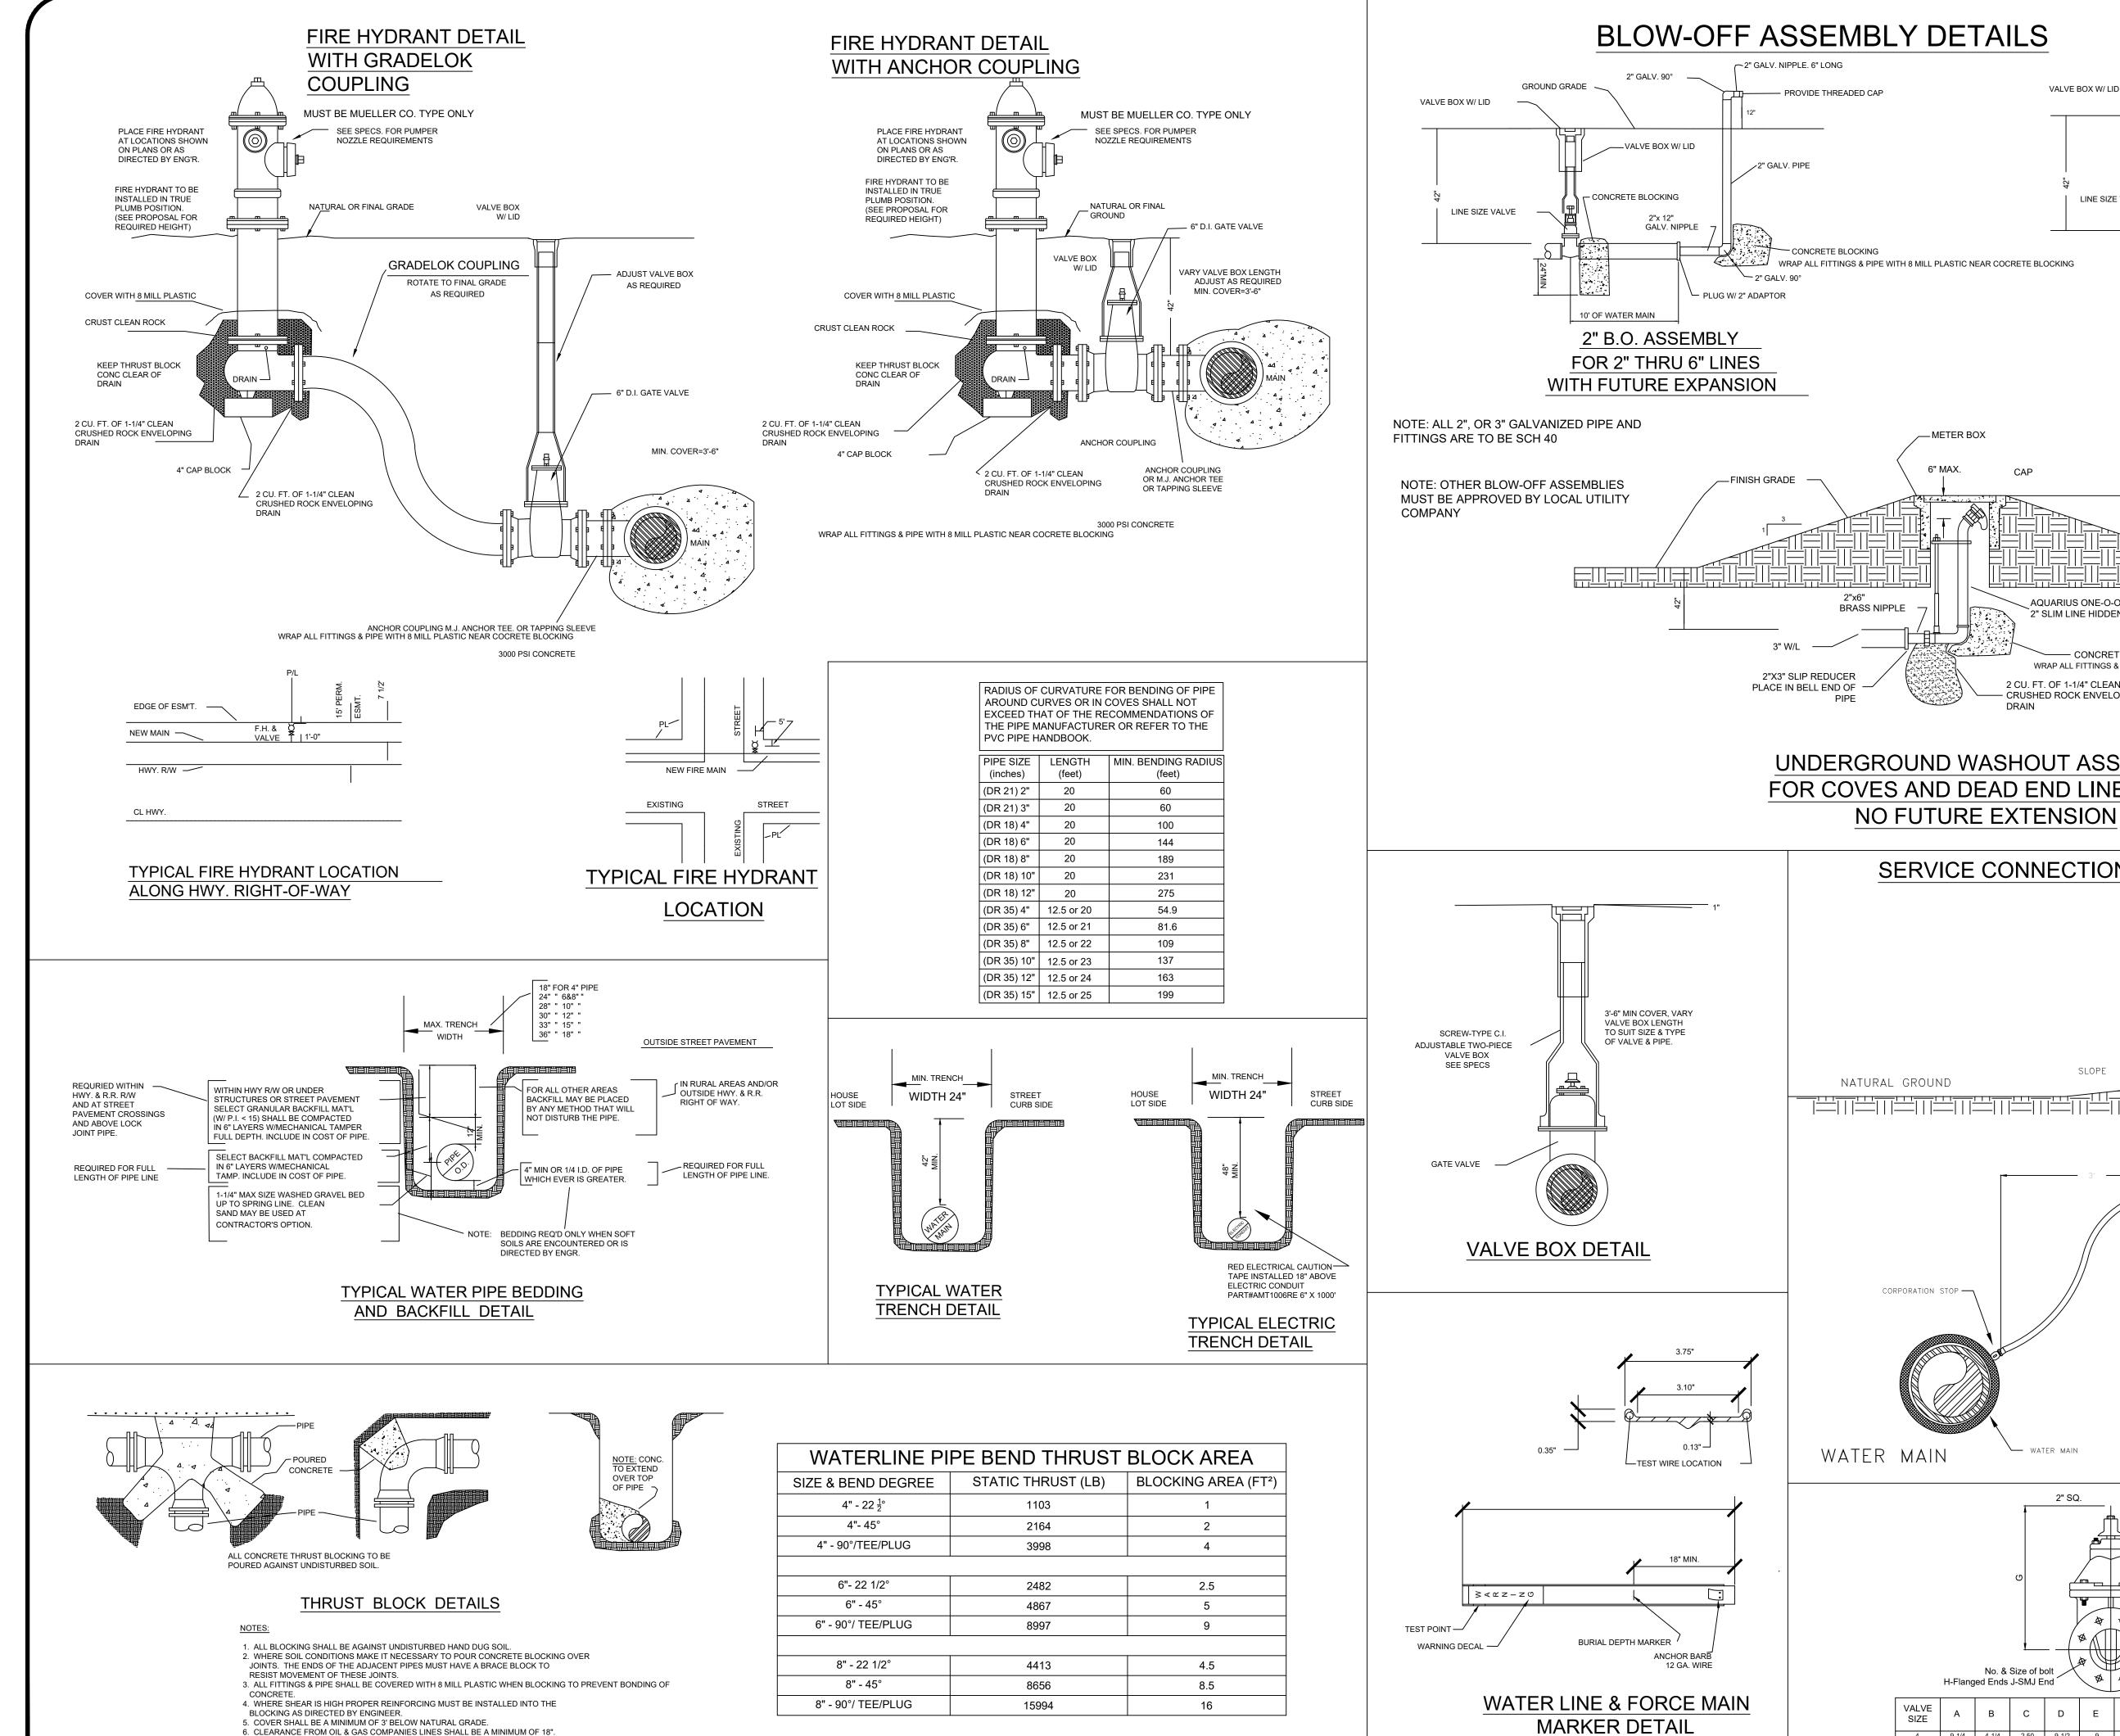


6. CLEARANCE FROM OIL & GAS COMPANIES LINES SHALL BE A MINIMUM OF 18".


BEARING CAPACITY OF 1000 PSF.


8. ALL CONCRETE SHALL BE 3000 PSI AT 28 DAY STRENGTH.


7. THRUST BLOCKING DIMENSIONS SHALL BE 150% OF THE THRUST CALCULATED FROM THE FORMULA (THRUST=2(A)(P)*SIN(θ /2): WHERE A=PIPE END AREA. P=PRESSURE

PRODUCED BY PUMPING LIQUID. & θ=ANGLE OF BEND TO BE BLOCKED) AND SOIL

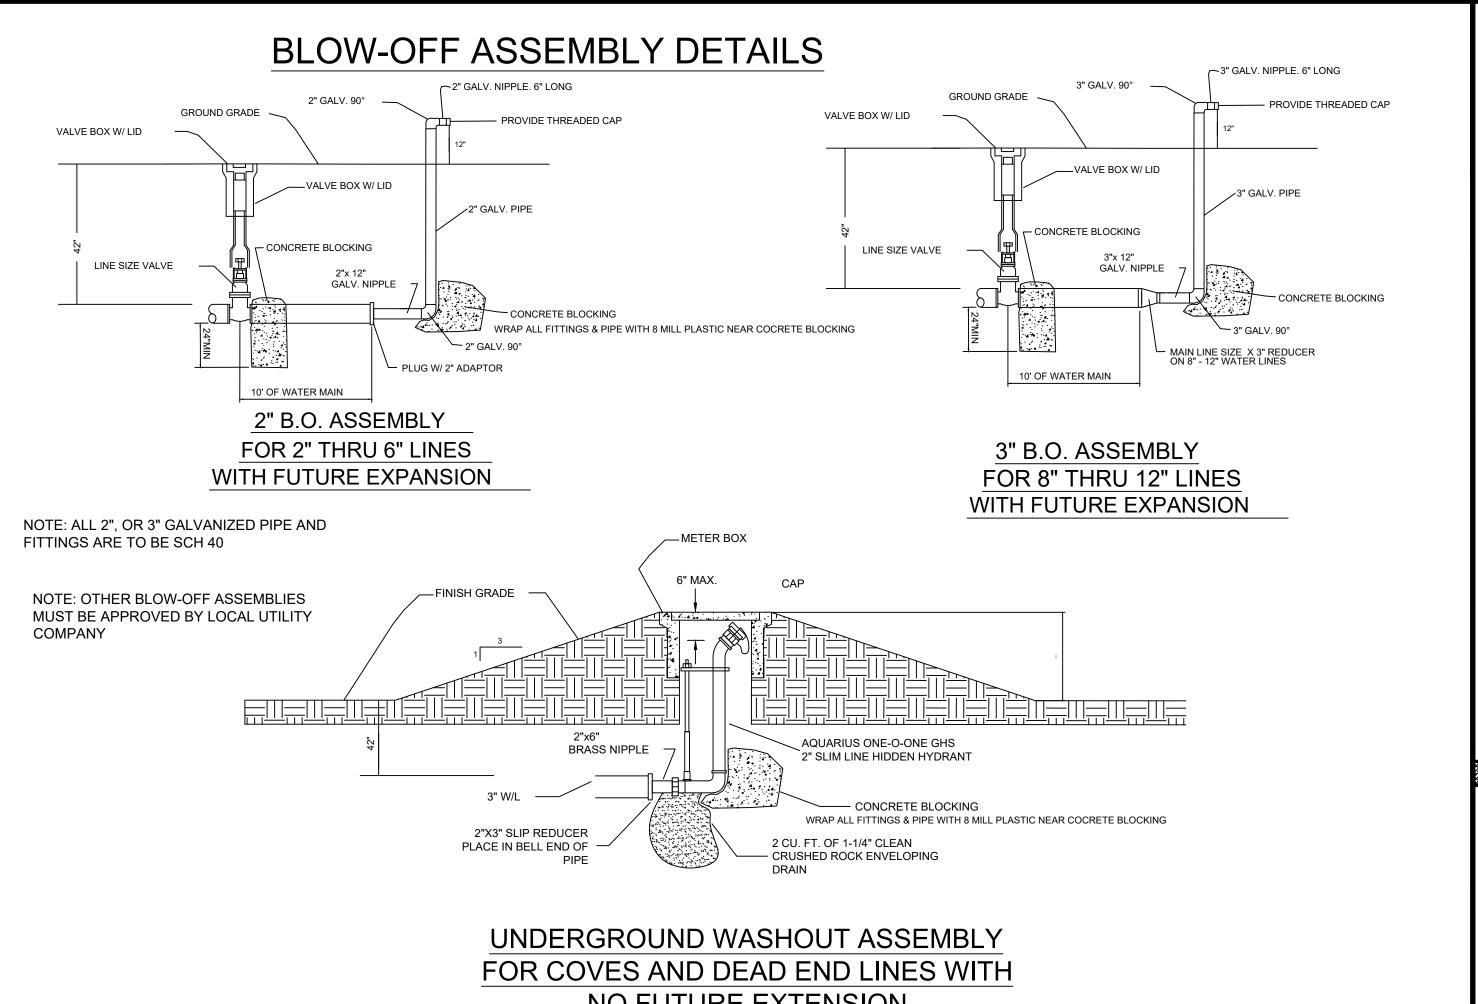

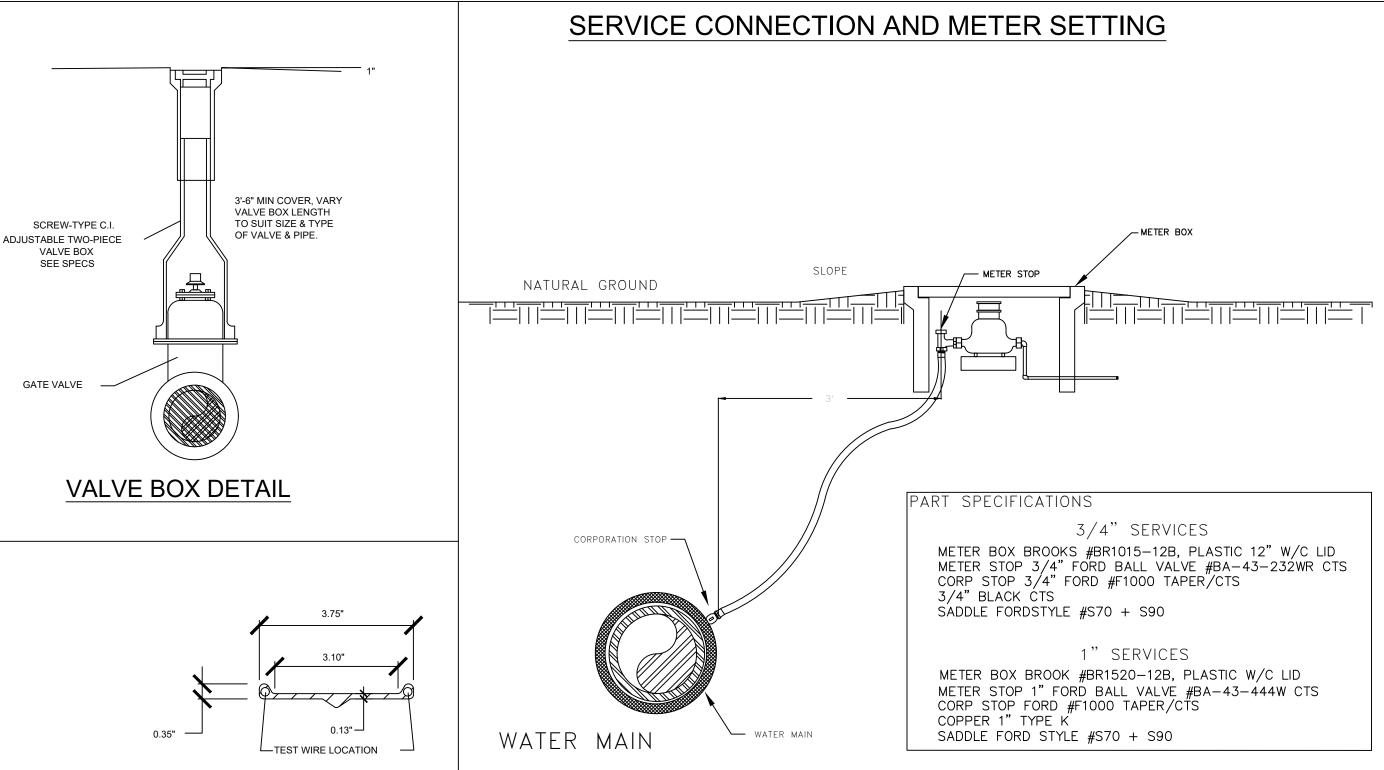

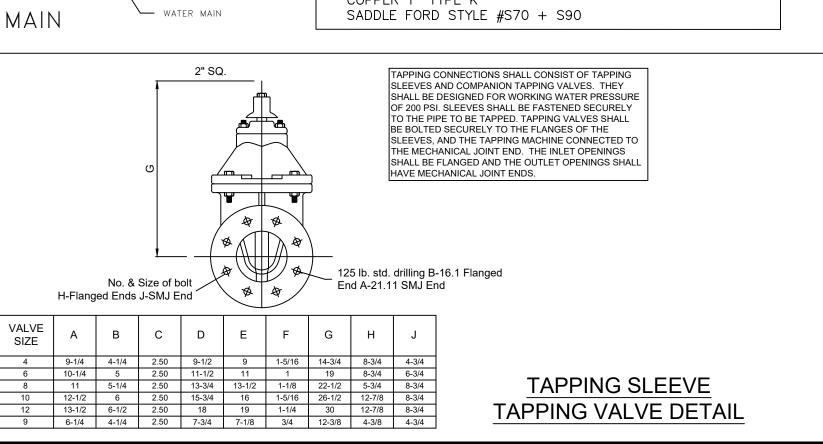

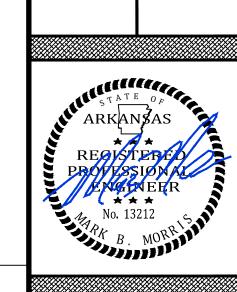


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	REVI	SIONS
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- 1. MANHOLE BASES TO BE 4000 PSI, 28 DAY STRENGTH, LIMESTONE MIX CONCRETE ON UNDISTURBED SUB-GRADE OR ON COMPACTED SELECT FILL MATERIAL AS AUTHORIZED.
- 2. MANHOLE SIDEWALL MATERIAL TO BE CONCRETE IN ACCORDANCE
- WITH PROPOSAL FORM REQUIREMENTS.
- a. 4' I.D. FOR SEWER SIZES 6" THRU 24" b. 5' I.D. FOR SEWER SIZES 24" THRU 30"
- c. 6' I.D. FOR SEWER SIZES 36" THRU 42"
- 3. SET MANHOLE TOPS AS FOLLOWS: a. IN STREETS, ROADS, HIGHWAYS, AND OTHER PAVED AREAS: FLUSH WITH
- FINISHED PAVING GRADE.
- b. UNDEVELOPED AREAS, SUCH AS FIELDS, WOODS, ETC..: 12" ABOVE GROUND. c. OTHER AREAS: 1" ABOVE GROUND.
- 4. MANHOLE FRAMES SHALL HAVE MIN. OPENING OF 22" DIA.
- 5. ALL DOGHOUSE MANHOLES TO BE INSTALLED WITH A-LOK WEDGE STYLE WATER STOP KITS.


STANDARD MANHOLE



$\frac{\mathsf{PLAN}}{\mathsf{N.T.S.}}$ MANHOLE DETAILS

AIR/VACUUM RELEASE VALVE DETAIL

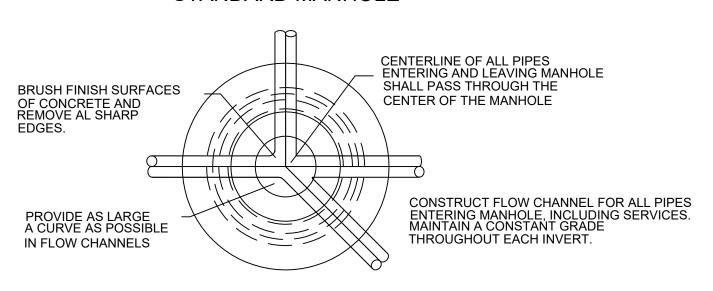
SIDE ELEVATION

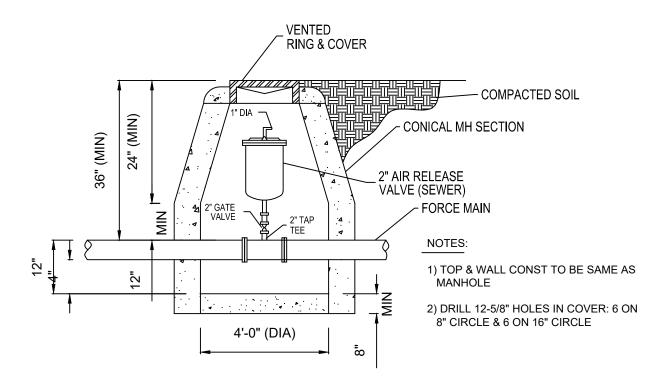

NON-EXISTING STREET LOCATIONS SDR-26 PVC TRENCH DETAIL

NOTES:

- 1. COARSE AGGREGATE SHALL BE MECHANICALLY TAMPED WHEN USED. 2. PIPE IN TRENCH SHALL BE PLACED ON NO LESS THAN 4" OF 3/4" MINUS LIMESTONE. ALL OVER EXCAVATION SHALL BE COMPACTED BACK TO GRADE W/ BEDDING MATERIAL.
- 3. PVC PIPE SHALL BE SDR-26 AND INSTALLED IN ACCORDANCE WITH UNI-BELL PVC PIPE ASSOCIATION'S RECOMMENDATIONS FOR CONSTRUCTION.

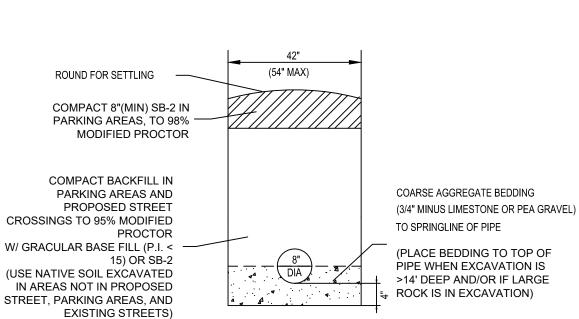

NOTE: REFER TO PLANS FOR GRADE SEPERATION

- SUPPORT BLOCKING ON ALL SIDES -


SUPPORT BLOCKING ON ALL SIDES —

 $\stackrel{\frown}{-}$ NOTE: FLEXIBLE WATER TIGHT END SEALS WITH STAINLESS STEEL BAND, CASCADE MODEL#CCES OR EQUAL

MANHOLE

CONSTRUCTION DETAIL

5' MAX SPACING

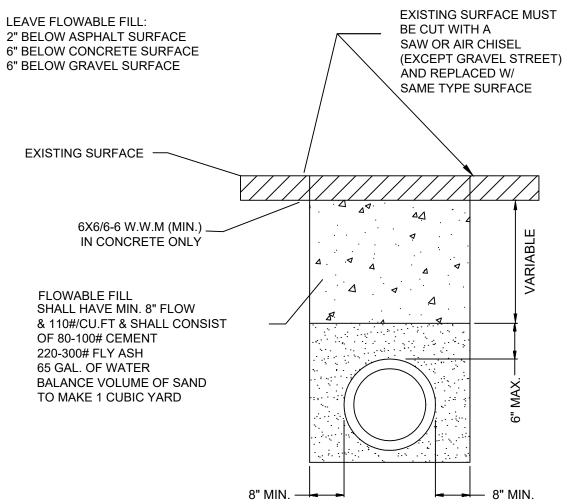

EXISTING STREET LOCATIONS

USE 4" PERFORATED SDR-35 PVC PIPE AS MARKERS @ END OF LATERALS 3'-4' ABOVE GROUND PAINTED GREEN FOR

IDENTIFICATION MARKER

PVC TRENCH DETAIL

WATER MAIN

ENCASEMENT

USE 4" PERFORATED SDR-35 PVC PIPE AS MARKERS @ END OF LATERALS 3'-4' ABOVE GROUND PAINTED GREEN FOR IDENTIFICATION MARKER STREET MIN. SLOPE

SINGLE WYE

ALL SERVICE LINES UNDER PAVEMENT SHALL BE

TEE WYE ONLY

SCH 40

SDR-26 X SCH 40 PVC WYE

-HOUSE SERVICE LINE

PVC SCH 40 PIPE W/ PVC SCH 40 COUPLINGS


ENCASEMENT FOR SEWER MAINS AT WATER CROSSINGS NOTE: WHEN 18" VERTICAL SEPERATION CANNOT BE MAINTAINED

1 ★ 5' MAX SPACING


NOTE: 0.25 THICKNESS STEEL OR SCH 40" PVC ENCASEMENT PIPE SHALL EXTEND 10' MINIMUM EACH SIDE OF WATER MAIN

NOTE: REFER TO OPERATING ROUTING NOTE IF WATERLINE CANNOT AVOID GOING UNDER SEWERLINE


SEWER LATERAL STUBOUT PERMITS REQUIRED BEFORE INSTALLATION USE SAME CONFIGURATION FOR MANHOLE STUBOUTS

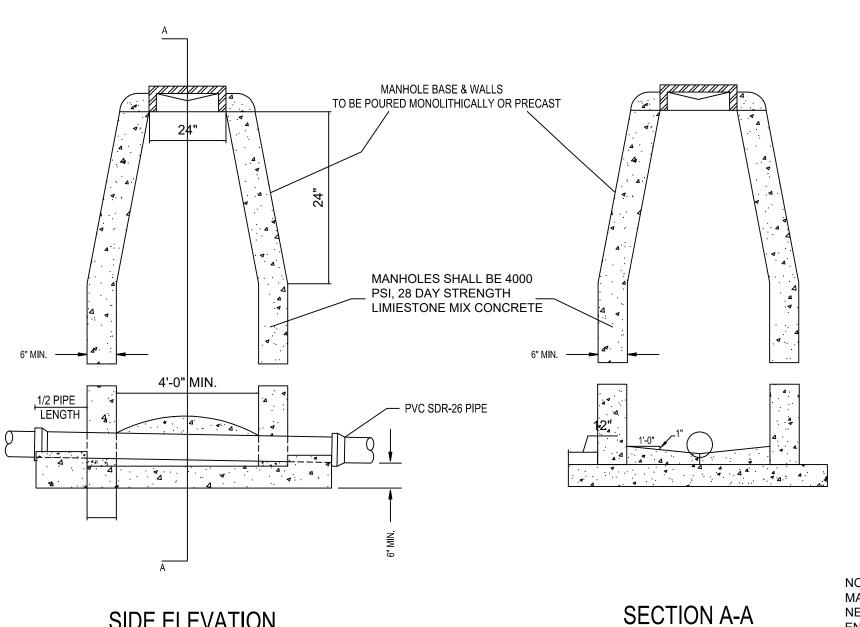

STANDARD MANHOLE

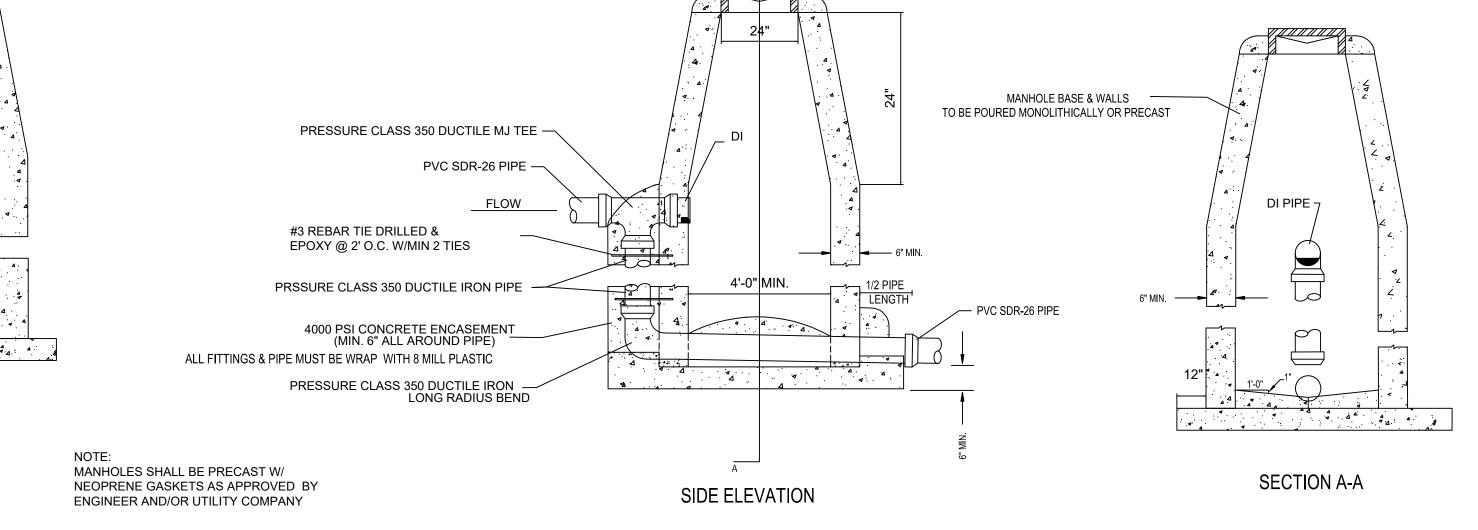

DROP MANHOLE

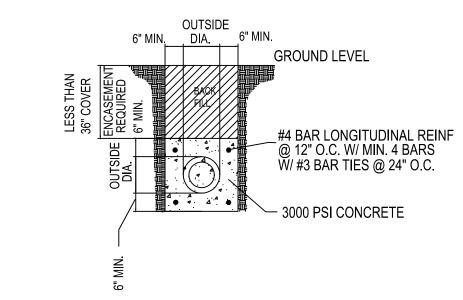

CONCRETE ENCASEMENT FOR DITCH CROSSINGS

NOTE: ENCASEMENT PIPE MUST PRESSURE CLASS 350 DUCTILE IRON AND WRAP DUCTILE IRON PIPE WITH 8 MILL PLASTIC

REVISIONS BY DESCRIPTION DRAWING INFO.

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SHEET NUMBER: DT-3

