CONSTRUCTION NOTES:

- THE DRAWINGS AND SPECIFICATIONS ARE INTENDED TO COVER A COMPLETE PROJECT, READY TO USE, AND ALL ITEMS NECESSARY FOR A COMPLETE AND WORKABLE JOB SHALL BE FURNISHED AND INSTALLED. ANY DISCREPANCY SHALL BE IMMEDIATELY REPORTED TO THE OWNER OR HIS REPRESENTATIVE
- 2. NOTIFY THE INSPECTOR OF THE LOCAL GOVERNING AUTHORITY 24 HOURS BEFORE EVERY PHASE OF CONSTRUCTION.
- 3. ALL WORK SHALL COMPLY WITH ALL APPLICABLE LOCAL, STATE, AND FEDERAL CODES. ALL NECESSARY LICENSES AND PERMITS SHALL BE OBTAINED BY THE CONTRACTOR, AT HIS EXPENSE, UNLESS ALREADY OBTAINED BY THE OWNER.
- 4. THE CONTRACTOR SHALL COORDINATE LOCATION AND INSTALLATION OF ALL UNDERGROUND UTILITIES AND APPURTENANCES TO MINIMIZE DISTURBING CURBING, PAVING, AND ALL OTHER UTILITIES.
- 5. THE EXISTING UTILITIES SHOWN ARE FOR THE CONTRACTOR'S CONVENIENCE ONLY. THERE MAY BE OTHER UTILITIES NOT SHOWN ON THESE DRAWINGS. THE UTILITIES SHOWN ARE THOSE LOCATED BY THE SURVEYOR OF RECORD. THE ENGINEER ASSUMES NO RESPONSIBILITY FOR THE LOCATION OF THE UTILITIES SHOWN. IT SHALL BE THE CONTRACTOR'S RESPONSIBILITY TO VERIFY THE LOCATIONS OF ALL UTILITIES WITHIN THE LIMITS OF WORK. ALL DAMAGE MADE TO EXISTING UTILITIES BY THE CONTRACTOR SHALL BE THE SOLE RESPONSIBILITY OF THE CONTRACTOR
- 6. DEVIATIONS FROM THESE PLANS AND SPECIFICATIONS WITHOUT PRIOR CONSENT OF THE ENGINEER AND THE MUNICIPALITY MAY CAUSE FOR THE WORK TO BE UNACCEPTABLE.
- 7. ALL MATERIALS SHALL BE NEW UNLESS USED OR SALVAGED MATERIALS ARE AUTHORIZED BY THE OWNER.
- 8. THE CONTRACTOR SHALL FURNISH AND MAINTAIN ALL NECESSARY BARRICADES AROUND THE WORK AND SHALL PROVIDE PROTECTION

AGAINST WATER DAMAGE AND SOIL EROSION.

- 9. ALL WORK SHALL BE PERFORMED IN A FINISHED AND WORKMANLIKE MANNER TO THE ENTIRE SATISFACTION OF THE OWNER, AND IN ACCORDANCE WITH THE BEST RECOGNIZED TRADE PRACTICES.
- 10. THE CONTRACTOR SHALL PROVIDE SHEETING AND SHORING FOR ALL TRENCH CONSTRUCTION IN ACCORDANCE WITH OSHA GUIDELINES.11. ALL PIPE LENGTHS SHOWN ARE TO THE CENTERLINE OF THE STRUCTURES
- UNLESS SPECIFICALLY NOTED.

 12. PIPES (STORM AND SANITARY SEWER) SHALL BE LAID ON SMOOTH, CONTINUOUS GRADES WITH NO VISIBLE BENDS AT THE JOINTS.
- 13. BEDDING REQUIREMENTS SPECIFIED HEREIN ARE TO BE CONSIDERED AS MINIMUM REQUIRED FOR RELATIVELY DRY STABLE EARTH CONDITIONS. ADDITIONAL BEDDING SHALL BE REQUIRED FOR ROCK TRENCHES TO PROVIDE SUCH ADDITIONAL BEDDING AS REQUIRED TO PROPERLY
- 14. ALL STORM DRAINAGE INLET STRUCTURES SHALL HAVE METAL RING AND COVER FOR ACCESS.
- 15. ALL ANGLES SHOWN ARE 90 DEGREES UNLESS SHOWN OTHERWISE.
- 16. ALL GRADES SHOWN ARE FINISHED GRADES. CONTRACTOR SHALL VERIFY DIMENSIONS, GRADES, AND EXISTING ELEVATIONS PRIOR TO CONSTRUCTION.
- 17. CONCRETE CURBS SHALL BE CONSTRUCTED IN ACCORDANCE WITH THE DETAILS SHOWN ON PLANS. MATERIALS, EQUIPMENT, METHODS OF CONSTRUCTION AND WORKMANSHIP SHALL CONFORM TO STATE D.O.T. STANDARD SPECIFICATIONS.
- 18. ALL CONCRETE SHALL HAVE 3000 PSI COMPRESSIVE STRENGTH AFTER 28 DAYS, WITH A MAXIMUM SLUMP OF FOUR (4) INCHES, UNLESS SPECIFIED OTHERWISE
- ALL EXPOSED CONCRETE SHALL HAVE A FINE HAIR BROOMED FINISH.
 PARKING AND DRIVEWAY BASE COURSE AND ASPHALTIC CONCRETE SURFACE AND PRIME MATERIALS, EQUIPMENT, METHODS FOR CONSTRUCTION AND WORKMANSHIP SHALL CONFORM TO STATE D.O.T. STANDARD SPECIFICATIONS.
- 21. CONTRACTOR TO FIELD VERIFY <u>ALL</u> STORM, SANITARY, WATER AND OTHER UTILITIES LOCATIONS AND INVERTS PRIOR TO INSTALLATION OF <u>ANY</u> UTILITIES. NOTIFY ENGINEER PRIOR TO PROCEEDING WITH ANY WORK IF DISCREPANCIES FOUND
- 22. CONTRACTOR SHALL USE CONCRETE THRUST BLOCKS FOR INSTALLATION OF WATER MAINS.23. ALL DIMENSIONS ARE MEASURED TO THE BACK OF CURB UNLESS

OTHERWISE NOTED.

EARTHWORK SPECIFICATIONS:

1. CLEARING AND GRUBBING

CLEARING AND GRUBBING SHALL CONSIST OF CLEARING THE SURFACE OF THE GROUND OF THE DESIGNATED AREAS OF ALL TREES, LOGS, SNAGS, BRUSH, UNDERGROWTH, HEAVY GROWTH OF GRASS, WEEDS, FENCE STRUCTURES, DEBRIS AND RUBBISH OF ANY NATURE, NATURAL OBSTRUCTIONS SUCH AS OBJECTIONAL SOIL MATERIAL UNSATISFACTORY FOR FOUNDATIONS. IT SHALL ALSO CONSIST OF GRUBBING OF STUMPS, ROOTS FOUNDATIONS AND DISPOSAL OF ALL SUCH MATERIAL. ALL HOLES REMAINING AFTER THE GRUBBING OPERATION IN EMBANKMENT AREAS AND IN EXCAVATION AREAS LESS THAN TWO (2) FEET IN DEPTH, SHALL HAVE SIDES BROKEN DOWN AND LEVELLED IF NECESSARY TO FLATTEN OUT SLOPES, REFILLED WITH ACCEPTABLE MATERIAL THAT IS PROPERLY COMPACTED IN LAYERS BY TAMPERS, ROLLERS OR CONSTRUCTION

BURNING ON SITE IS NOT PERMITTED WITHOUT WRITTEN APPROVAL OF THE LOCAL GOVERNING AUTHORITIES HAVING JURISDICTION.

2. EXISTING TREES AND AREA OUTSIDE OF GRADING LIMITS LINE

TREES AND VEGETATION TO BE SAVED SHALL BE PROTECTED FROM DAMAGE BY A FENCE BARRICADE PRIOR TO, OR DURING, CLEARING OPERATIONS. TREES TO BE SAVED SHALL BE DESIGNATED BY THE OWNER. NO TREES ARE TO BE REMOVED FROM THE AREA OUTSIDE THE LIMITS OF GRADING OR FROM SPECIFICALLY DESIGNATED AREAS WITHIN THE CONSTRUCTION AREAS. IF, IN THE OPINION OF THE ENGINEER, A CONTRACTOR DAMAGES A TREE NOT TO BE REMOVED, THE CONTRACTOR WILL BE FINED A PREDETERMINED AMOUNT FOR EACH DAMAGED TREE. THE CONTRACTOR SHALL ALSO BE RESPONSIBLE FOR ALL COSTS ASSOCIATED IN REMOVING THE DAMAGED TREES FROM THE SITE.

3 FILL

ALL VEGETATION SUCH AS ROOTS, BRUSH, HEAVY GROWTH OF GRASS, TOPSOIL, ALL DECAYED VEGETABLE MATTER, RUBBISH, AND OTHER LINSUITABLE MATERIAL WITHIN THE AREA UPON WHICH FILL IS TO BE PLACED SHALL BE STRIPPED OR BE OTHERWISE REMOVED BEFORE THE FILL OPERATION IS STARTED. IN NO CASE SHALL UNSUITABLE MATERIAL REMAIN IN OR UNDER THE FILL AREA. SLOPED GROUND SURFACE STEEPER THAN ONE VERTICAL TO FOUR HORIZONTAL ON WHICH FILL IS TO BE PLACED. SHALL BE PLACED. STEPPED OR BENCHED IN SUCH A MANNER THAT THE FILL TO BE PLACED SHALL BE 97 PERCENT OF THE MAXIMUM. LABORATORY DRY DENSITY ACCORDING TO STANDARD PROCTOR (AASHTO T99, ASTM D-698), MOISTURE CONTENT SHALL BE WITHIN 3 PERCENT OF THE OPTIMUM MOISTURE CONTENT, PROOF ROLL THE AREAS. TO BE FILLED OR ON WHICH STRUCTURES ARE TO BE PLACED. A LOADED DUMP TRUCK OR OTHER RUBBER TIRED EQUIPMENT SHALL BE USED PROOF ROLLING, OVERLAPPING PASSES OF A VEHICLE SHOULD BE MADE ACROSS THE SITE IN ONE DIRECTION AND THEN PERPENDICULAR TO THE ORIGINAL DIRECTION OF ROLLING.

ANY YIELDING, PUMPING OR SOFT AREAS SHOULD BE CUT OUT AND REPLACED WITH FILL COMPACTED AS DESCRIBED HEREIN.

THE PROPOSED FILL SHOULD BE LIMITED TO SOILS CLASSIFIED IN ACCORDANCE WITH ASTM D-2487 AS GM, GC, SW, SM, SC, ML AND CL. SOIL CLASSIFIED AS PT, OH, OL, CH AND MH ARE NOT SATISFACTORY AS COMPACTED FILL.

FILLS AND EMBANKMENTS SHALL BE CONSTRUCTED AT THE LOCATIONS AND TO THE LINES AND GRADES INDICATED ON CONSTRUCTION PLANS. (3 FOOT HORIZONTAL TO 1 FOOT VERTICAL IN THE PUBLIC RIGHT OF WAY) THE COMPLETED FILL SHALL CORRESPOND TO THE SHAPE OF THE TYPICAL SECTIONS INDICATED ON THE CONSTRUCTION PLANS. MATERIAL REMOVED FROM THE EXCAVATION SHALL BE USED IN FORMING THE FILI FILL MATERIAL SHALL BE REASONABLY FREE FROM ROOTS, OTHER ORGANIC MATERIAL, TRASH AND STONES HAVING MAXIMUM DIMENSIONS GREATER THAN 6 INCHES (4 INCHES IN TRENCHES FOR UTILITIES). NO FROZEN MATERIAL WILL BE PERMITTED IN THE FILL. STONES HAVING A MAXIMUM DIMENSION OF 4 INCHES WILL NOT BE PERMITTED IN THE UPPER SIX INCHES OF FILL OR EMBANKMENT OR UTILITY TRENCH. THE MATERIAL SHALL BE PLACED IN SUCCESSIVE HORIZONTAL LAYERS NOT MORE THAI 8 INCHES THICK, UNLESS OTHERWISE NOTED, IN LOOSE DEPTH FOR THE WIDTH OF THE CROSS-SECTION AND SHALL BE COMPACTED TO AT LEAST 97 PERCENT OF THE MAXIMUM LABORATORY DRY DENSITY ACCORDING TO STANDARD PROCTOR (ASTM D-698, AASHTO T-99), MOISTURE SHALL BE WITHIN 3 PERCENT OF THE OPTIMUM MOISTURE CONTENT. THE TOP 12 INCHES OF THE PAVING, PARKING AND/OR ROADWAY SUB-GRADE SHALL BE COMPACTED TO 97 PERCENT OF THE MAXIMUM DRY DENSITY (STANDARD PROCTOR), EACH LIFT SHALL BE ROLLED WITH A VIBRATORY ROLLER, A SHEEPSFOOT ROLLER, OR A LOADED RUBBER TIRED DUMP TRUCK, SCRAPER OR LOADER, IF THE SOIL IS TOO DRY, A WATER TRUCK WITH SPREADER BAR OR SPRAY HOSE SHALL BE USED TO BRING THE SOIL TO THE PROPER MOISTURE RANGE. THE WATER SHALL BE THOROUGHLY AND PROPERLY MIXED WITH THE SOIL PRIOR TO COMPACTION

STORM DRAIN PIPES SHALL BE PLACED ON FIRM BOTTOM AND HAND TAMPED TO SAFE UP THE PIPE. A CUSHION OF SOIL SHALL BE TAMPED ABOVE THE CROWN OF THE PIPE IN ACCORDANCE WITH THE PIPE MANUFACTURER'S RECOMMENDATIONS SO THAT THE HEAVIER COMPACTION EQUIPMENT CAN THEN BE USED TO BRING THE SOIL TO A DENSITY AS DESCRIBED ABOVE FOR FILL AREAS.

IF SOILS INVESTIGATION REPORT IS PROVIDED, THEN FOLLOW THE RECOMMENDATIONS OF THE REPORT IF THEY EXCEED THE

RECOMMENDATIONS OF THESE SPECIFICATIONS. 4 TOPSOIL

UNLESS OTHERWISE SPECIFIED, AREAS DESIGNATED FOR GRADING OPERATIONS THAT CONTAIN A BLANKET OF TOPSOIL SHALL BE STRIPPED AND PLACED IN CONVENIENT STOCKPILES FOR LATER USE AS A TOPSOIL BLANKET ON THE NEW GRADED AREAS SPECIFIED HEREIN, OR AS DESIGNATED. TOPSOIL SHALL BE STRIPPED FROM ALL AREAS DESIGNATED TO RECEIVE FILL. THE STRIPPING OF MATERIAL FOR TOPSOIL SHALL BE CAREFULLY DETERMINED AND ONLY THE QUANTITY REQUIRED SHALL BE STOCKPILED. MATERIAL STOCKPILED SHALL BE STORED IN A SATISFACTORY MANNER TO AFFORD PROPER DRAINAGE. WHEN GRADING OPERATIONS PERMIT, INSTEAD OF STOCKPILING, THE TOPSOIL SHALL BE HAULED AND SPREAD DIRECTLY ON THE AREAS DESIGNATED TO RECEIVE TOPSOIL.

5. ROCK EXCAVATION

IF ROCK IS ENCOUNTERED, CLEAR AWAY EARTH TO EXPOSE MATERIAL.
NOTIFY OWNER AND RECEIVE WRITTEN INSTRUCTIONS PRIOR TO
EXCAVATION. REMOVE ROCK TO A DEPTH OF 6 INCHES BELOW AND 8
INCHES ON EACH SIDE OF PIPES IN TRENCHES. A MEASUREMENT OF
EXTENT OF ROCK TO BE REMOVED SHALL BE MADE. ROCK EXCAVATION
SHALL BE PAID FOR IN ACCORDANCE WITH AGREEMENT WITH THE OWNER.


SITE DEVELOPMENT PLANS

VERIZON WIRELESS RETAIL

FOR

CONCORD PROPERTIES INC.

PARCELS 01-144281-50100, 01-144281-14400 01-144281-14500 & 01-144281-14600 2212 STADIUM BOULEVARD JONESBORO, ARKANSAS AUGUST 24, 2012

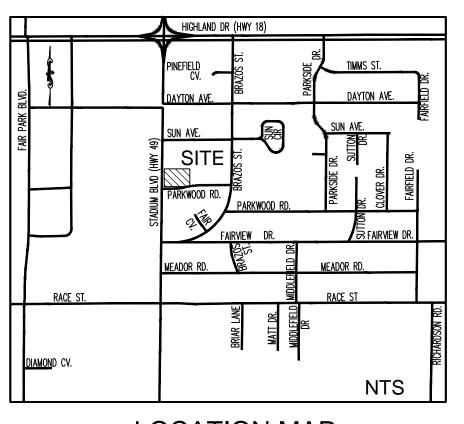

LOCATION MAP SCALE: N.T.S.

GENERAL NOTES:

OWNER / DEVELOPER:


CONCORD PROPERTIES INC. 1338 Harding Place, Suite 100 Charlotte, NC 28204 Contact: Jeff Irvin Tel. (704) 405-9400 Carter Engineering Consultants, Inc. 1551 Jennings Mill Rd., Bldg 500, Suite B Bogart, Georgia 30622 Contact: Mark Campbell P.E. Tel. (706) 559-7430 Fax. (706) 559-7435 mark@carterengineering.net

SHEET INDEX

SHEET NO.	DESCRIPTION
1	COVER SHEET
2	EXISTING CONDITIONS & DEMOLITION PLAN
3	SITE PLAN
4	UTILITY PLAN
5	GRADING & DRAINAGE PLAN
6	EROSION CONTROL PLAN
7	STANDARD DETAILS
8	ADA ACCESS PLAN
9	LANDSCAPE PLAN

REVISION BLOCK

REV. NO.	DATE	DESCRIPTION
А	8/24/12	CITY SUBMITTAL

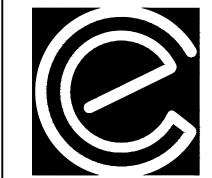

1-800-482-8998

Carter Engineering Consultants, Inc. 1551 Jennings Mill Rd Building 500, Suite B Bogart, GA 30622 P: 706.559.7430

F: 706.559.7430 F: 706.559.7435 www.carterengineering.net





24-HOUR CONTACT: JEFF IRVIN (704) 405-9400

SITE DEVELOPMENT PLANS
OF

VERIZON WIRELESS
RETAIL

CONCORD PROPERTIES INC. 0.91 ACRES, ZONED: C-3 LUO DISTURBED AREA: 0.9 ACRES

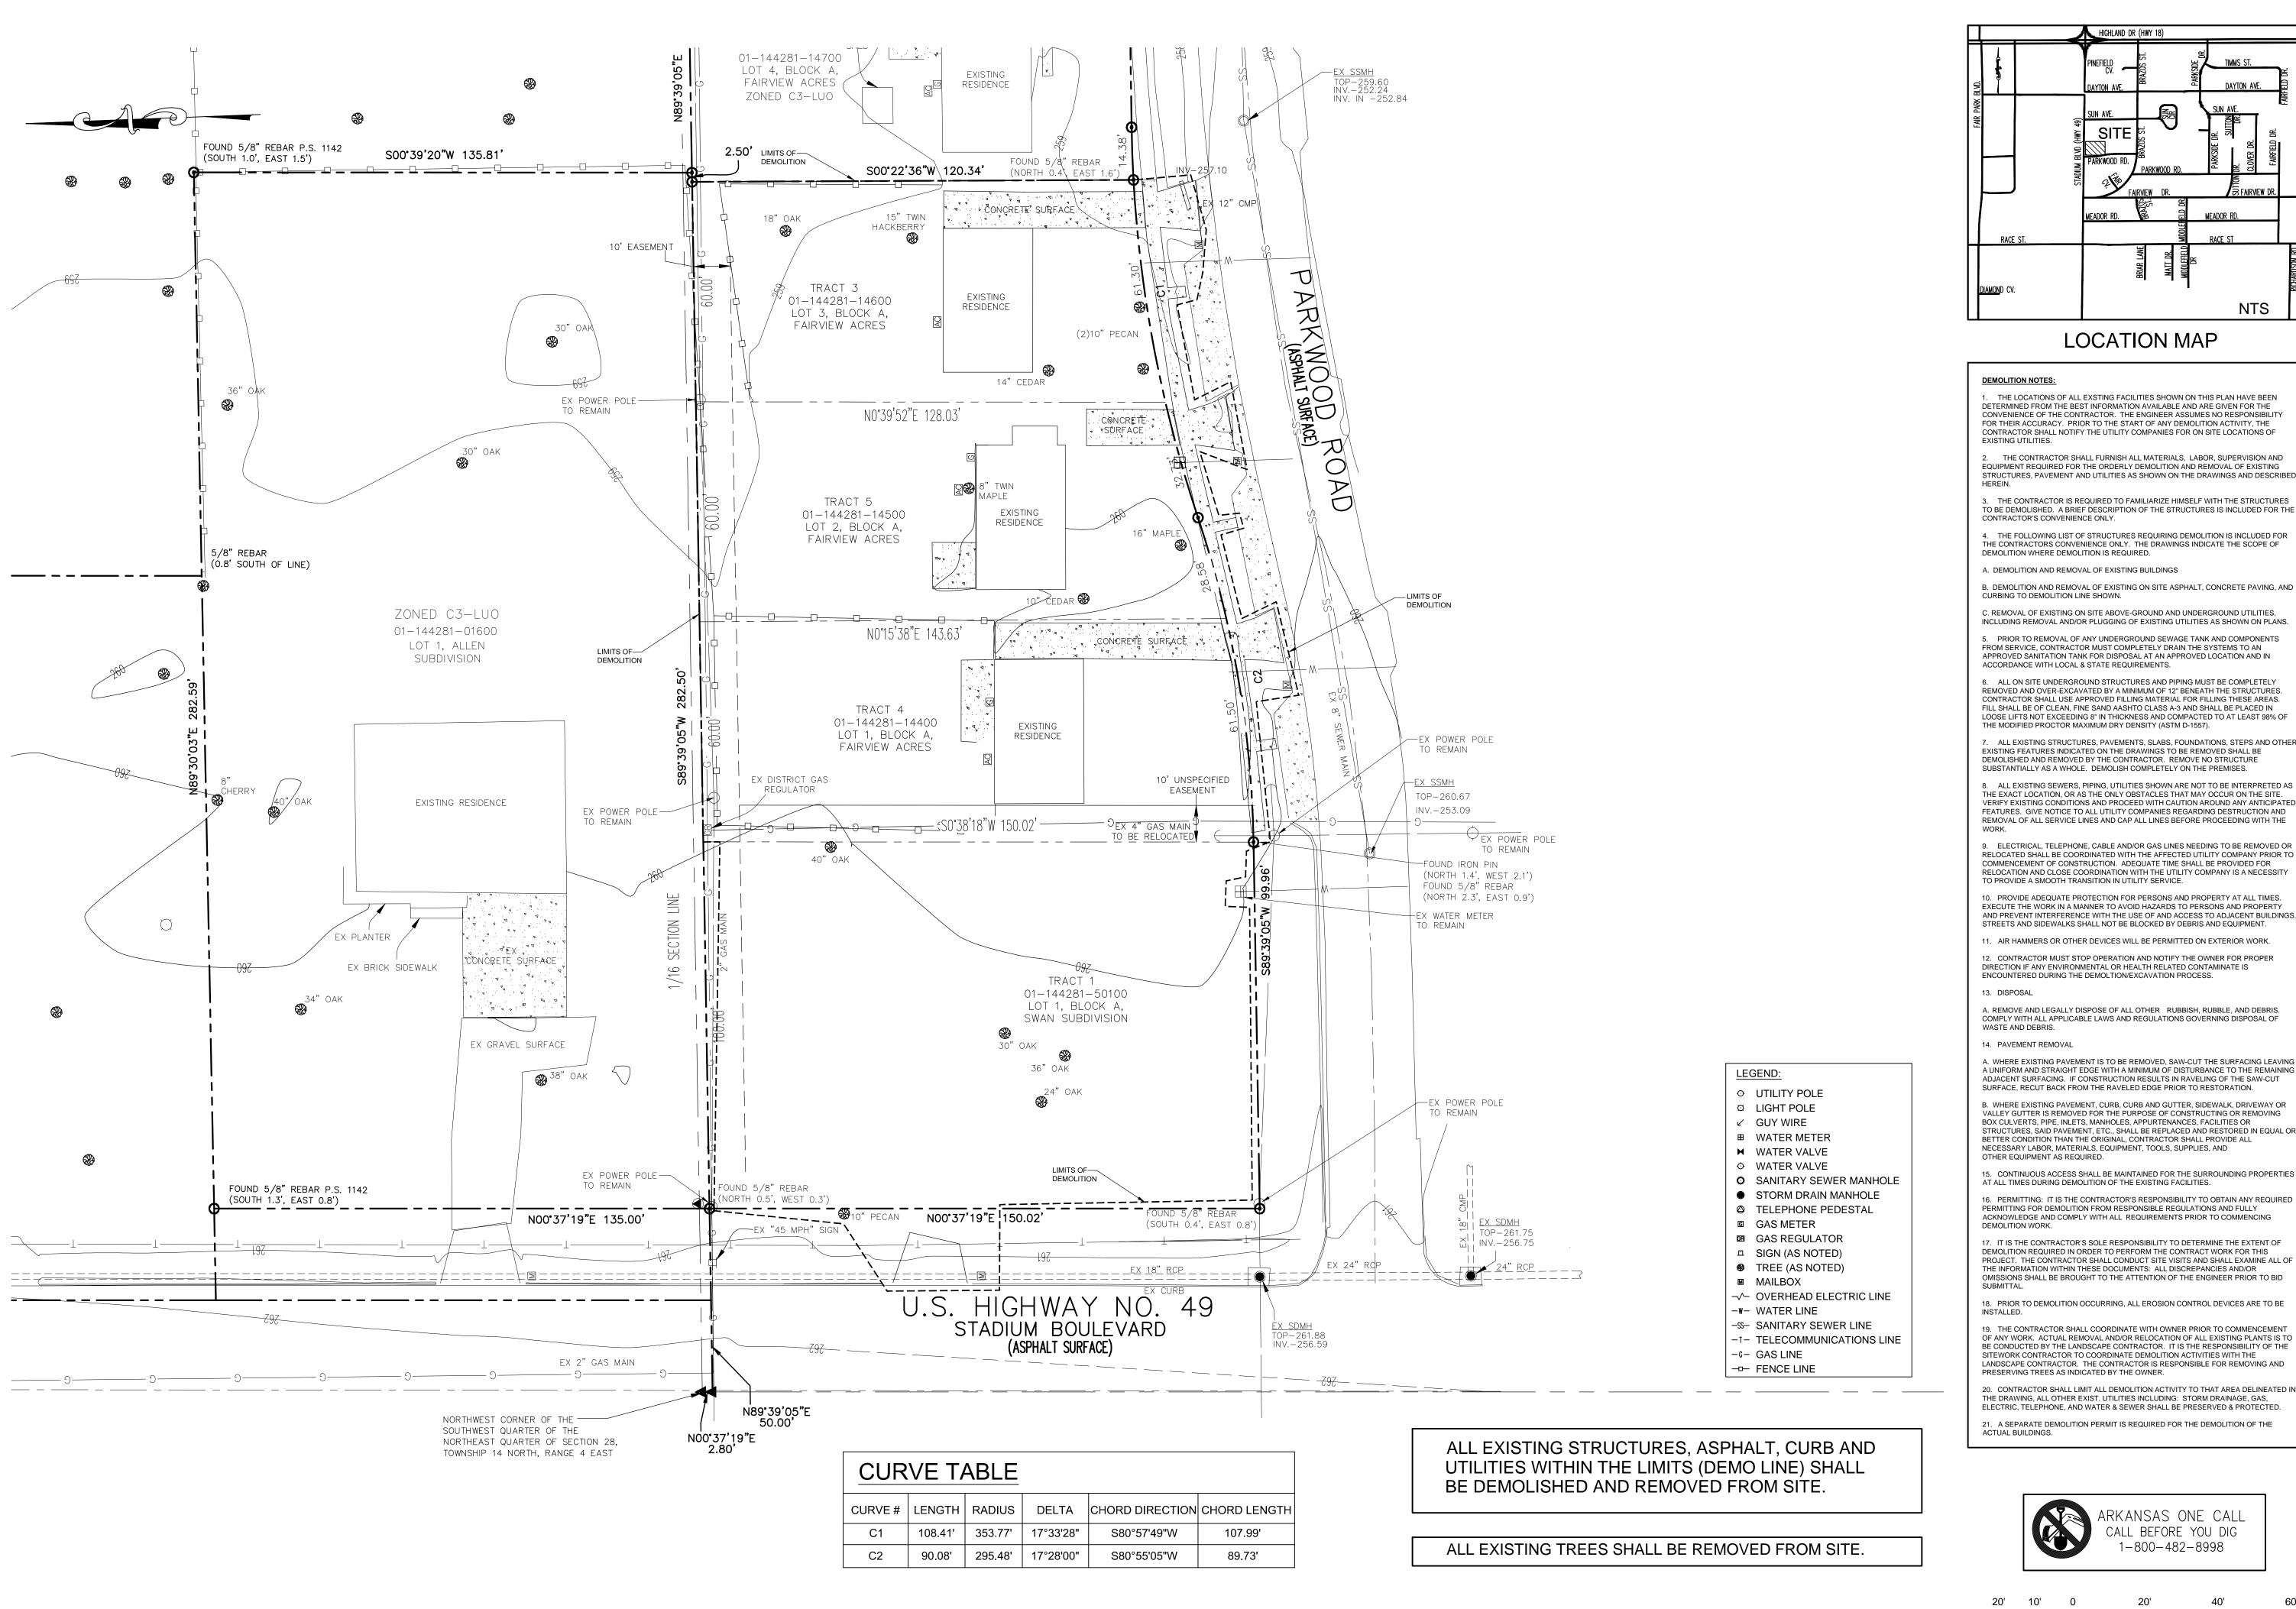

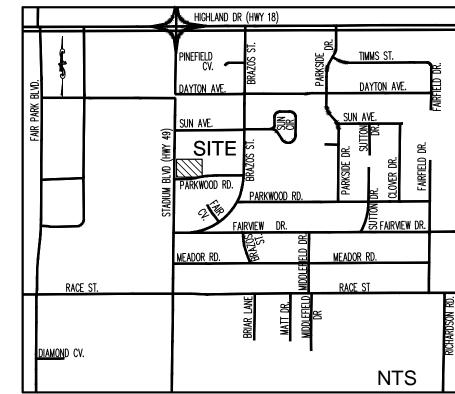

DEMOLITION NOTES:

I. THE LOCATIONS OF ALL EXSTING FACILITIES SHOWN ON THIS PLAN HAVE BEEN DETERMINED FROM THE BEST INFORMATION AVAILABLE AND ARE GIVEN FOR THE CONVENIENCE OF THE CONTRACTOR. THE ENGINEER ASSUMES NO RESPONSIBILITY FOR THEIR ACCURACY. PRIOR TO THE START OF ANY DEMOLITION ACTIVITY, THE CONTRACTOR SHALL NOTIFY THE UTILITY COMPANIES FOR ON SITE LOCATIONS OF

2. THE CONTRACTOR SHALL FURNISH ALL MATERIALS, LABOR, SUPERVISION AND EQUIPMENT REQUIRED FOR THE ORDERLY DEMOLITION AND REMOVAL OF EXISTING STRUCTURES, PAVEMENT AND UTILITIES AS SHOWN ON THE DRAWINGS AND DESCRIBED

TO BE DEMOLISHED. A BRIEF DESCRIPTION OF THE STRUCTURES IS INCLUDED FOR THE CONTRACTOR'S CONVENIENCE ONLY.

4. THE FOLLOWING LIST OF STRUCTURES REQUIRING DEMOLITION IS INCLUDED FOR THE CONTRACTORS CONVENIENCE ONLY. THE DRAWINGS INDICATE THE SCOPE OF DEMOLITION WHERE DEMOLITION IS REQUIRED.

A. DEMOLITION AND REMOVAL OF EXISTING BUILDINGS

B. DEMOLITION AND REMOVAL OF EXISTING ON SITE ASPHALT, CONCRETE PAVING, AND CURBING TO DEMOLITION LINE SHOWN.

C. REMOVAL OF EXISTING ON SITE ABOVE-GROUND AND UNDERGROUND UTILITIES, INCLUDING REMOVAL AND/OR PLUGGING OF EXISTING UTILITIES AS SHOWN ON PLANS.

. PRIOR TO REMOVAL OF ANY UNDERGROUND SEWAGE TANK AND COMPONENTS FROM SERVICE, CONTRACTOR MUST COMPLETELY DRAIN THE SYSTEMS TO AN APPROVED SANITATION TANK FOR DISPOSAL AT AN APPROVED LOCATION AND IN ACCORDANCE WITH LOCAL & STATE REQUIREMENTS.

6 ALL ON SITE UNDERGROUND STRUCTURES AND PIPING MUST BE COMPLETELY REMOVED AND OVER-EXCAVATED BY A MINIMUM OF 12" BENEATH THE STRUCTURES. CONTRACTOR SHALL USE APPROVED FILLING MATERIAL FOR FILLING THESE AREAS. FILL SHALL BE OF CLEAN, FINE SAND AASHTO CLASS A-3 AND SHALL BE PLACED IN LOOSE LIFTS NOT EXCEEDING 8" IN THICKNESS AND COMPACTED TO AT LEAST 98% OF

7. ALL EXISTING STRUCTURES, PAVEMENTS, SLABS, FOUNDATIONS, STEPS AND OTHER EXISTING FEATURES INDICATED ON THE DRAWINGS TO BE REMOVED SHALL BE DEMOLISHED AND REMOVED BY THE CONTRACTOR. REMOVE NO STRUCTURE SUBSTANTIALLY AS A WHOLE. DEMOLISH COMPLETELY ON THE PREMISES.

8. ALL EXISTING SEWERS, PIPING, UTILITIES SHOWN ARE NOT TO BE INTERPRETED AS THE EXACT LOCATION OR AS THE ONLY OBSTACLES THAT MAY OCCUR ON THE SITE VERIFY EXISTING CONDITIONS AND PROCEED WITH CAUTION AROUND ANY ANTICIPATED FEATURES. GIVE NOTICE TO ALL UTILITY COMPANIES REGARDING DESTRUCTION AND REMOVAL OF ALL SERVICE LINES AND CAP ALL LINES BEFORE PROCEEDING WITH THE

9. ELECTRICAL, TELEPHONE, CABLE AND/OR GAS LINES NEEDING TO BE REMOVED OR RELOCATED SHALL BE COORDINATED WITH THE AFFECTED UTILITY COMPANY PRIOR TO COMMENCEMENT OF CONSTRUCTION. ADEQUATE TIME SHALL BE PROVIDED FOR TO PROVIDE A SMOOTH TRANSITION IN UTILITY SERVICE.

EXECUTE THE WORK IN A MANNER TO AVOID HAZARDS TO PERSONS AND PROPERTY AND PREVENT INTERFERENCE WITH THE USE OF AND ACCESS TO ADJACENT BUILDINGS. STREETS AND SIDEWALKS SHALL NOT BE BLOCKED BY DEBRIS AND EQUIPMENT.

11. AIR HAMMERS OR OTHER DEVICES WILL BE PERMITTED ON EXTERIOR WORK.

12. CONTRACTOR MUST STOP OPERATION AND NOTIFY THE OWNER FOR PROPER DIRECTION IF ANY ENVIRONMENTAL OR HEALTH RELATED CONTAMINATE IS

ENCOUNTERED DURING THE DEMOLTION/EXCAVATION PROCESS.

A. REMOVE AND LEGALLY DISPOSE OF ALL OTHER RUBBISH, RUBBLE, AND DEBRIS. COMPLY WITH ALL APPLICABLE LAWS AND REGULATIONS GOVERNING DISPOSAL OF WASTE AND DEBRIS

A. WHERE EXISTING PAVEMENT IS TO BE REMOVED, SAW-CUT THE SURFACING LEAVING A UNIFORM AND STRAIGHT EDGE WITH A MINIMUM OF DISTURBANCE TO THE REMAINING ADJACENT SURFACING. IF CONSTRUCTION RESULTS IN RAVELING OF THE SAW-CUT SURFACE, RECUT BACK FROM THE RAVELED EDGE PRIOR TO RESTORATION.

B. WHERE EXISTING PAVEMENT, CURB, CURB AND GUTTER, SIDEWALK, DRIVEWAY OR VALLEY GUTTER IS REMOVED FOR THE PURPOSE OF CONSTRUCTING OR REMOVING BOX CUI VERTS PIPE INLETS MANHOLES APPURTENANCES FACILITIES OR STRUCTURES, SAID PAVEMENT, ETC., SHALL BE REPLACED AND RESTORED IN EQUAL O BETTER CONDITION THAN THE ORIGINAL, CONTRACTOR SHALL PROVIDE ALL NECESSARY LABOR, MATERIALS, EQUIPMENT, TOOLS, SUPPLIES, AND

15. CONTINUOUS ACCESS SHALL BE MAINTAINED FOR THE SURROUNDING PROPERTIES AT ALL TIMES DURING DEMOLITION OF THE EXISTING FACILITIES.

16. PERMITTING: IT IS THE CONTRACTOR'S RESPONSIBILITY TO OBTAIN ANY REQUIRED PERMITTING FOR DEMOLITION FROM RESPONSIBLE REGULATIONS AND FULLY ACKNOWLEDGE AND COMPLY WITH ALL REQUIREMENTS PRIOR TO COMMENCING DEMOLITION WORK.

17. IT IS THE CONTRACTOR'S SOLE RESPONSIBILITY TO DETERMINE THE EXTENT OF DEMOLITION REQUIRED IN ORDER TO PERFORM THE CONTRACT WORK FOR THIS PROJECT. THE CONTRACTOR SHALL CONDUCT SITE VISITS AND SHALL EXAMINE ALL OF THE INFORMATION WITHIN THESE DOCUMENTS: ALL DISCREPANCIES AND/OR OMISSIONS SHALL BE BROUGHT TO THE ATTENTION OF THE ENGINEER PRIOR TO BID


18. PRIOR TO DEMOLITION OCCURRING, ALL EROSION CONTROL DEVICES ARE TO BE


19. THE CONTRACTOR SHALL COORDINATE WITH OWNER PRIOR TO COMMENCEMENT OF ANY WORK. ACTUAL REMOVAL AND/OR RELOCATION OF ALL EXISTING PLANTS IS TO SITEWORK CONTRACTOR TO COORDINATE DEMOLITION ACTIVITIES WITH THE LANDSCAPE CONTRACTOR. THE CONTRACTOR IS RESPONSIBLE FOR REMOVING AND PRESERVING TREES AS INDICATED BY THE OWNER.


20. CONTRACTOR SHALL LIMIT ALL DEMOLITION ACTIVITY TO THAT AREA DELINEATED IN THE DRAWING, ALL OTHER EXIST. UTILITIES INCLUDING: STORM DRAINAGE, GAS, ELECTRIC, TELEPHONE, AND WATER & SEWER SHALL BE PRESERVED & PROTECTED.


21. A SEPARATE DEMOLITION PERMIT IS REQUIRED FOR THE DEMOLITION OF THE



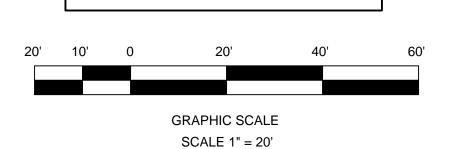

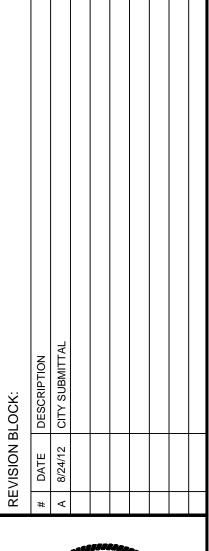

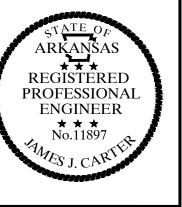

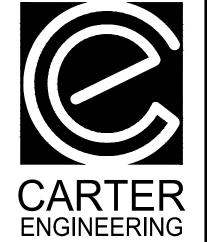

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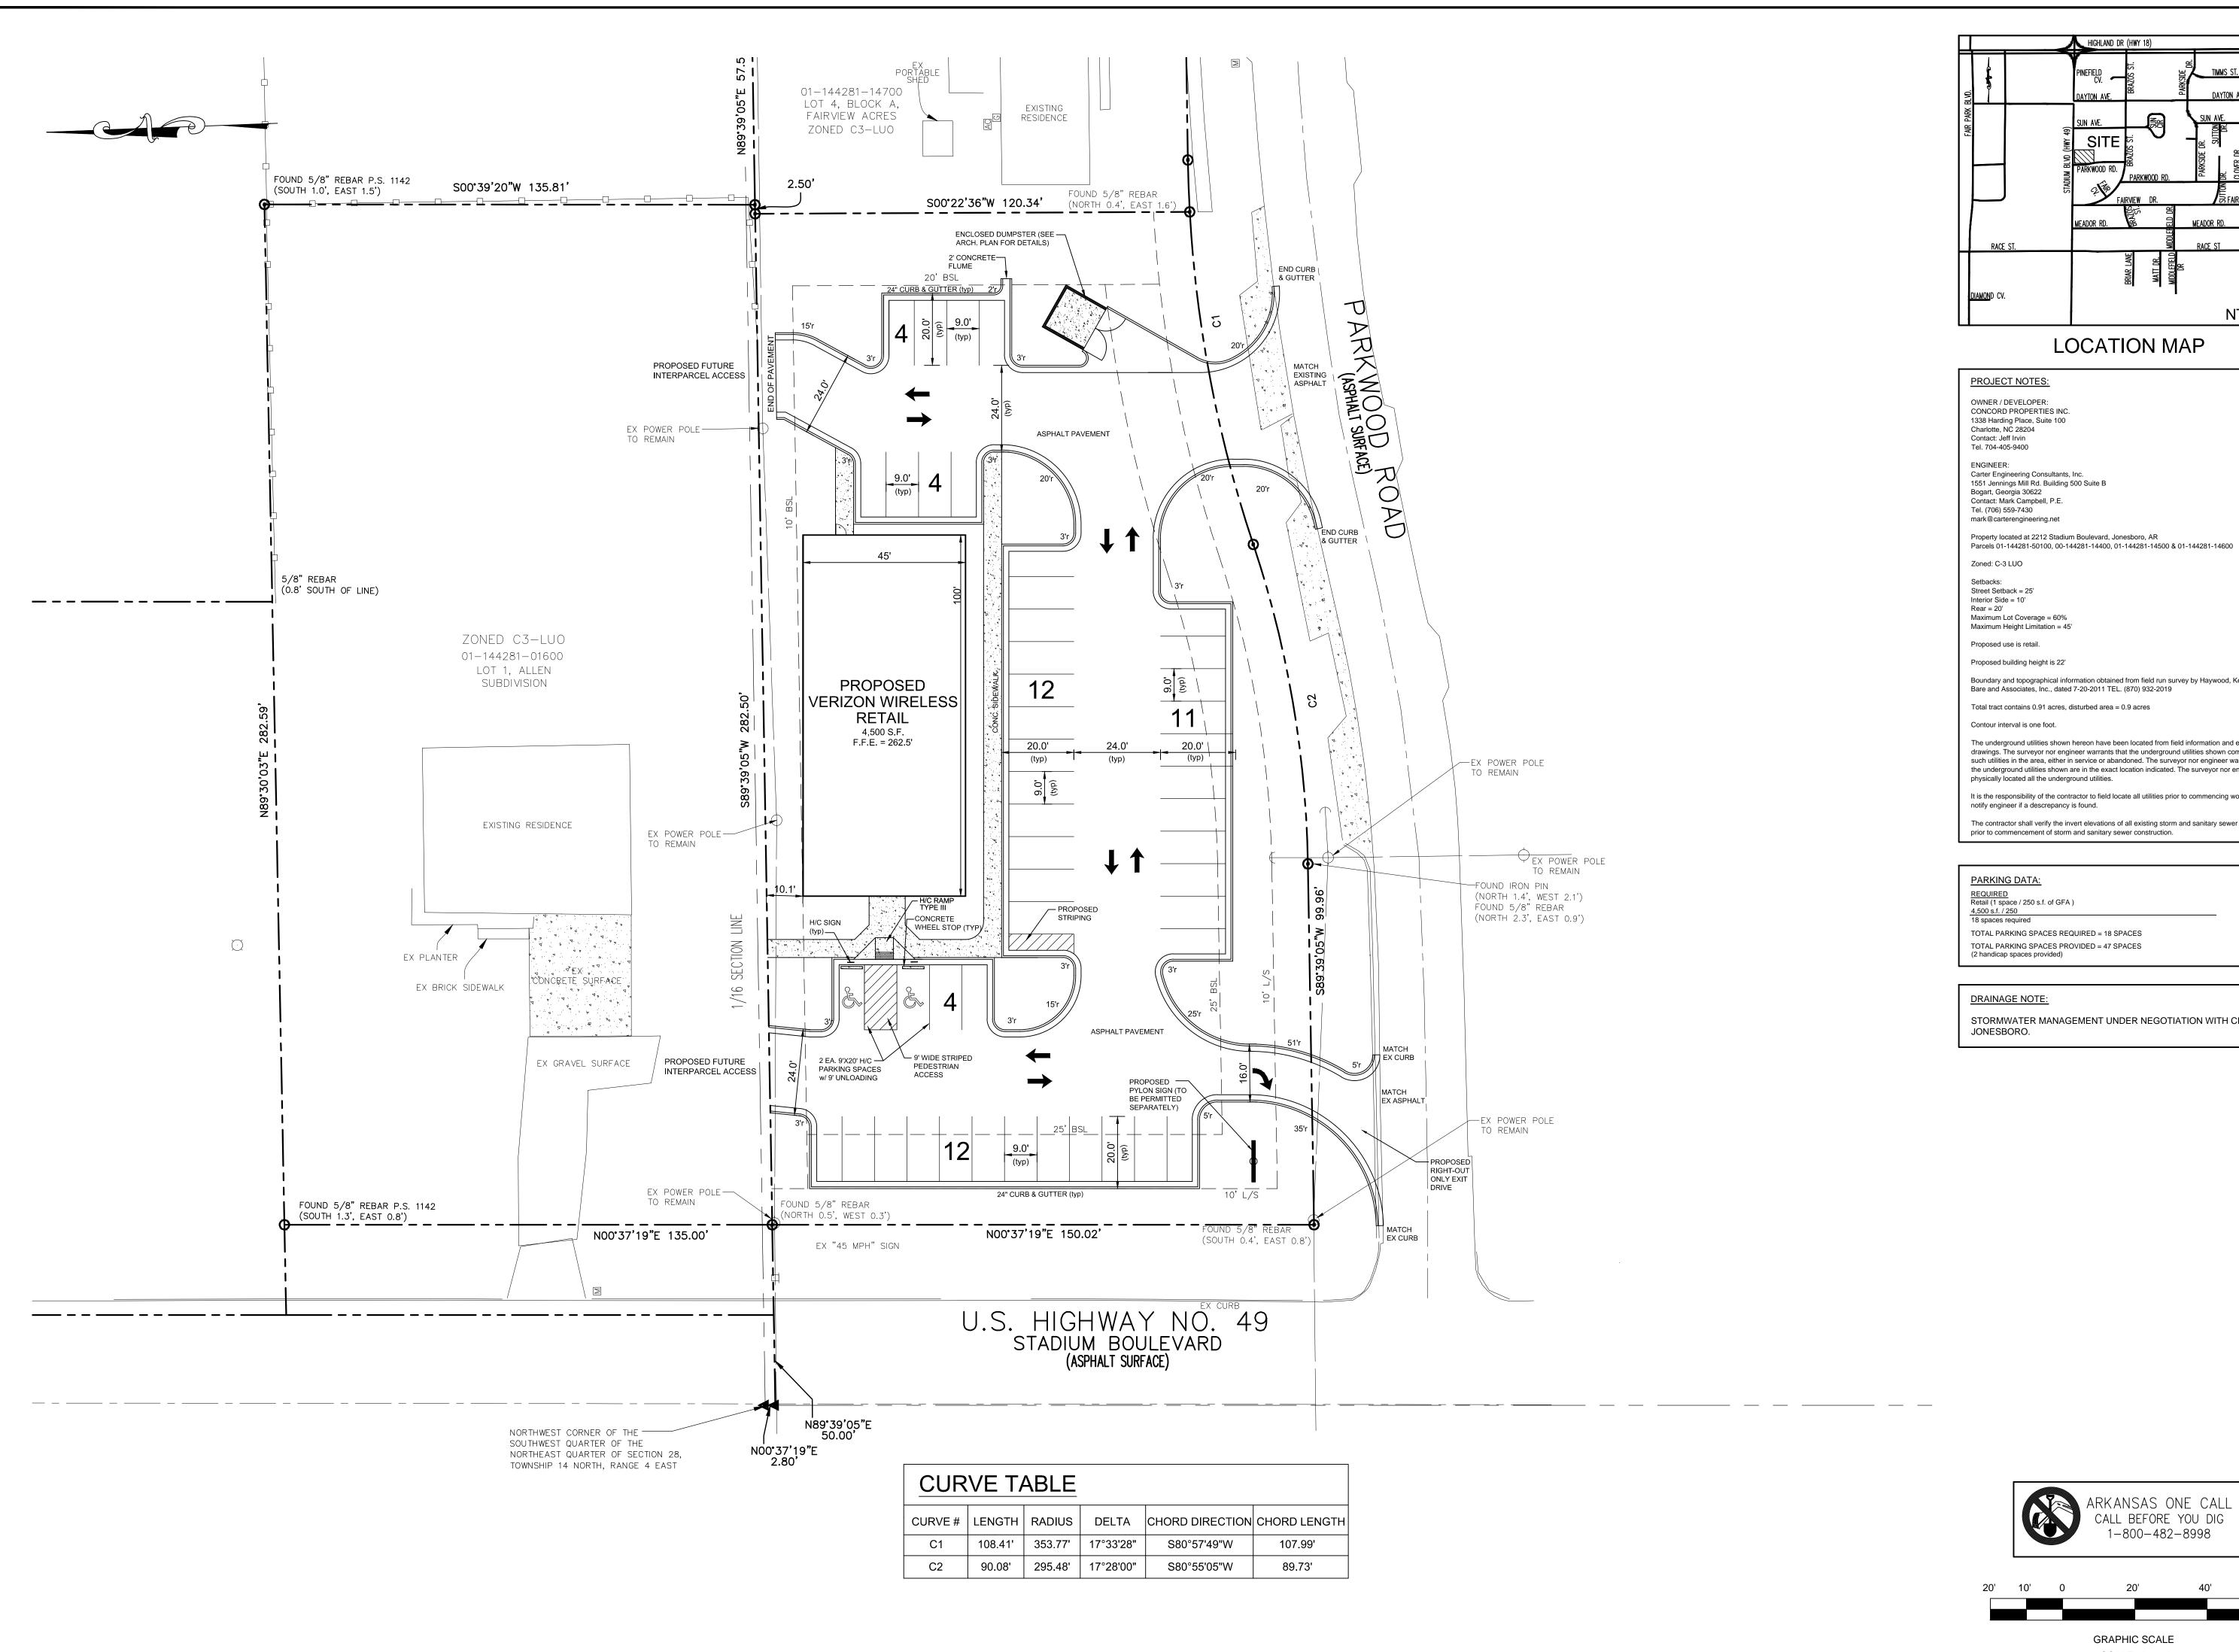
S RTIE **D OPMENT** PE PRO CONCORD
PARKWOOD ROAD STA SITE


PROJECT NAME: CONCORD

PROPERTIES EXISTING CONDITIONS &

DEMOLITION PLAN SHEET NUMBER:

PROJECT NUMBER: 12010CPI



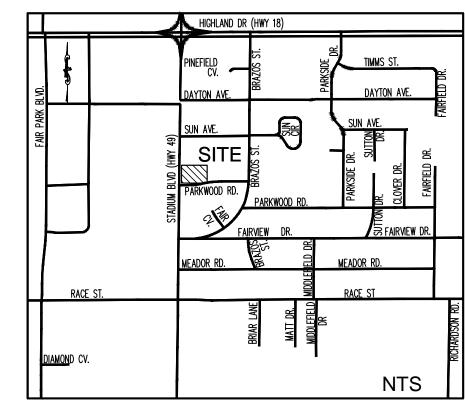

1551 Jennings Mill Rd. Building 500 Suite B

Property located at 2212 Stadium Boulevard, Jonesboro, AR

Boundary and topographical information obtained from field run survey by Haywood, Kenward,

The underground utilities shown hereon have been located from field information and existing drawings. The surveyor nor engineer warrants that the underground utilities shown comprise all such utilities in the area, either in service or abandoned. The surveyor nor engineer warrants that the underground utilities shown are in the exact location indicated. The surveyor nor engineer has

It is the responsibility of the contractor to field locate all utilities prior to commencing work and


The contractor shall verify the invert elevations of all existing storm and sanitary sewer structures prior to commencement of storm and sanitary sewer construction.

TOTAL PARKING SPACES REQUIRED = 18 SPACES

TOTAL PARKING SPACES PROVIDED = 47 SPACES

STORMWATER MANAGEMENT UNDER NEGOTIATION WITH CITY OF

SCALE 1" = 20'

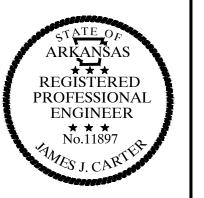



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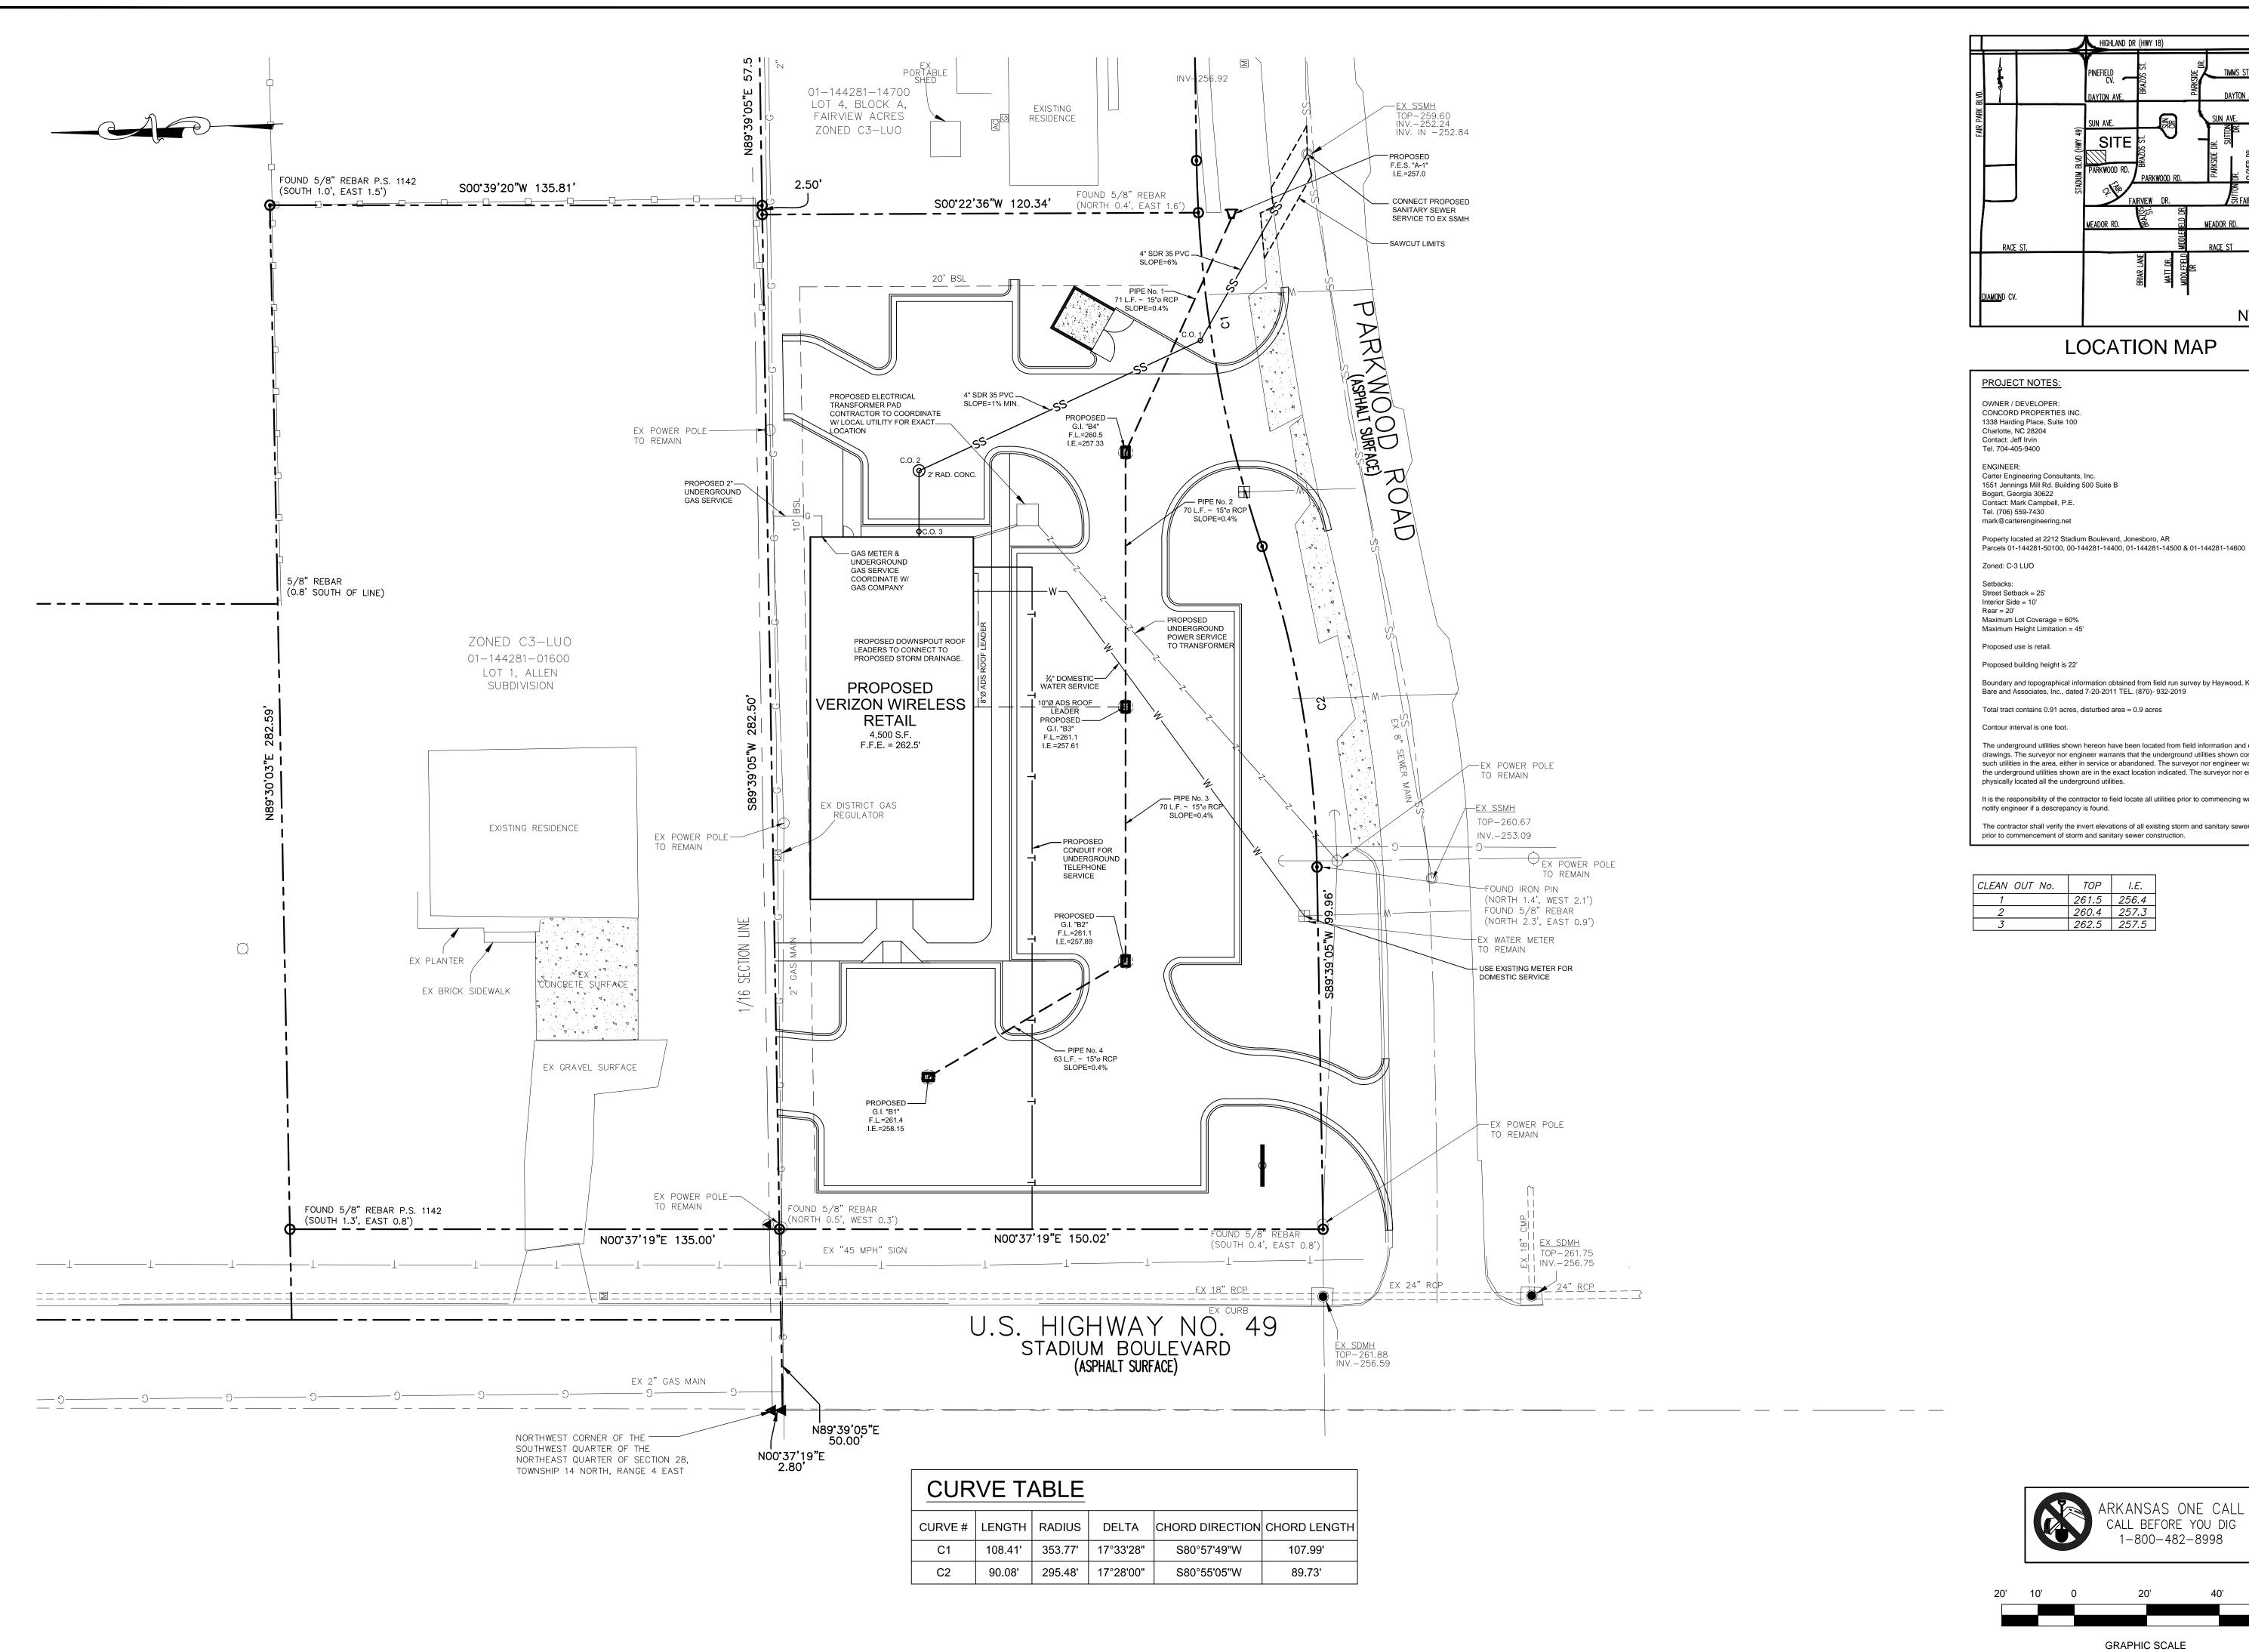
PLANS PROPERTIES OPMENT **DEVEL**(CONCORD
PARKWOOD ROAD AND STA SITE




PROPERTIES SHEET TITLE:

SHEET NUMBER:

PROJECT NUMBER: 12010CPI



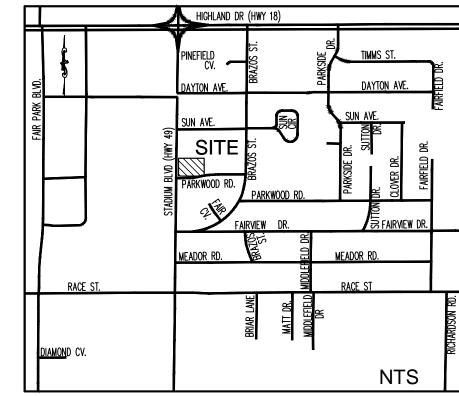

1551 Jennings Mill Rd. Building 500 Suite B

Property located at 2212 Stadium Boulevard, Jonesboro, AR Parcels 01-144281-50100, 00-144281-14400, 01-144281-14500 & 01-144281-14600

Boundary and topographical information obtained from field run survey by Haywood, Kenward, Bare and Associates, Inc., dated 7-20-2011 TEL. (870)- 932-2019

Total tract contains 0.91 acres, disturbed area = 0.9 acres

The underground utilities shown hereon have been located from field information and existing drawings. The surveyor nor engineer warrants that the underground utilities shown comprise all such utilities in the area, either in service or abandoned. The surveyor nor engineer warrants that the underground utilities shown are in the exact location indicated. The surveyor nor engineer has

It is the responsibility of the contractor to field locate all utilities prior to commencing work and


SCALE 1" = 20'


The contractor shall verify the invert elevations of all existing storm and sanitary sewer structures


TOP I.E.

261.5 256.4

260.4 257.3

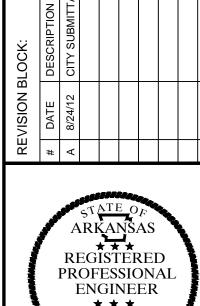

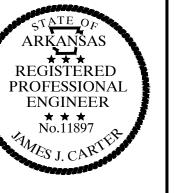

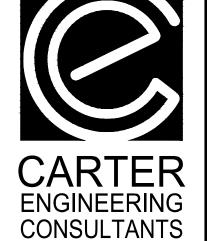

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PLANS PROPERTIES DEVELOPMENT CONCORD
PARKWOOD ROAD AND STA SITE




CONCORD **PROPERTIES** SHEET TITLE:


UTILITY **PLAN**


SHEET NUMBER:

PROJECT NUMBER: 12010CPI

DATE: 8/24/12

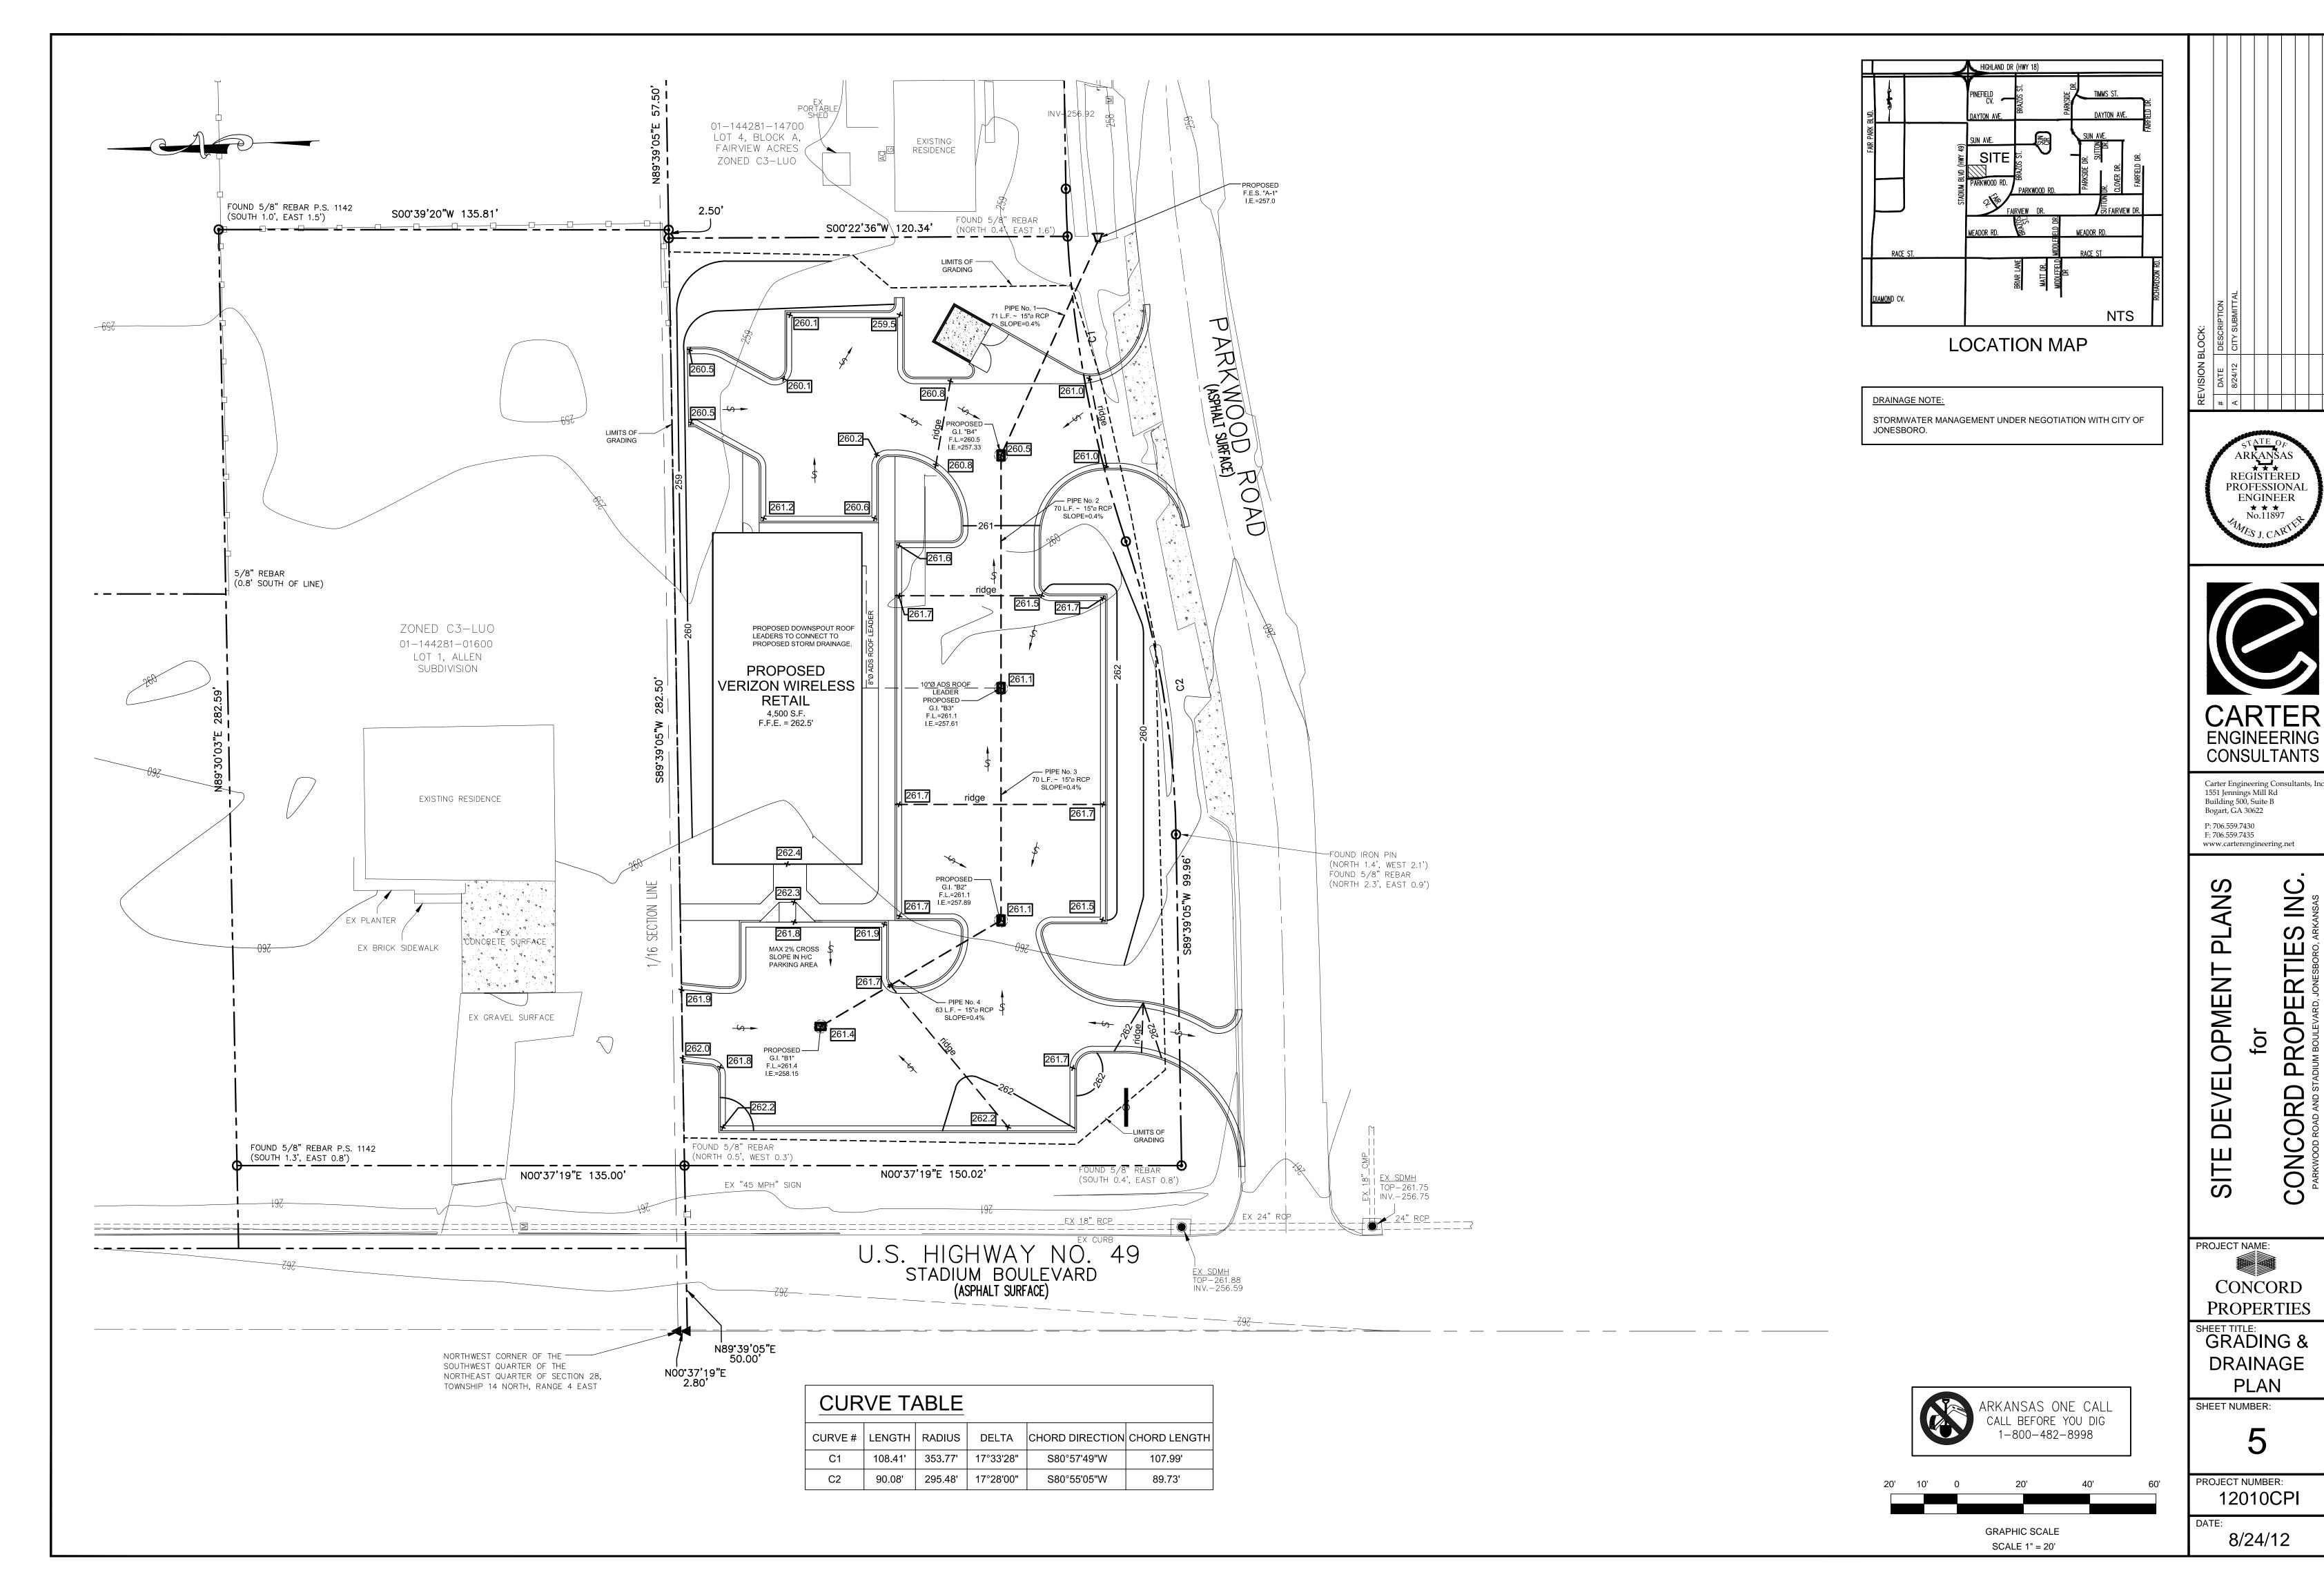

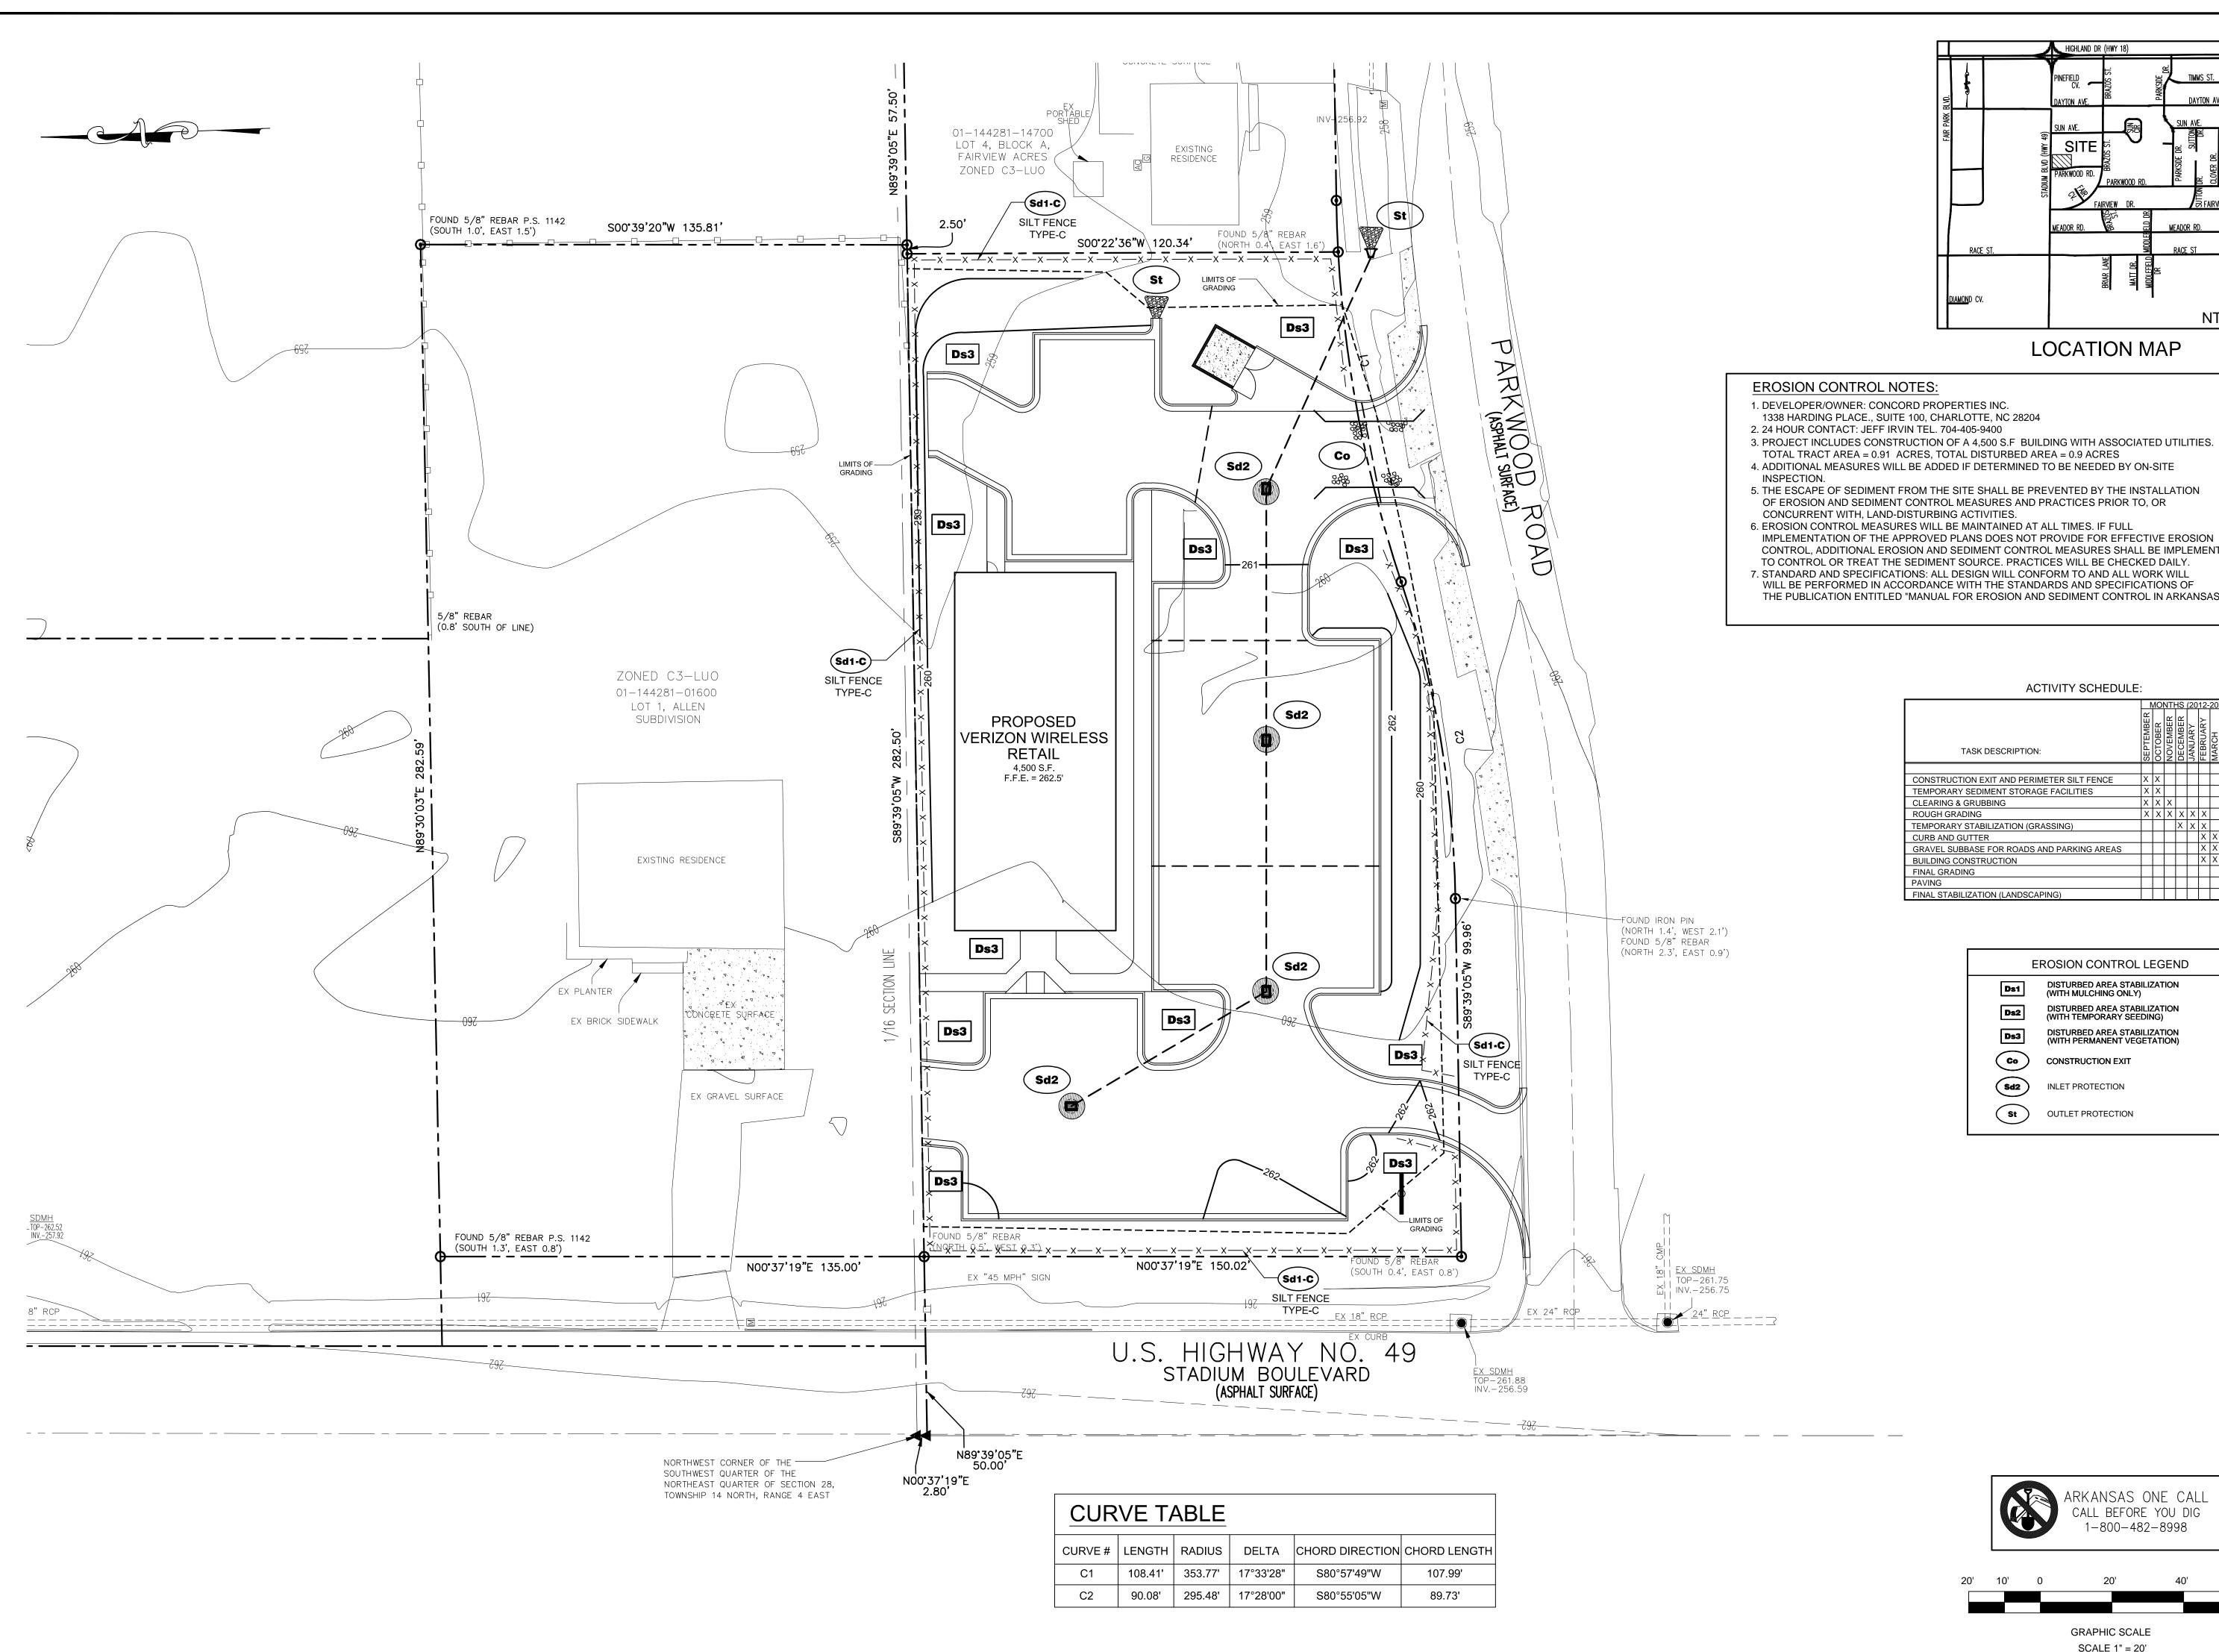

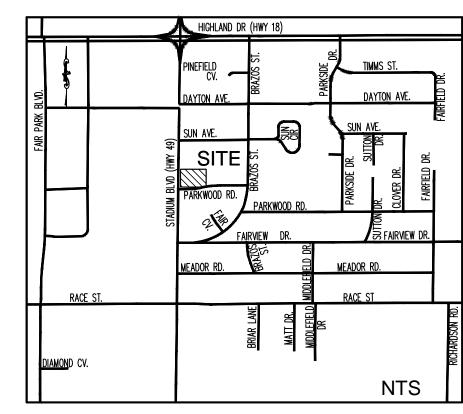

- 3. PROJECT INCLUDES CONSTRUCTION OF A 4,500 S.F. BUILDING WITH ASSOCIATED UTILITIES.
- 4. ADDITIONAL MEASURES WILL BE ADDED IF DETERMINED TO BE NEEDED BY ON-SITE
- 5. THE ESCAPE OF SEDIMENT FROM THE SITE SHALL BE PREVENTED BY THE INSTALLATION
- OF EROSION AND SEDIMENT CONTROL MEASURES AND PRACTICES PRIOR TO, OR
- CONTROL, ADDITIONAL EROSION AND SEDIMENT CONTROL MEASURES SHALL BE IMPLEMENTED TO CONTROL OR TREAT THE SEDIMENT SOURCE. PRACTICES WILL BE CHECKED DAILY.
- 7. STANDARD AND SPECIFICATIONS: ALL DESIGN WILL CONFORM TO AND ALL WORK WILL WILL BE PERFORMED IN ACCORDANCE WITH THE STANDARDS AND SPECIFICATIONS OF THE PUBLICATION ENTITLED "MANUAL FOR EROSION AND SEDIMENT CONTROL IN ARKANSAS."

ACTIVITY SCHEDULE:

	1	MONTHS (20						012-2013)				
TASK DESCRIPTION:	SEPTEMBER	OCTOBER	NOVEMBER	DECEMBER	JANUARY	FEBRUARY	MARCH	APRIL	~~~			
									Т			
CONSTRUCTION EXIT AND PERIMETER SILT FENCE	X	Х							Γ			
TEMPORARY SEDIMENT STORAGE FACILITIES	X	Х							T			
CLEARING & GRUBBING	X	Х	Х						T			
ROUGH GRADING		Х	Х	Х	Х	Х			Τ			
TEMPORARY STABILIZATION (GRASSING)				Х	Х	Х			T			
CURB AND GUTTER						Х	Х		T			
GRAVEL SUBBASE FOR ROADS AND PARKING AREAS						Х	Х		T			
BUILDING CONSTRUCTION						Х	Х	Х				
FINAL GRADING								Х				
PAVING								Х	Ī			
FINAL STABILIZATION (LANDSCAPING)								Х				

EROSION CONTROL LEGEND

DISTURBED AREA STABILIZATION (WITH MULCHING ONLY)


DISTURBED AREA STABILIZATION (WITH TEMPORARY SEEDING)

DISTURBED AREA STABILIZATION (WITH PERMANENT VEGETATION)


INLET PROTECTION

OUTLET PROTECTION



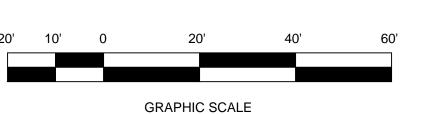

GRAPHIC SCALE SCALE 1" = 20'

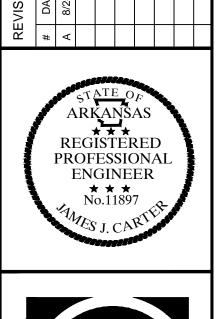



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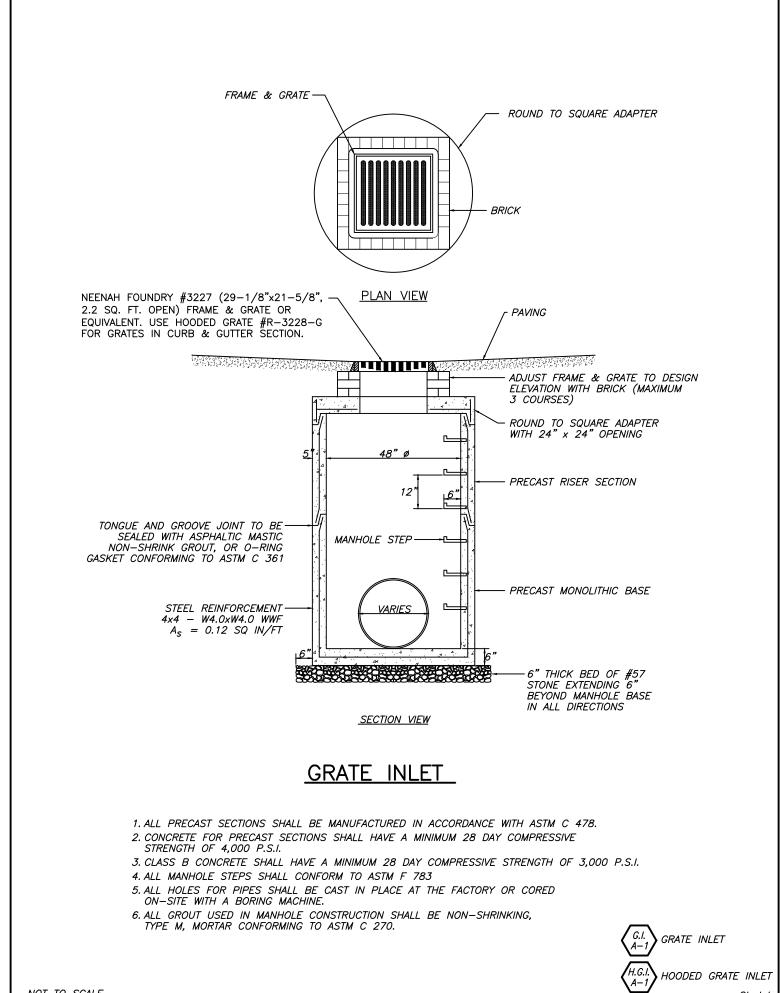
PLANS PROPERTIES INC DEVELOPMENT SITE


PROJECT NAME: CONCORD **PROPERTIES**


EROSION CONTROL


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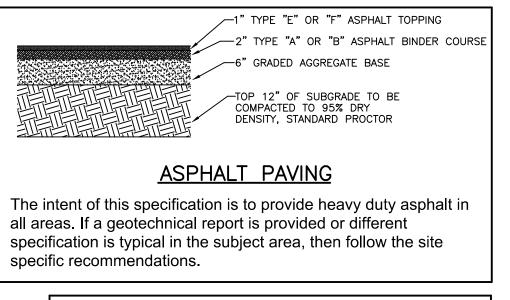
PROJECT NUMBER: 12010CPI






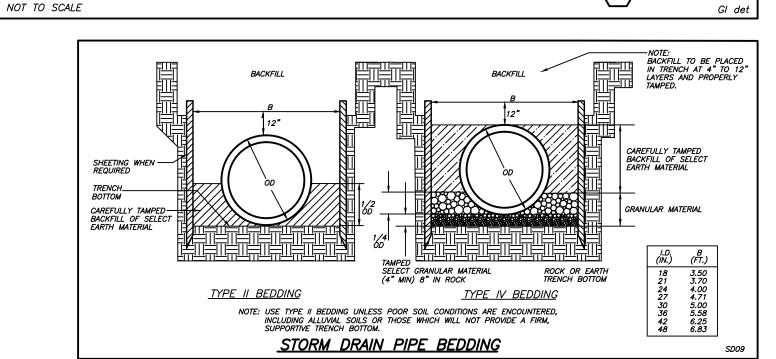

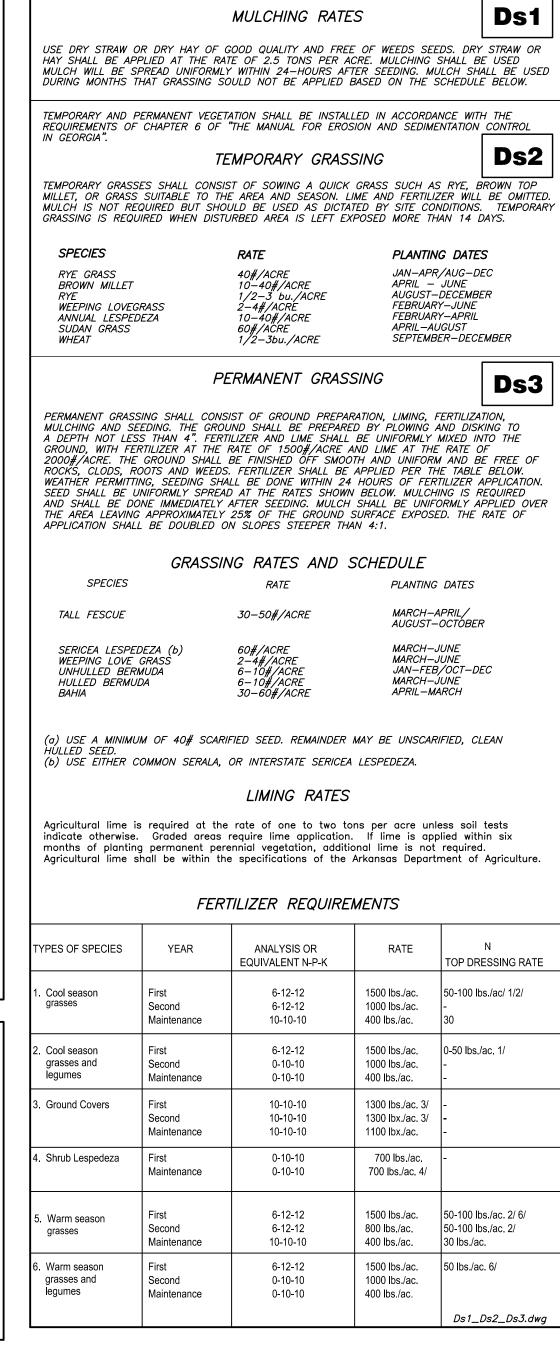

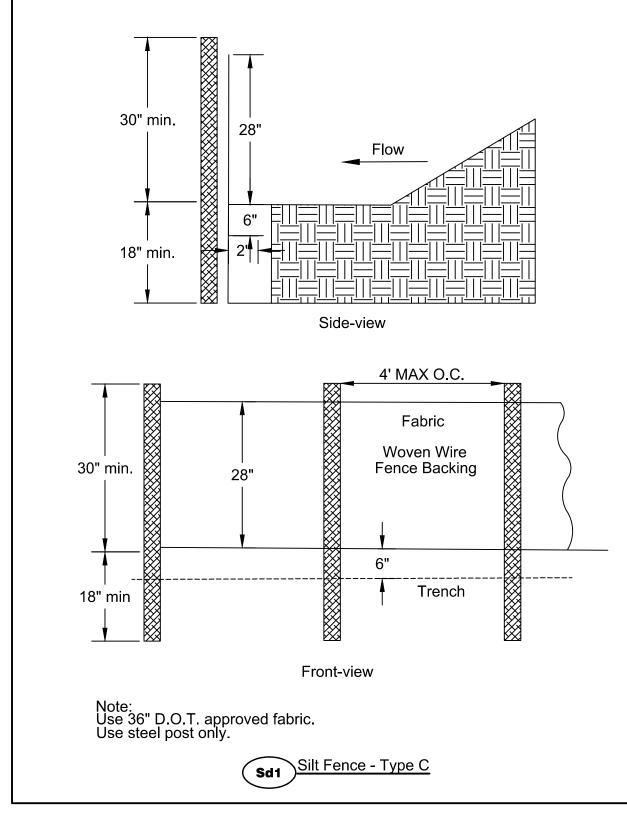

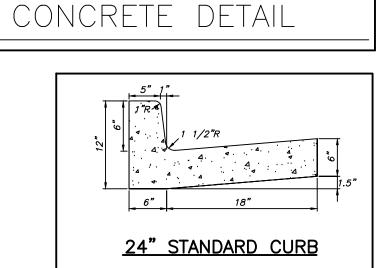

FIBER MESH

— 6" – 3000 PSI CONCRETE WITH

- TOP 12" OF SUBGRADE TO BE COMPACTED TO 95% DRY DENSITY, STANDARD PROCTOR


24" STANDARD CURB


6" × 24" × 12"


3000 P.S.I. CONC. © 28 DAYS


1/2" EXPANSION JOINT MATERIAL SHALL BE PROVIDED AT ALL
STRUCTURES AND RADIUS POINTS & AT INTERVALS NOT TO
EXCEED 250' IN THE REMAINDER OF THE CURB & GUTTER.


PC08

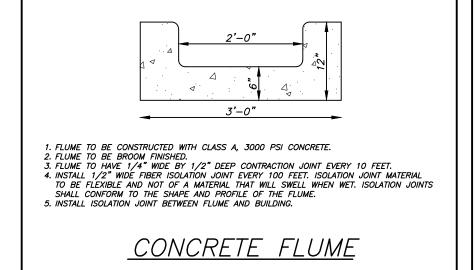


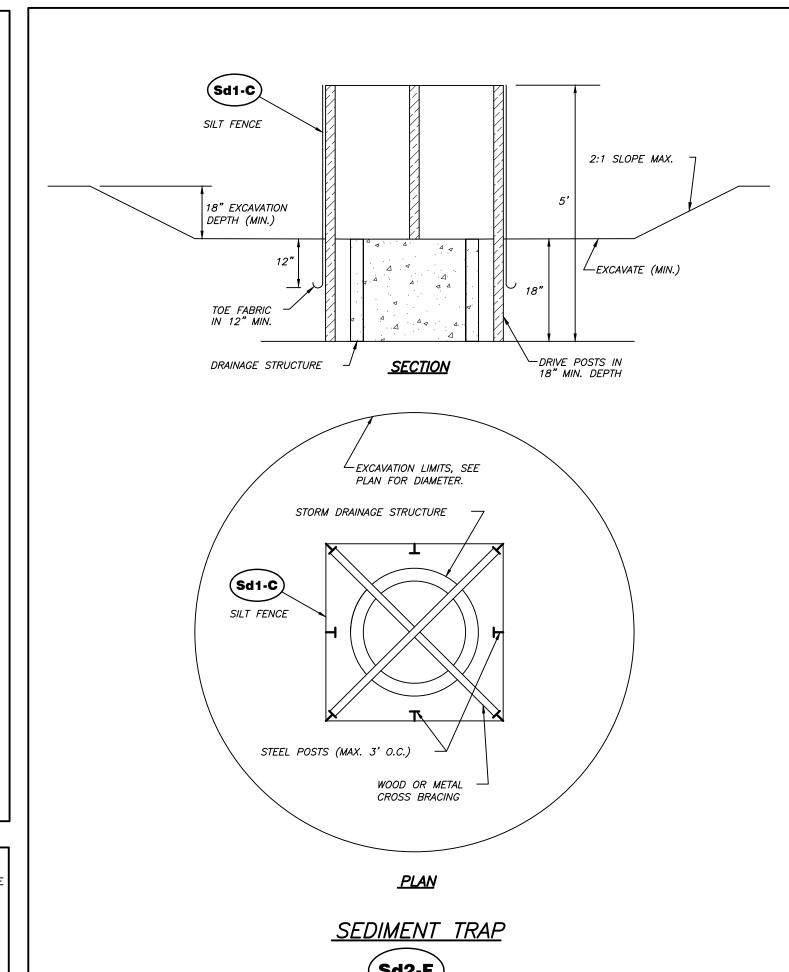

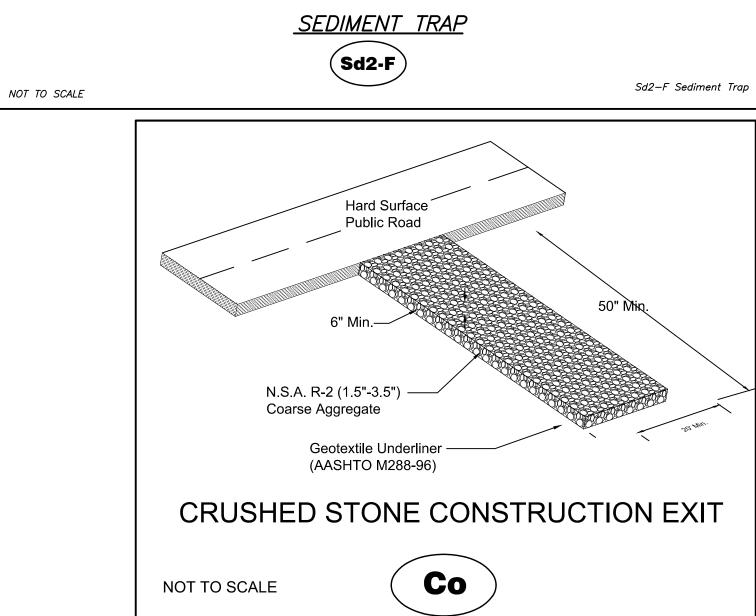

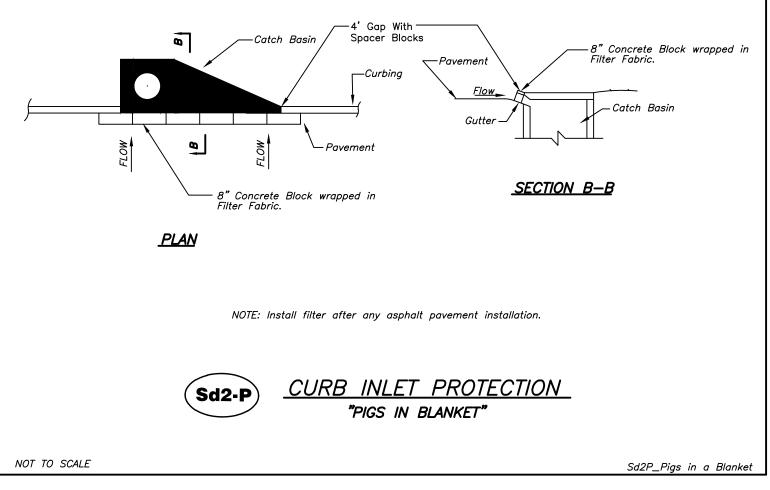

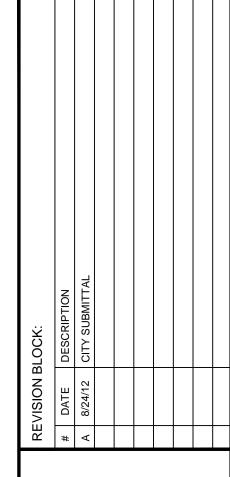

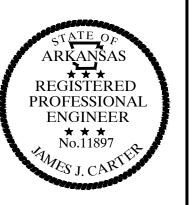



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SITE DEVELOPMENT PLANS

for

CONCORD PROPERTIES INC.

PROJECT NAME:

CONCORD

PROPERTIES

SHEET TITLE:


STANDARD


DETAILS


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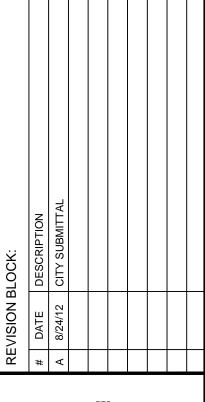
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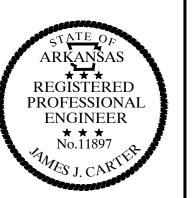
PROJECT NUMBER: 12010CPI





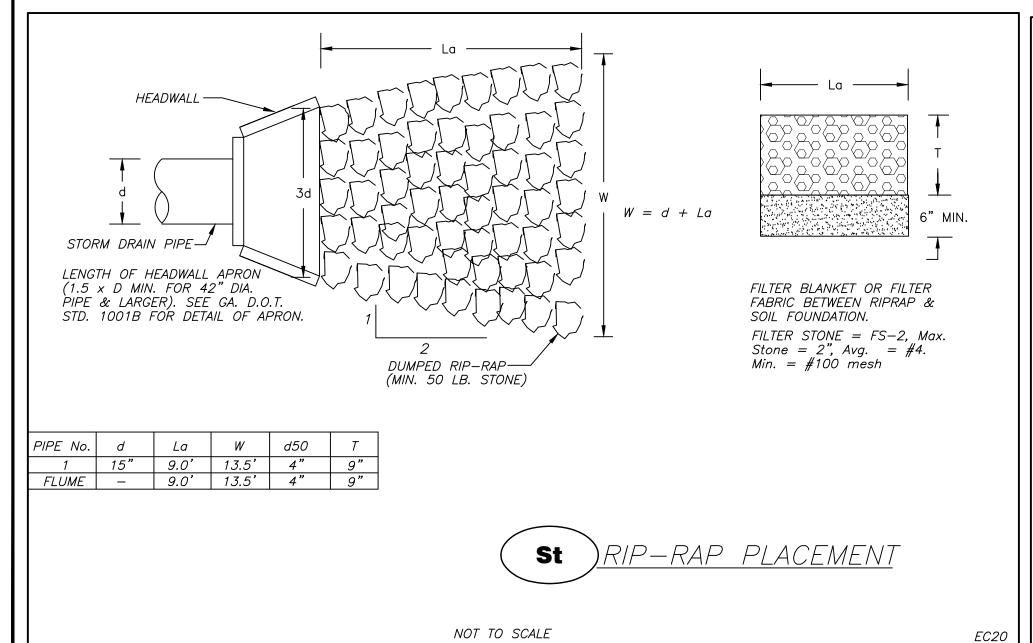

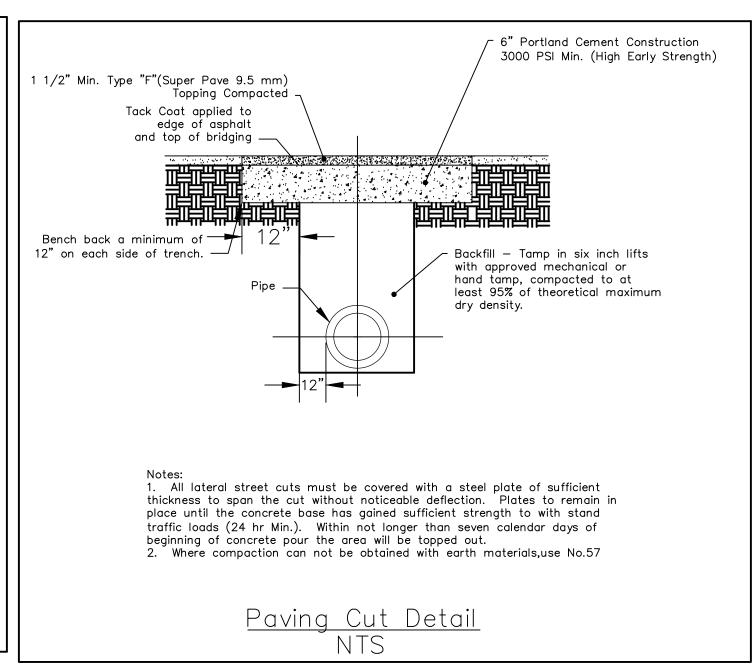

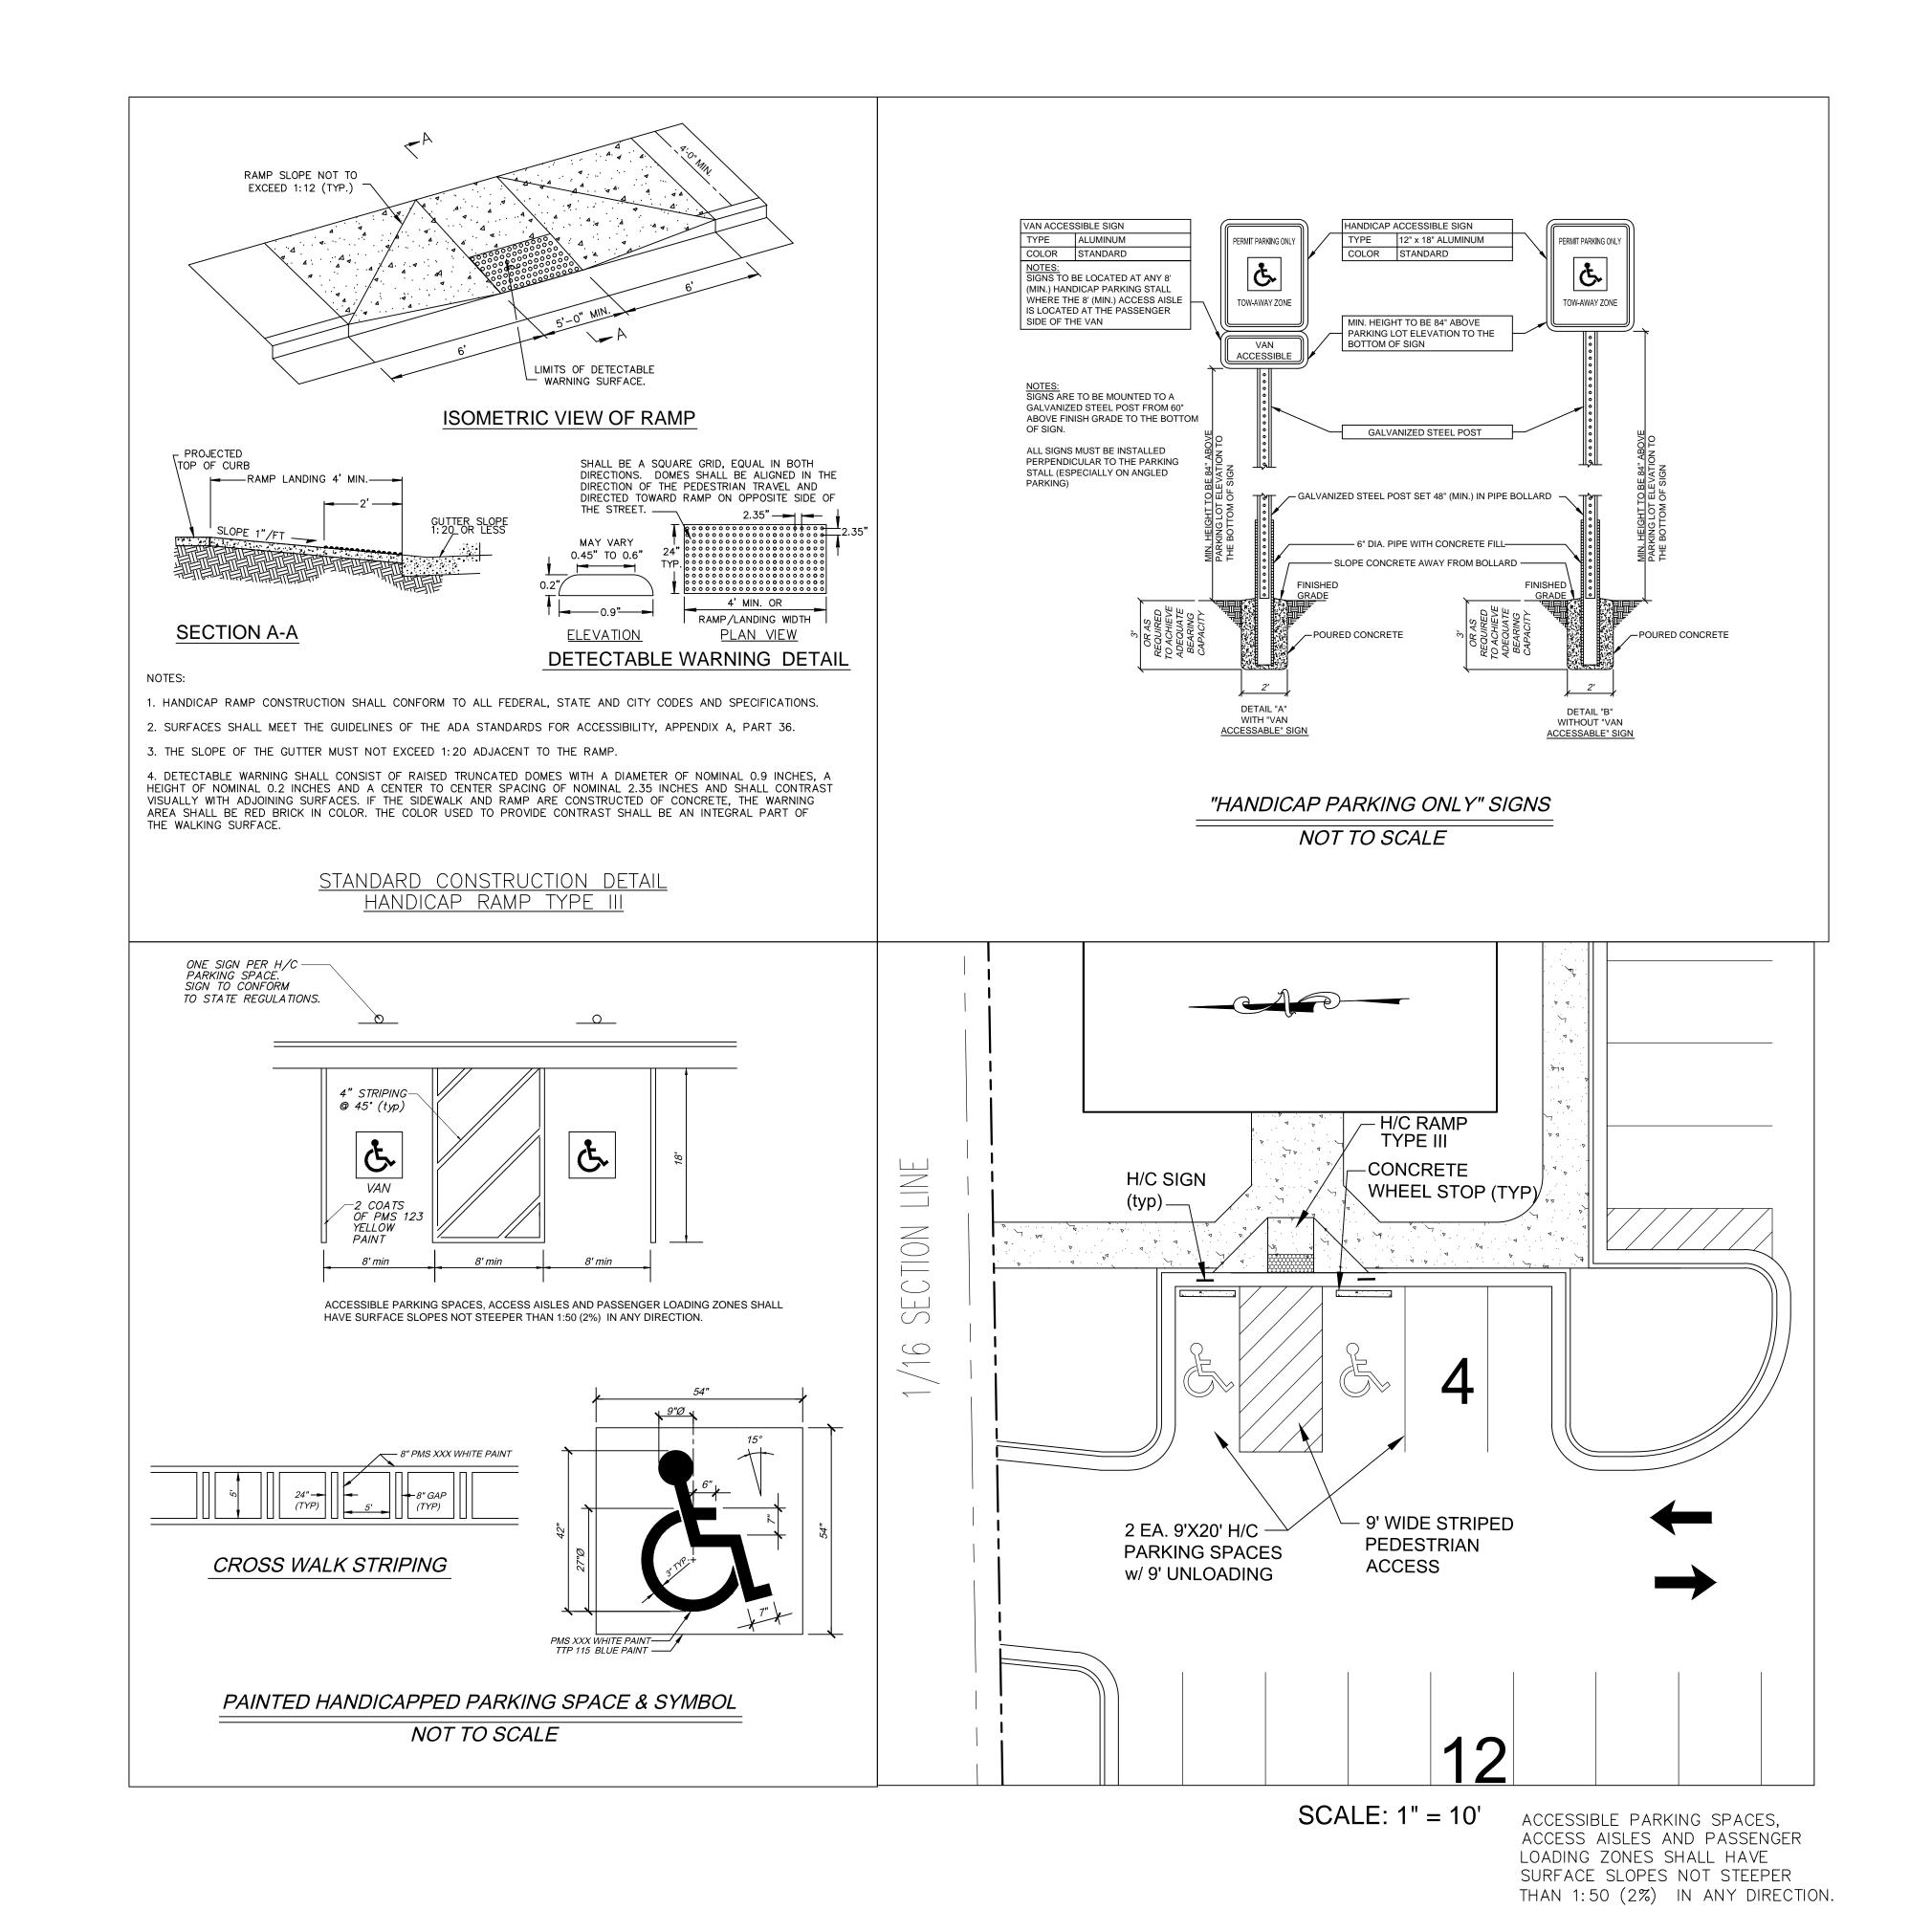



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> **PLANS** PROPERTIES DEVELOPMENT CONCORD
> PARKWOOD ROAD STA SITE




PROPERTIES


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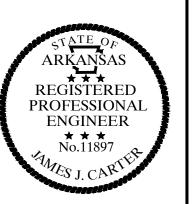
ADA ACCESS PLAN

SHEET NUMBER:

PROJECT NUMBER: 12010CPI



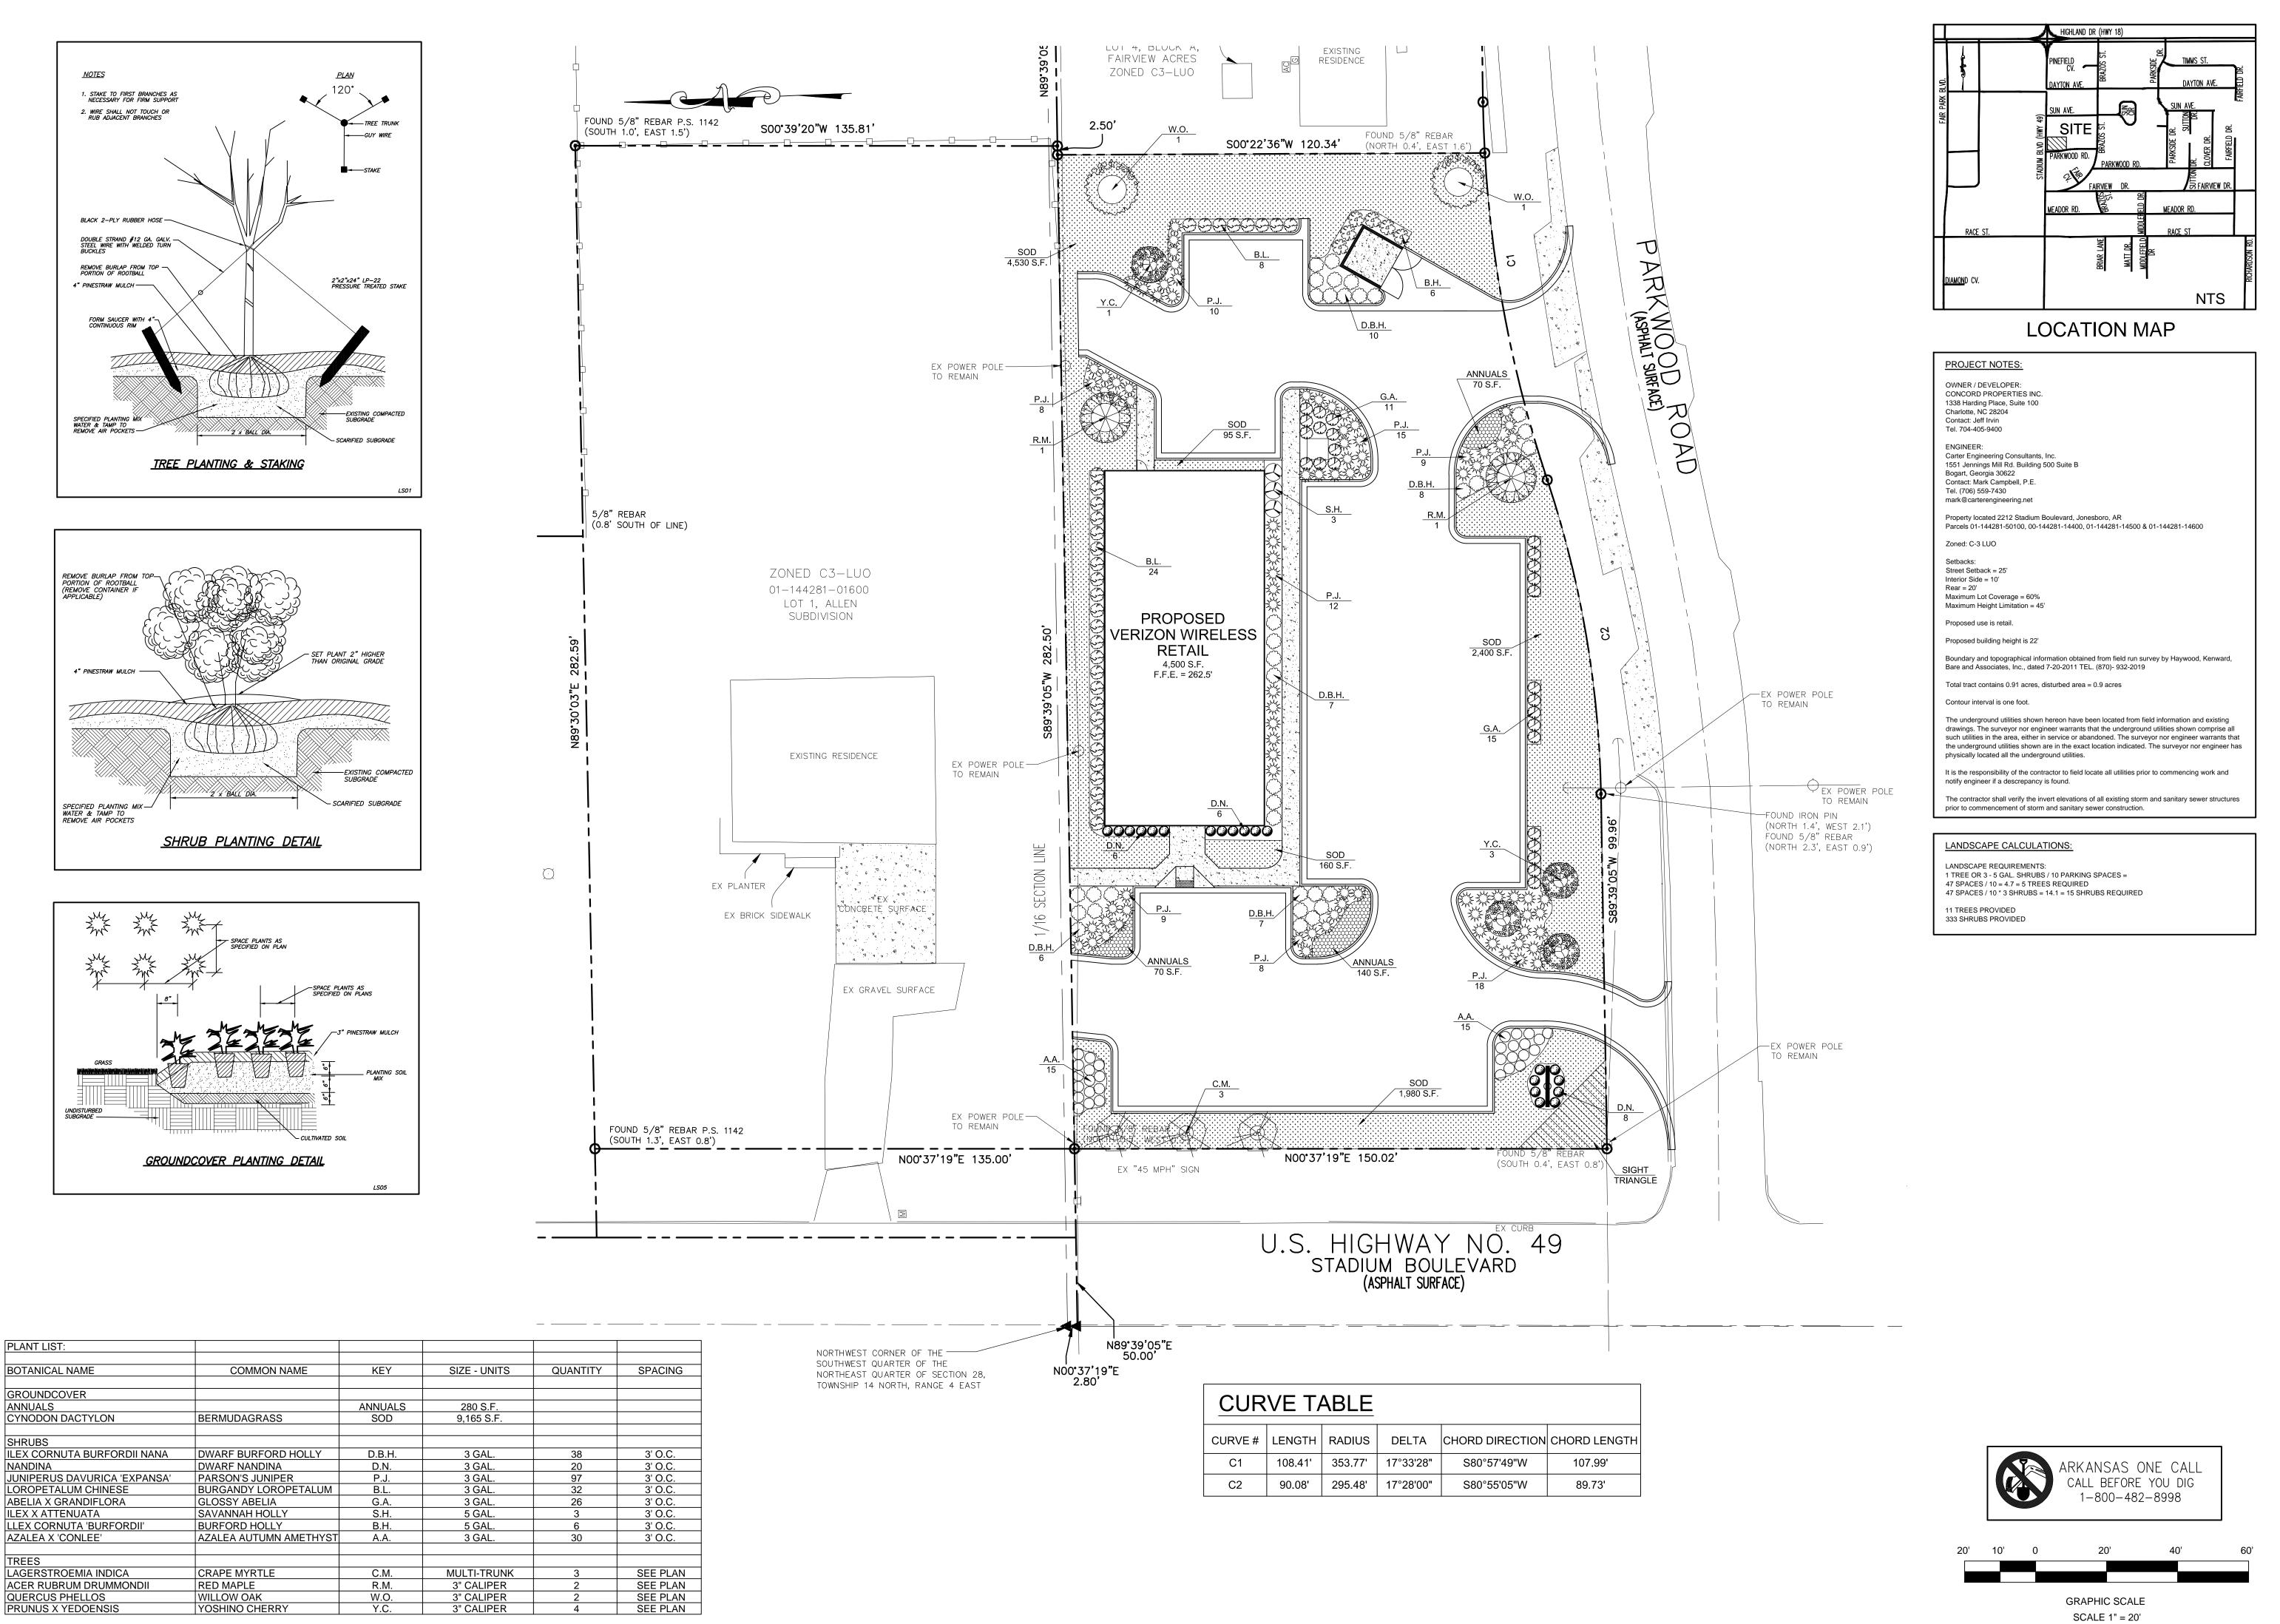

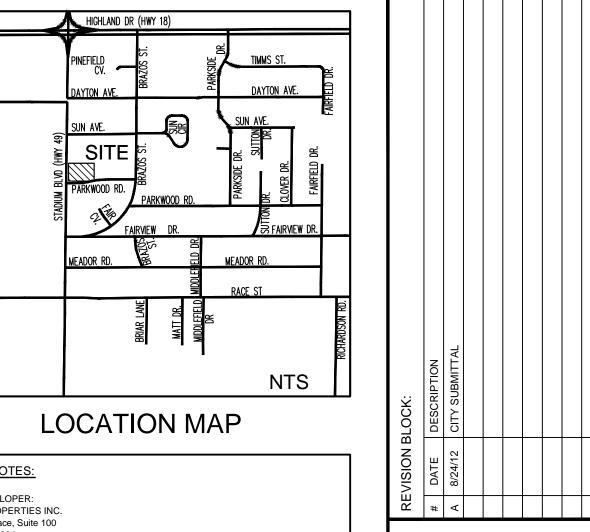




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ANS PROPERTIES AND THE STATE OF THE 7 OPMENT DEVEL CONCORD
PARKWOOD ROAD AND STA SITE



PROPERTIES

SHEET TITLE:

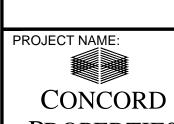LANDSCAPE **PLAN**

SHEET NUMBER:

PROJECT NUMBER: 12010CPI