
SUBDIVISION PLANS

THE VILLAS AT SAGE PHASEII

PREPARED FOR TRI-STATE DEVELOPMENT, LLC.

> JONESBORO, ARKANSAS OCTOBER, 2007

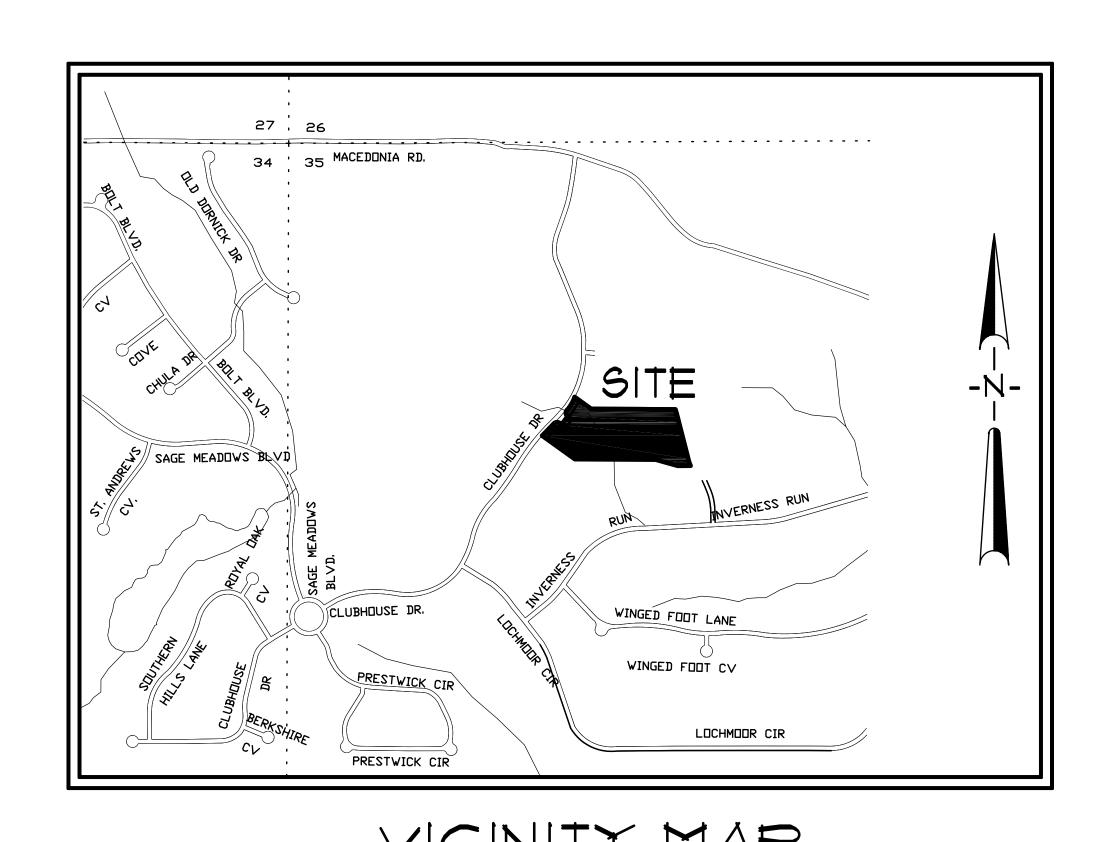

1 OF 10 INDEX SHEET

INDEX TO SHEETS

2 OF 10 GENERAL NOTES & AREA MAP

3 OF 10 TOPOGRAPHIC SURVEY

4 OF 10 RECORD PLAT

5 OF 10 SITE UTILITIES LAYOUT

6 OF 10 GRADING & DRAINAGE LAYOUT

7 OF 10 EROSION CONTROL LAYOUT 8 OF 10 ROADWAY PLAN & PROFILE

9 OF 10 DETAILS-STANDARD

10 OF 10 DETAILS-EROSION CONTROL



ASSOCIATED ENGINEERING AND TESTING, LLC CIVIL ENGINEERING, LAND SURVEYING AND MATERIALS TESTING 103 SOUTH CHURCH STREET - P.O. BOX 1462 - JONESBORO, AR 72403 PH: 870-932-3594 FAX: 870-935-1263

> PRELIMINARY SUBDIVISION PLANS THE YILLAS AT SAGE - PHASE JONESBORO, ARKANSAS

								•		
				DRAWN:	CADD	CHECKED:	JME	DATE:	10/30/07	SHEET
© Copyright 2007 AETLLC	DATE	REVISIONS	BY	SCALE:	1" = 30'	CADD FILE:	07287-SUBD.	DWG#:	0415354.0029	1 OF 10



- . CITY OF JONESBORO PLANNING AND ZONING OTIS SPRIGGS, CITY PLANNER IOO FLINT STREET
- 879-932-0406

 2. <u>CITY OF JONESBORO PUBLIC WORKS</u>
 ERIC WOODRUFF
 DIRECTOR OF PUBLIC WORKS
 307 VINE AVENUE
 JONESBORO, AR 72401

JONESBORO, AR 72401

- 870-932-2438

 3. <u>CITY OF JONESBORO ENGINEERING</u>
 KELLY PANNECK, P.E.
 CITY ENGINEER
 301 VINE AVENUE
 JONESBORO, AR 12401
- 870-932-2438

 4. CODES DEPT. FIRE MARSHALL CRAIG DAVENPORT 3215 E. JOHNSON AVE. JONESBORO, AR 12401

870-932-2428

- 5. CITY WATER AND LIGHT ENGINEERING RANDY SIMPKINS - CHIEF ENGINEER 400 EAST MONROE, P.O. BOX 1289 JONESBORO, AR 12403 870-930-3320, FAX: 870-930-3303
- 6. CENTERPOINT ENERGY
 KEITH CRAIG SERVICE TECHNICIAN
 3013 OLD FEEDHOUSE ROAD
 JONESBORO, AR 12401
 CELL: 810-891-3150
- 7. AT&T

 123 CHURCH, ROOM B 27

 JONESBORO, AR 12403

 PHIL FARLEY AREA MANAGER INSTALLATION & REPAIR


 810-912-1821, FAX: 810-912-1610

 TOMMY GRAY AREA MANAGER ENGINEERING DESIGN

 810-912-1581, FAX: 810-912-1533
- 8. SUDDEN LINK CABLE TY
 1520 SOUTH CARAWAY ROAD
 JONESBORO, AR 12401
 BOB PROCK CONSTRUCTION MANAGER
 810-933-8429 EXT: 212, FAX: 810-912-8141
 DEANNA HORNBACK MANAGER
 JIMMY YANCY FIELD MANAGER
 CELL: 810-219-8583


GENERAL NOTES


- SUBJECT PROPERTY IS NOT LOCATED WITHIN "ZONE AE", 100 YR FREQUENCY FLOOD ZONE, AS DESIGNATED BY FEDERAL EMERGENCY MANAGEMENT AGENCY. FLOOD INSURANCE RATE MAP FOR CITY OF JONESBORO, COMMUNITY PANEL 0500480150C, EFFECTIVE DATE -SEPTEMBER 27, 1991
- 2. SCREENING AND BUFFERING ARE AS SHOWN.
- 3. EASEMENTS ARE AS SHOWN.
- 4. COMMON OPEN SPACE AND AMENITIES ARE NOT APPLICABLE
- 5. THERE ARE NO KNOWN HISTORICAL STRUCTURES LOCATED ON SUBJECT PROPERTY
- 6. EXISTING FIRE HYDRANT LOCATED AT INTERSECTION OF VILLA DRIVE AND CLUBHOUSE DRIVE. (LOT 22, THE VILLAS AT SAGE)

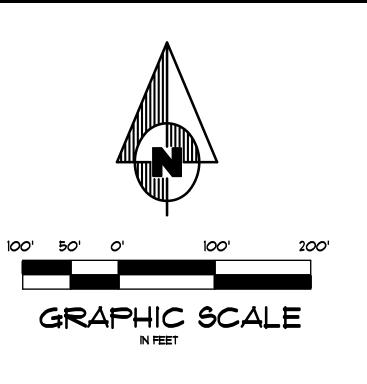



BENCHMARK LIST


- 1. ELEVATIONS SHOWN HEREON ARE IN FEET AND DECIMAL PARTS THEREOF ANS
- 2. BENCHMARK IS A C.P.S. IN THE EAST SIDE OF 36" OAK TREE LOCATED NORTHEASTERLY OF LOT 22, THE VILLAS AT SAGE. ELEV. = 342.44

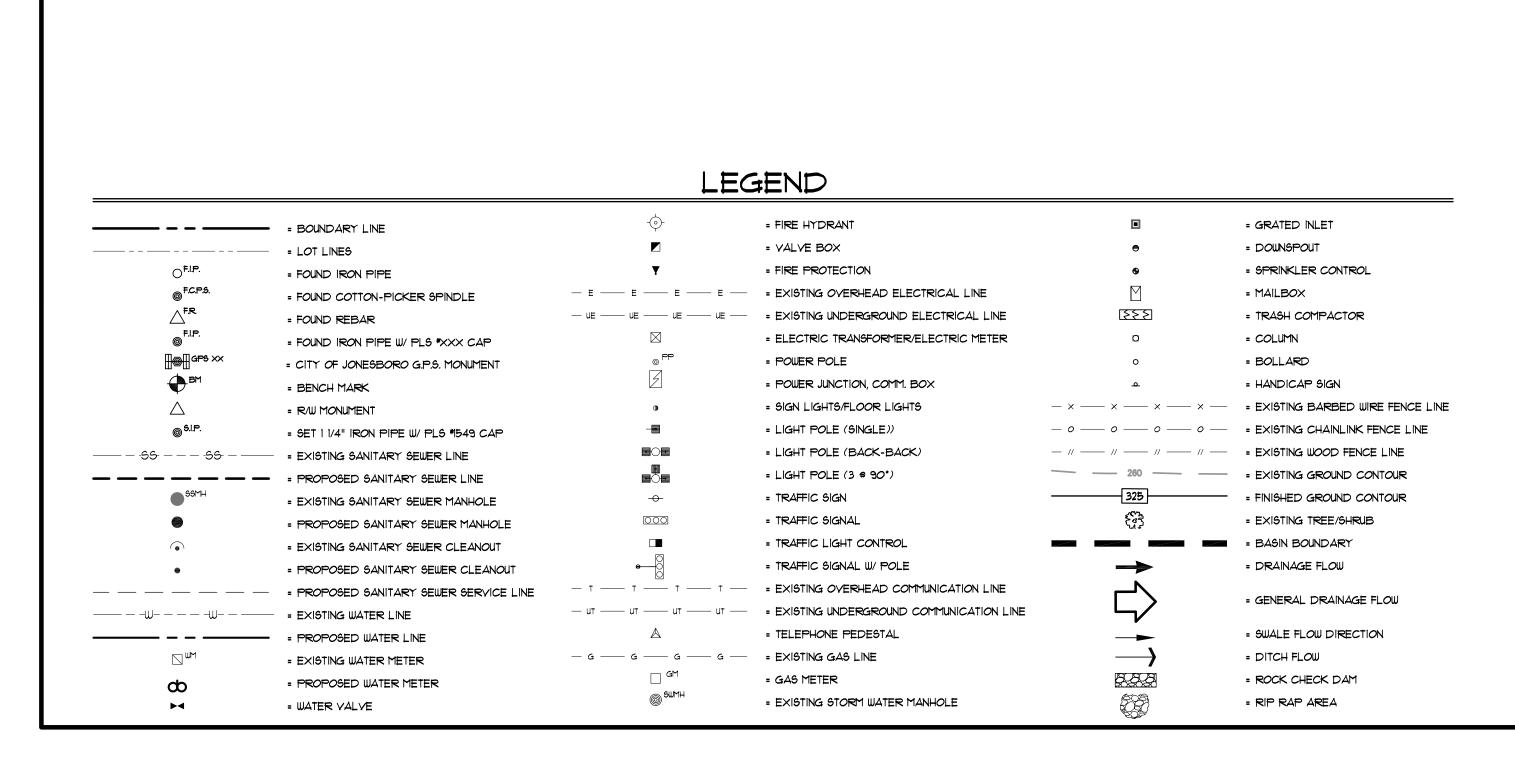


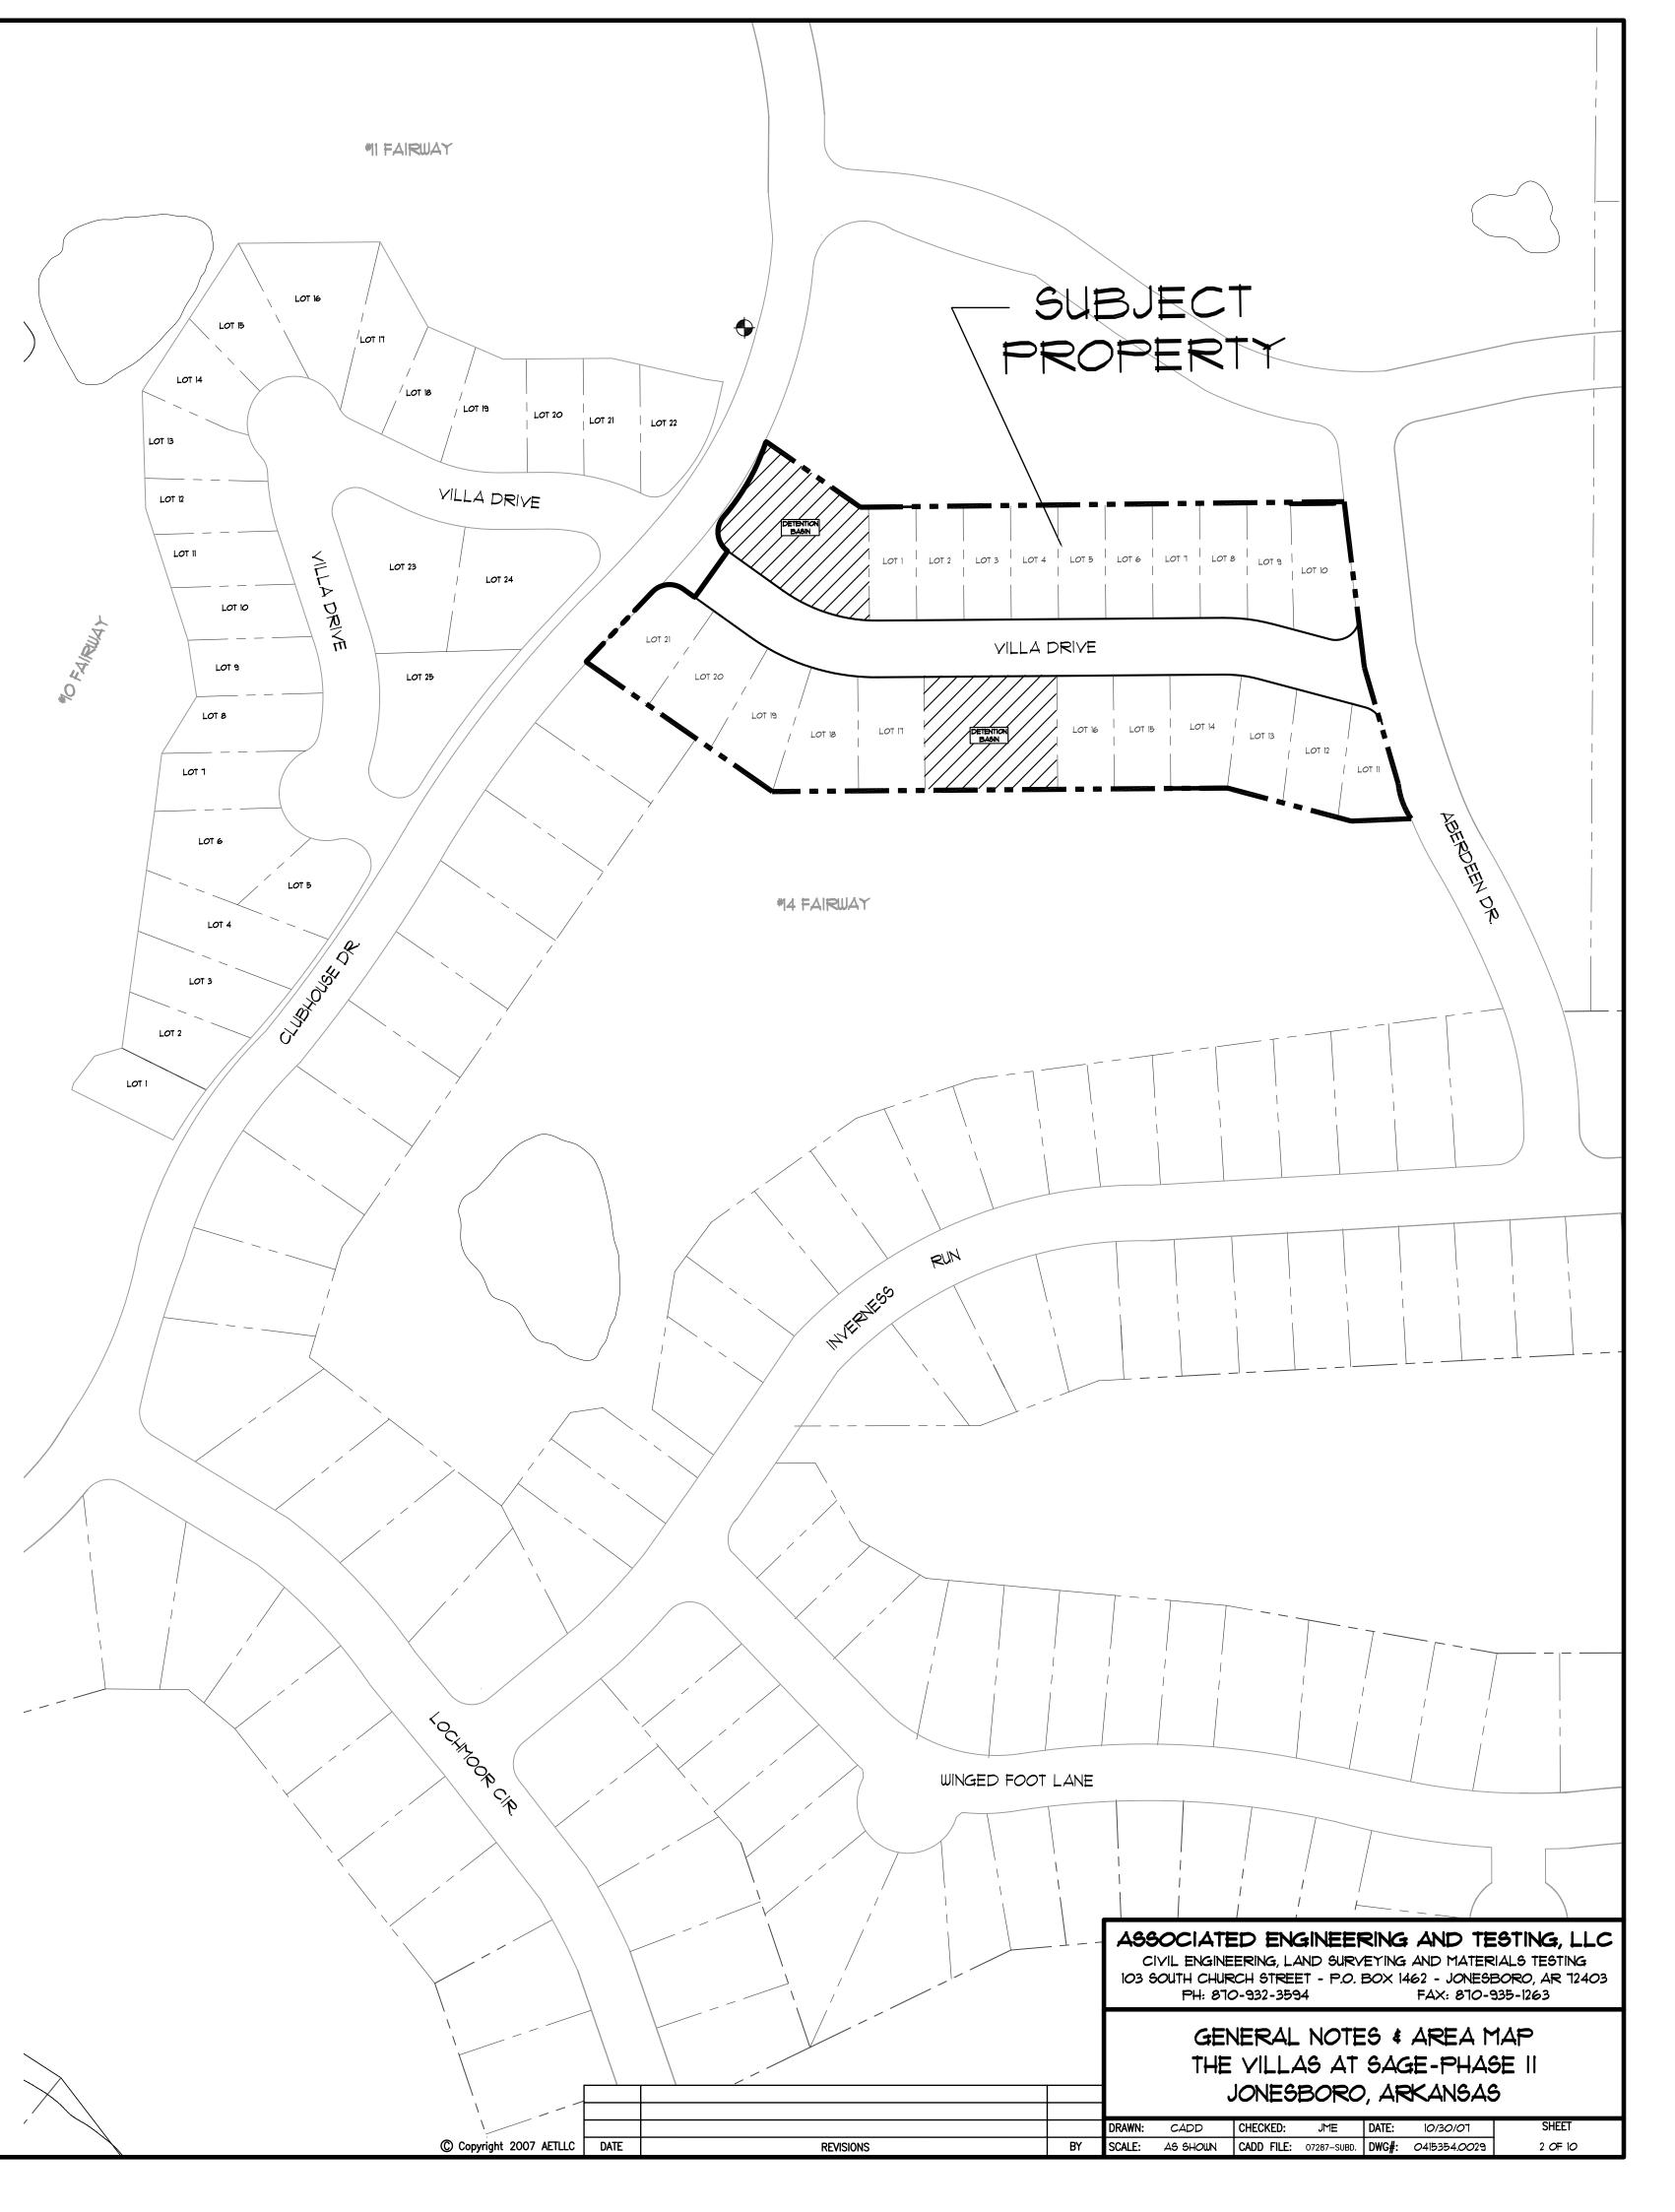


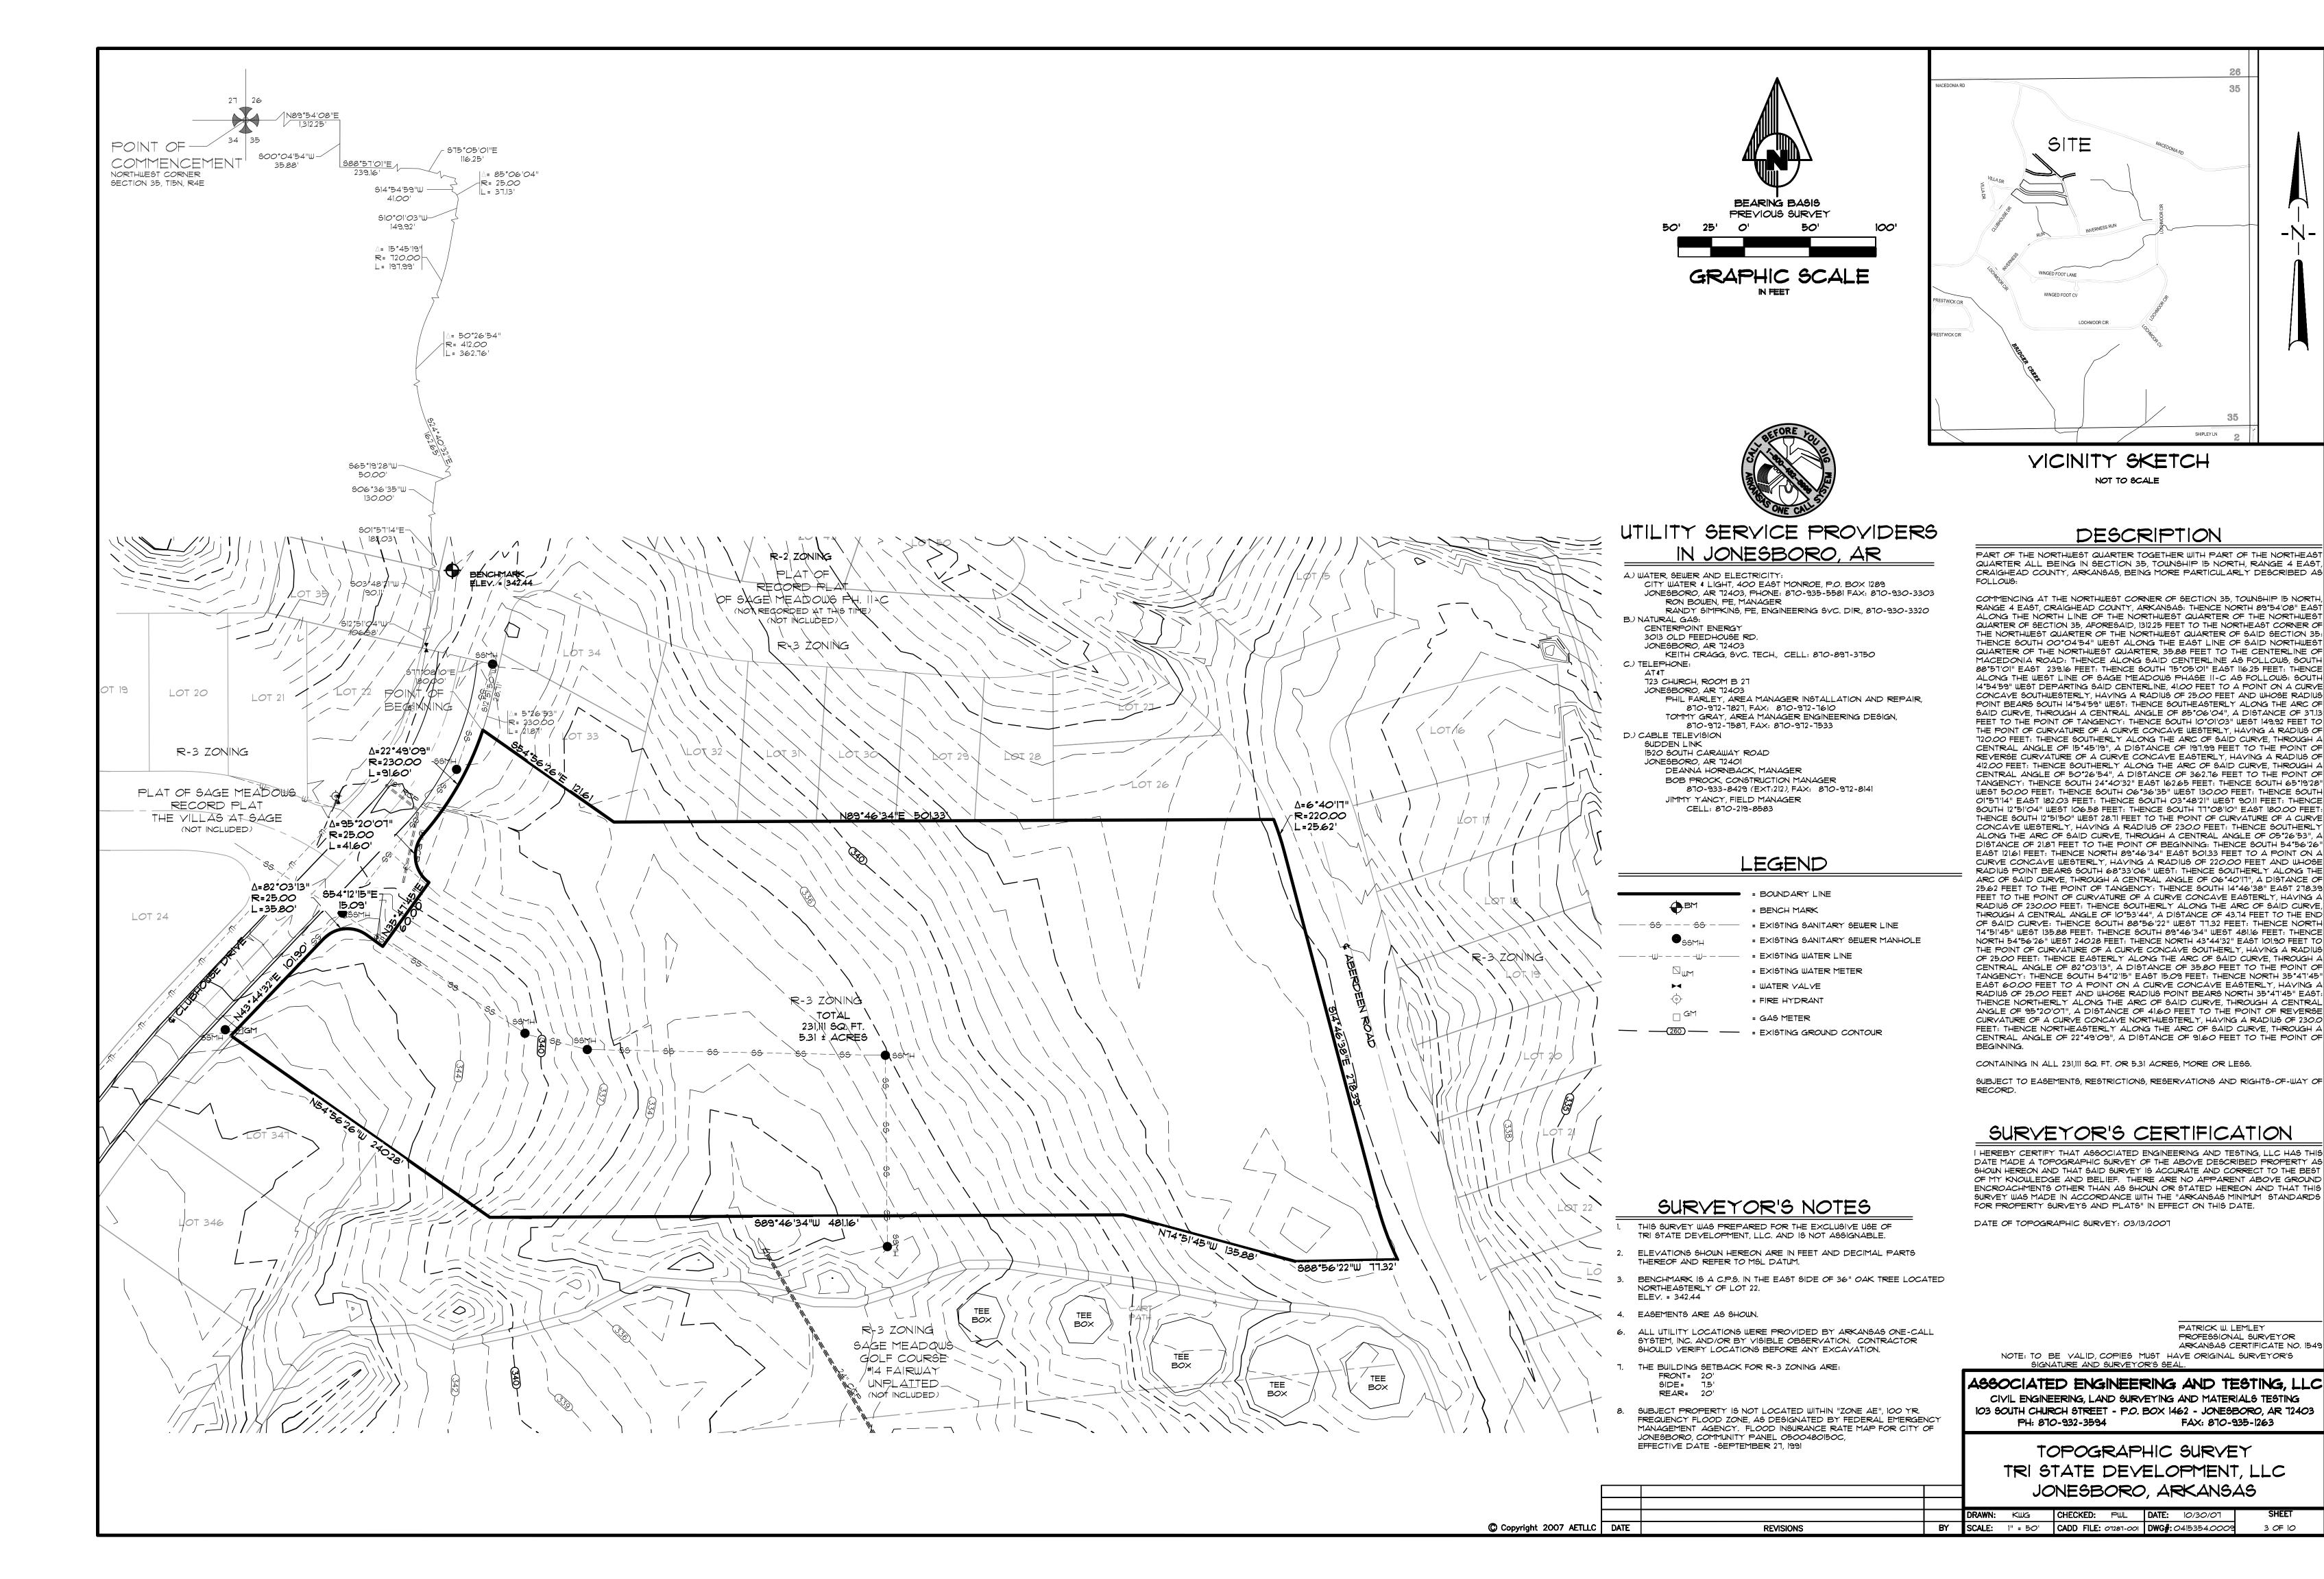


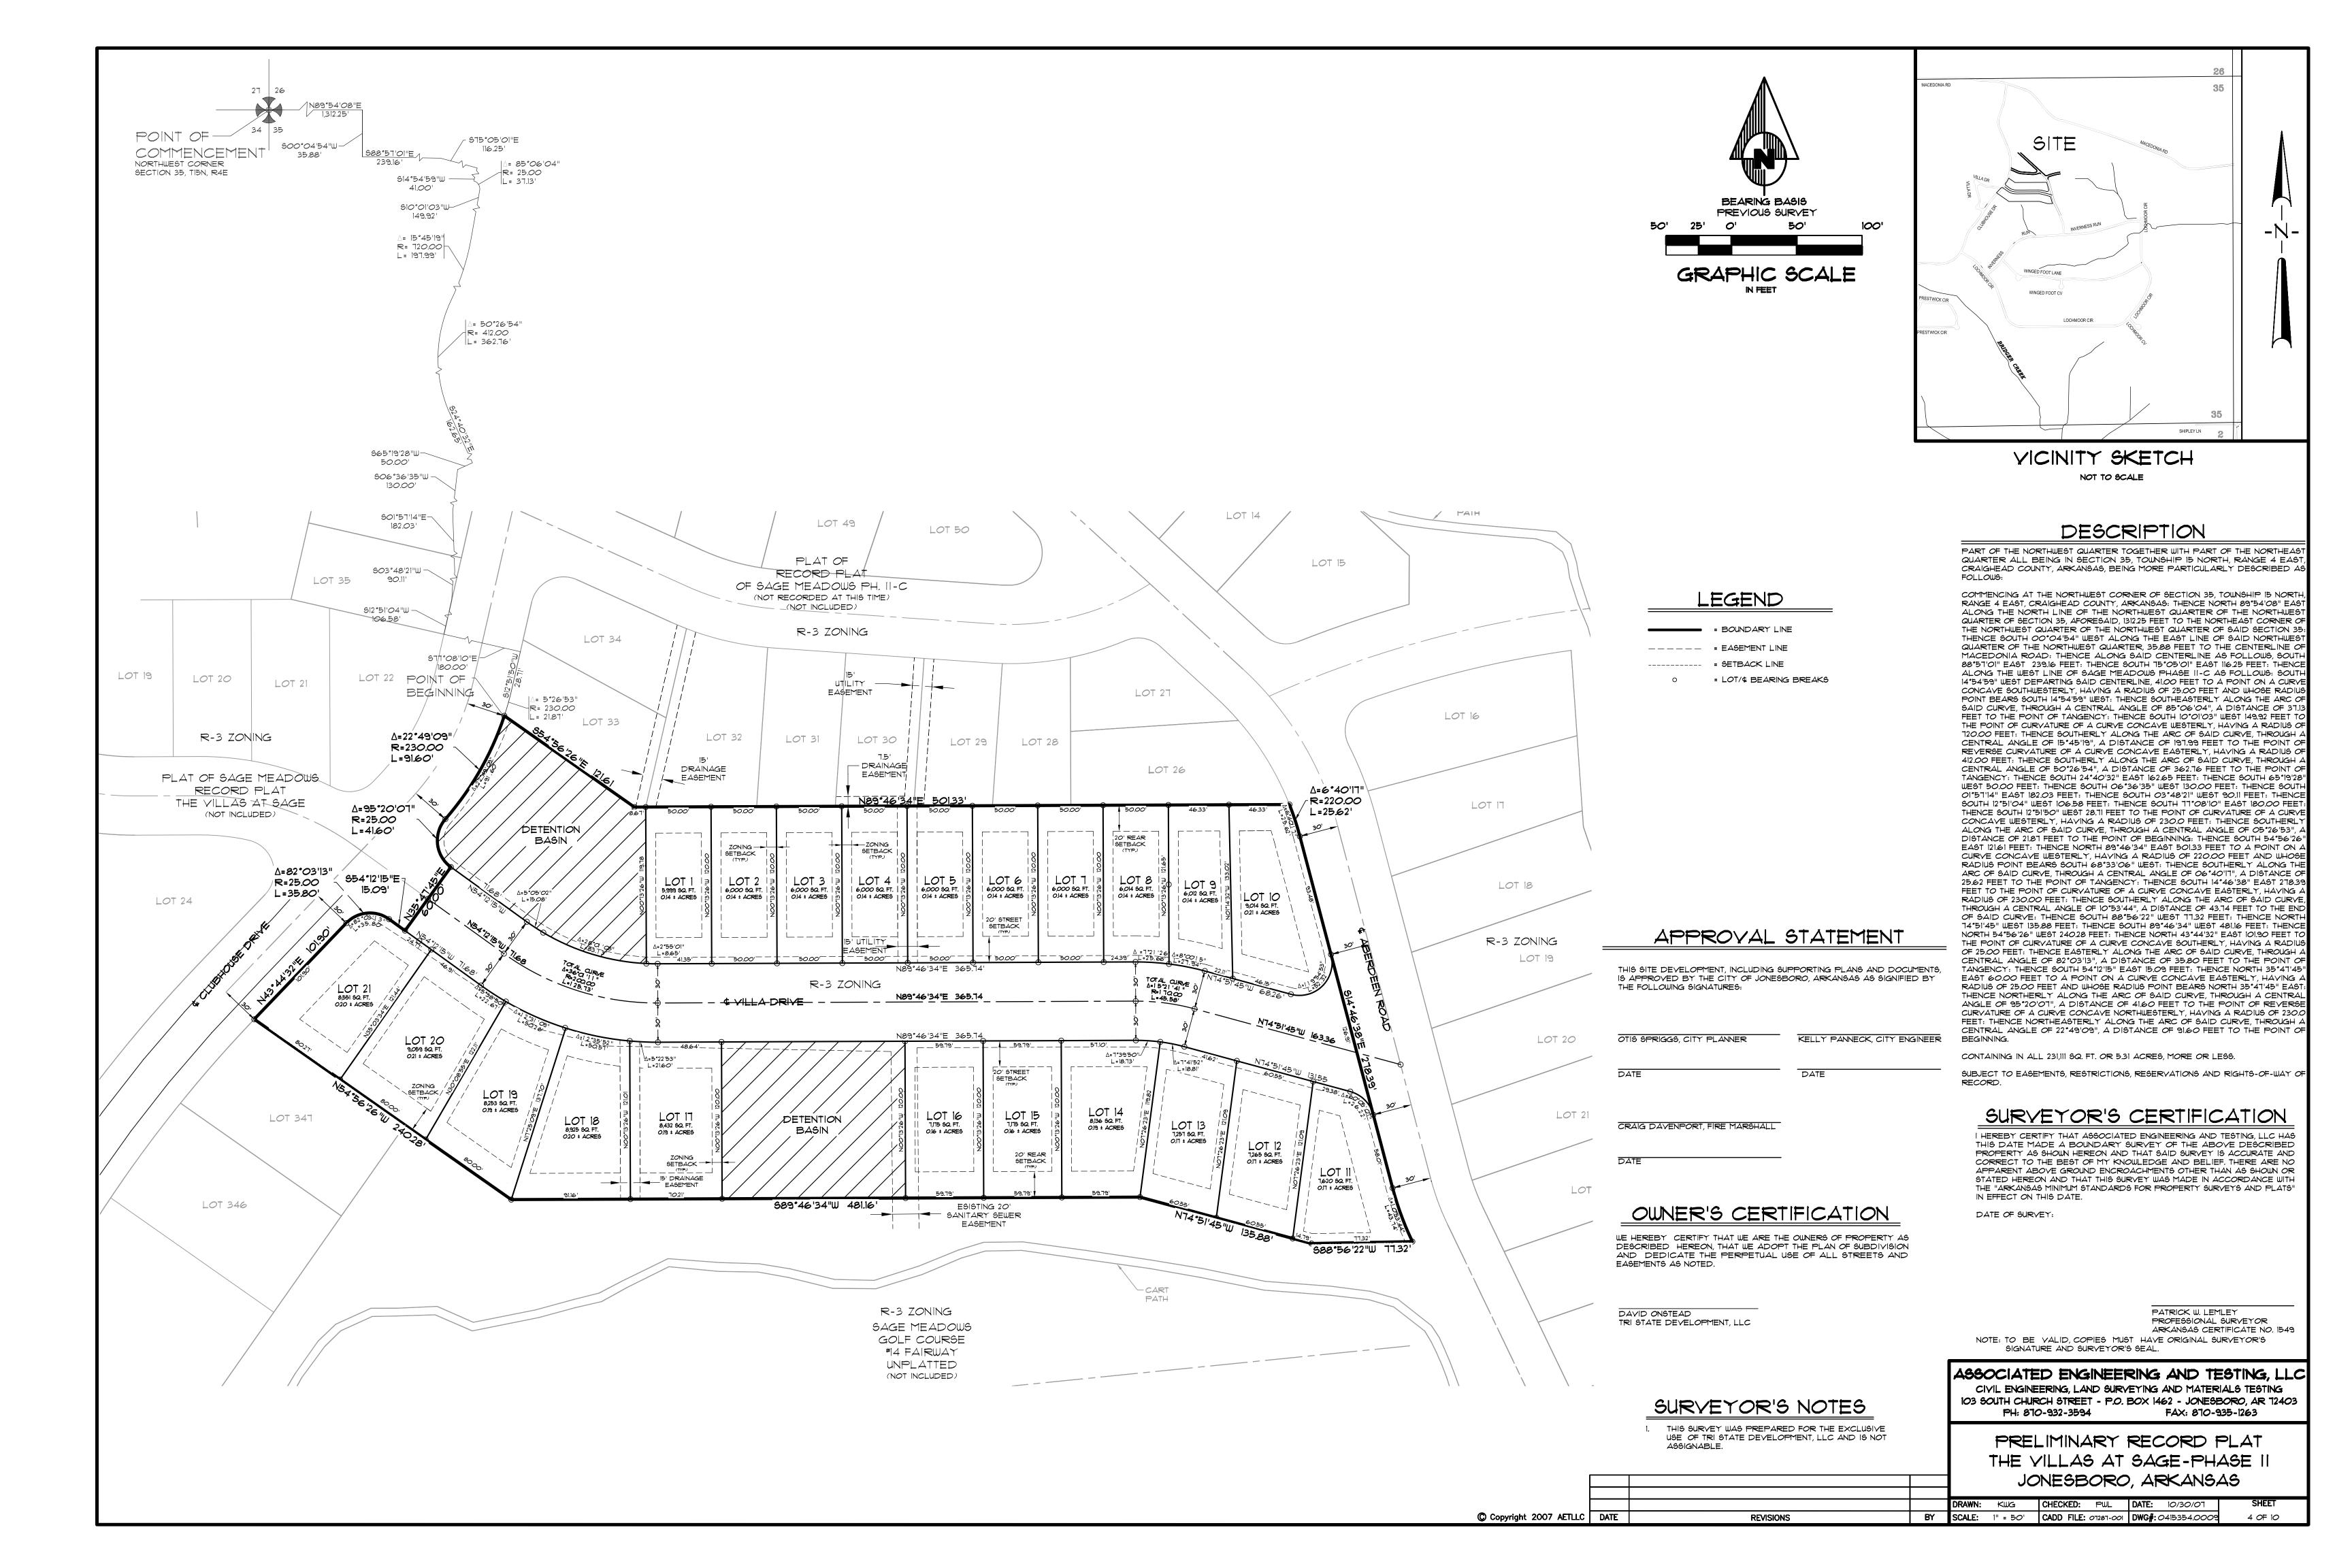


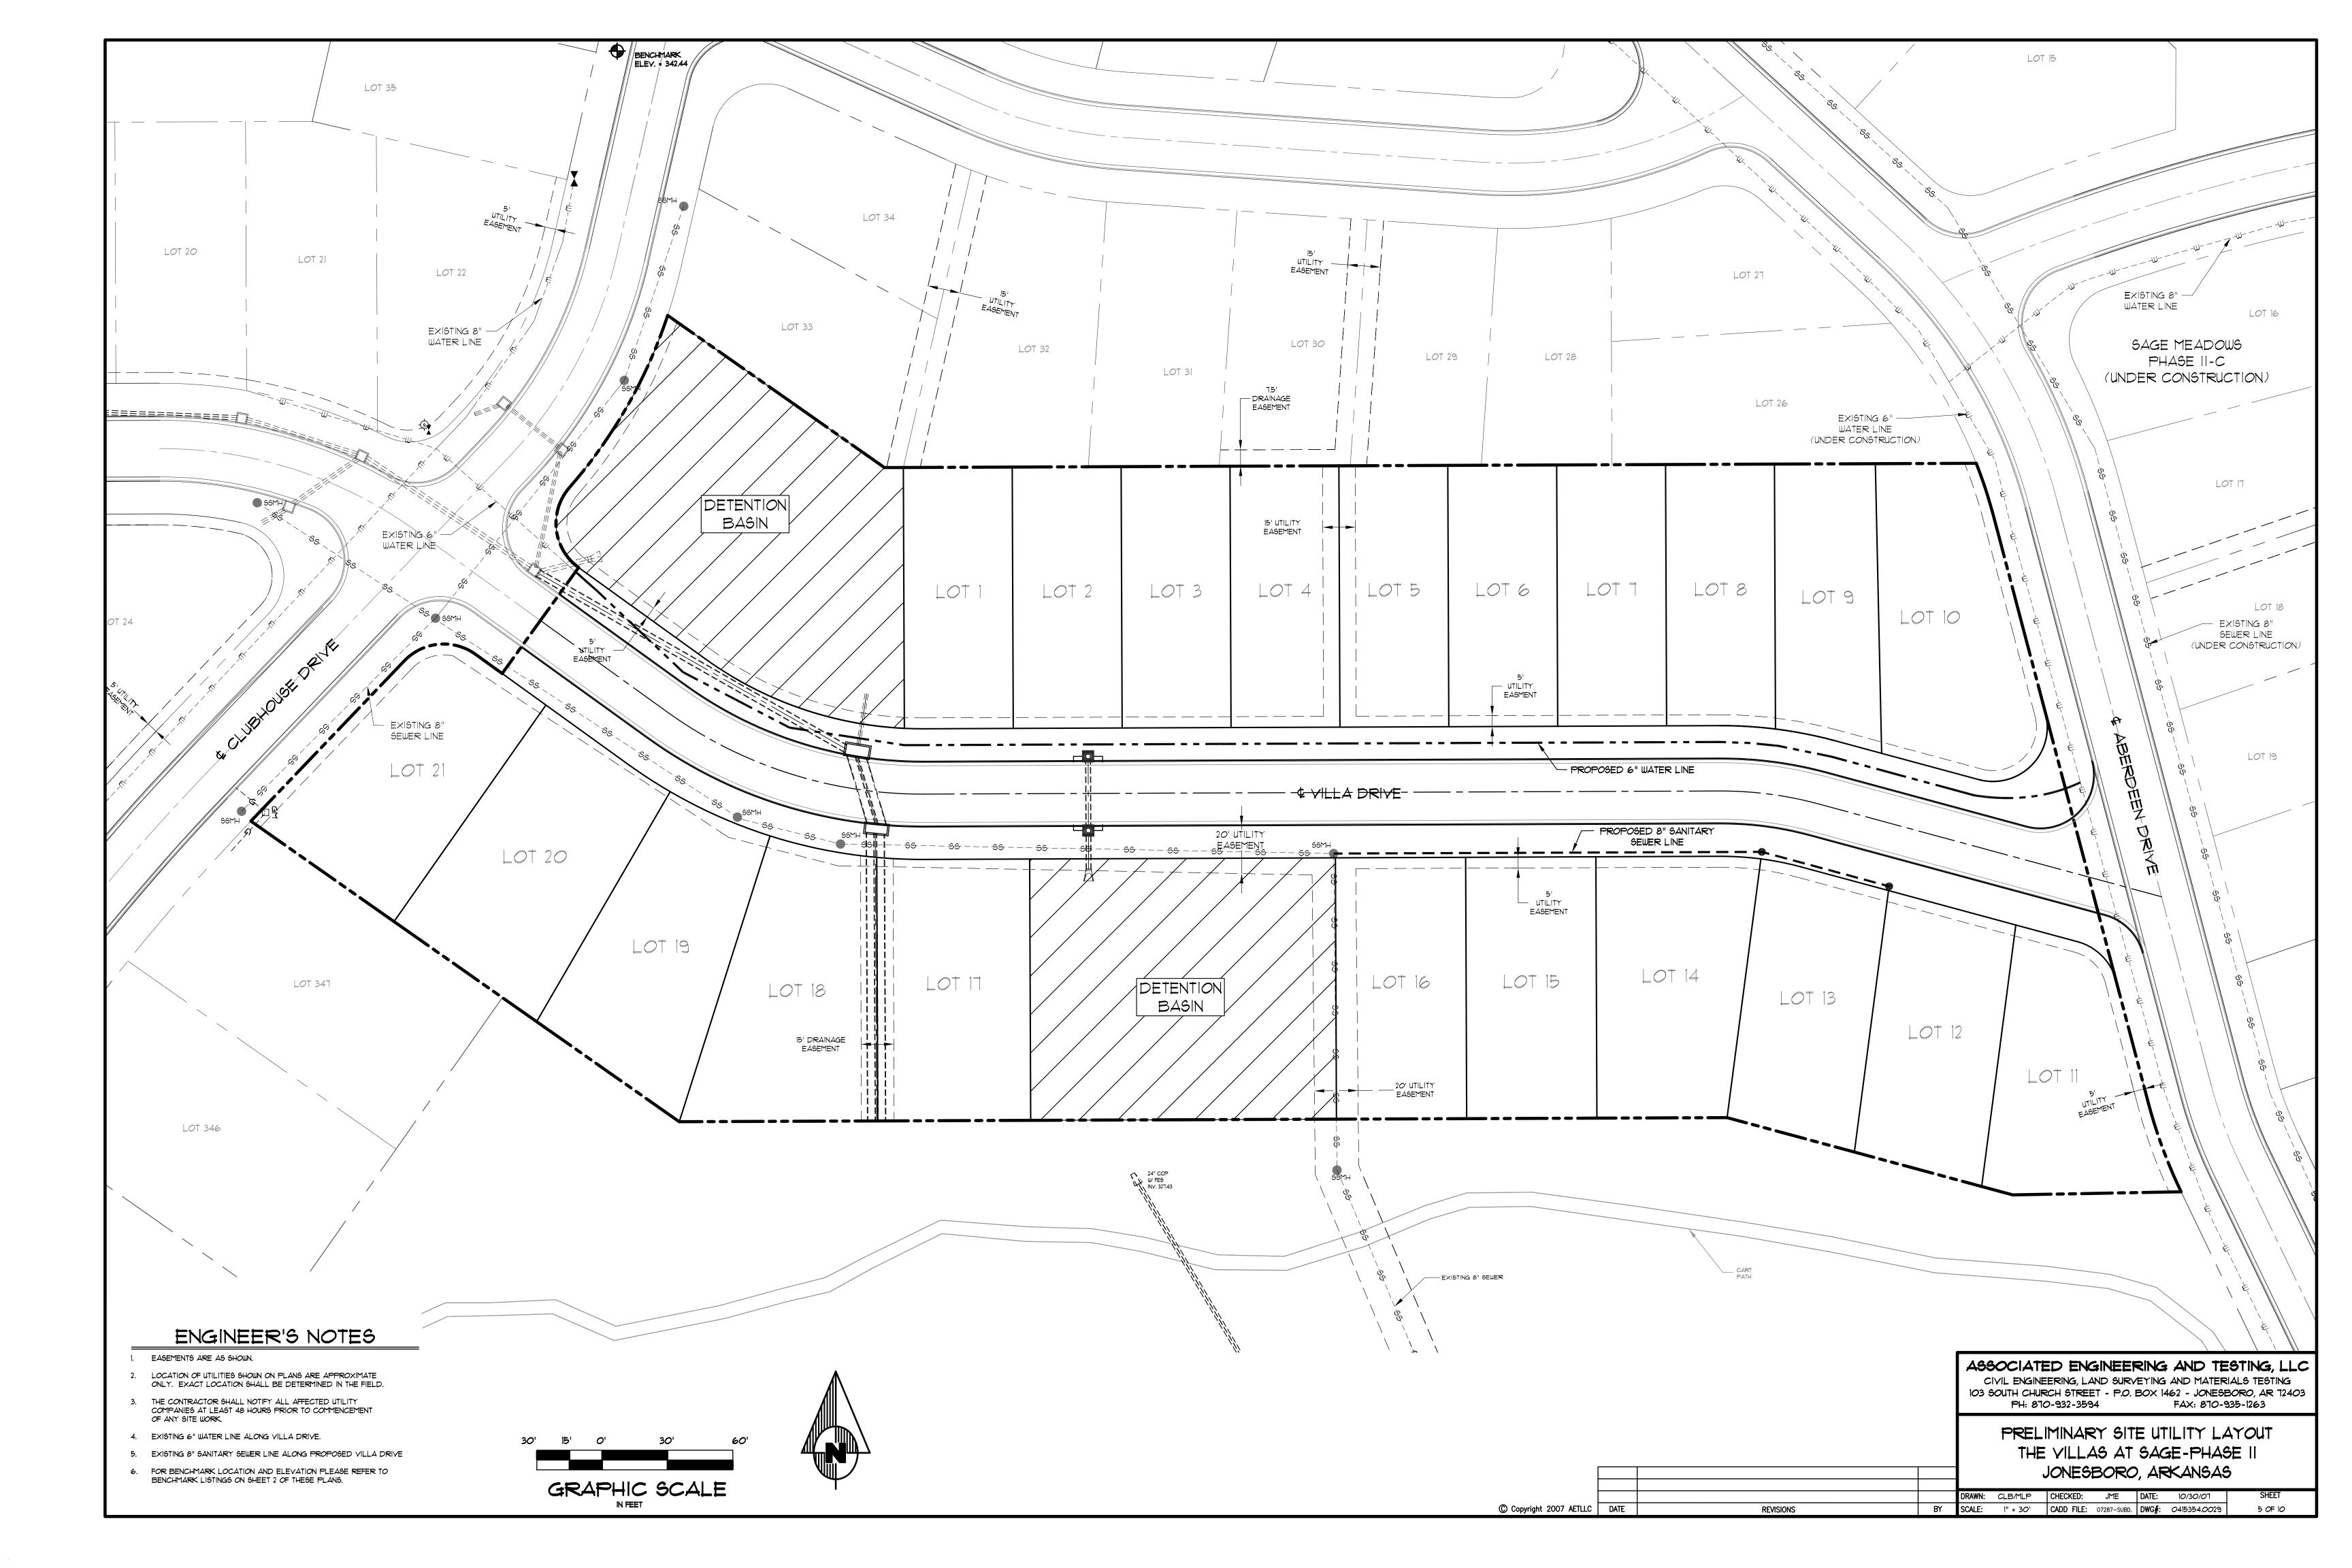

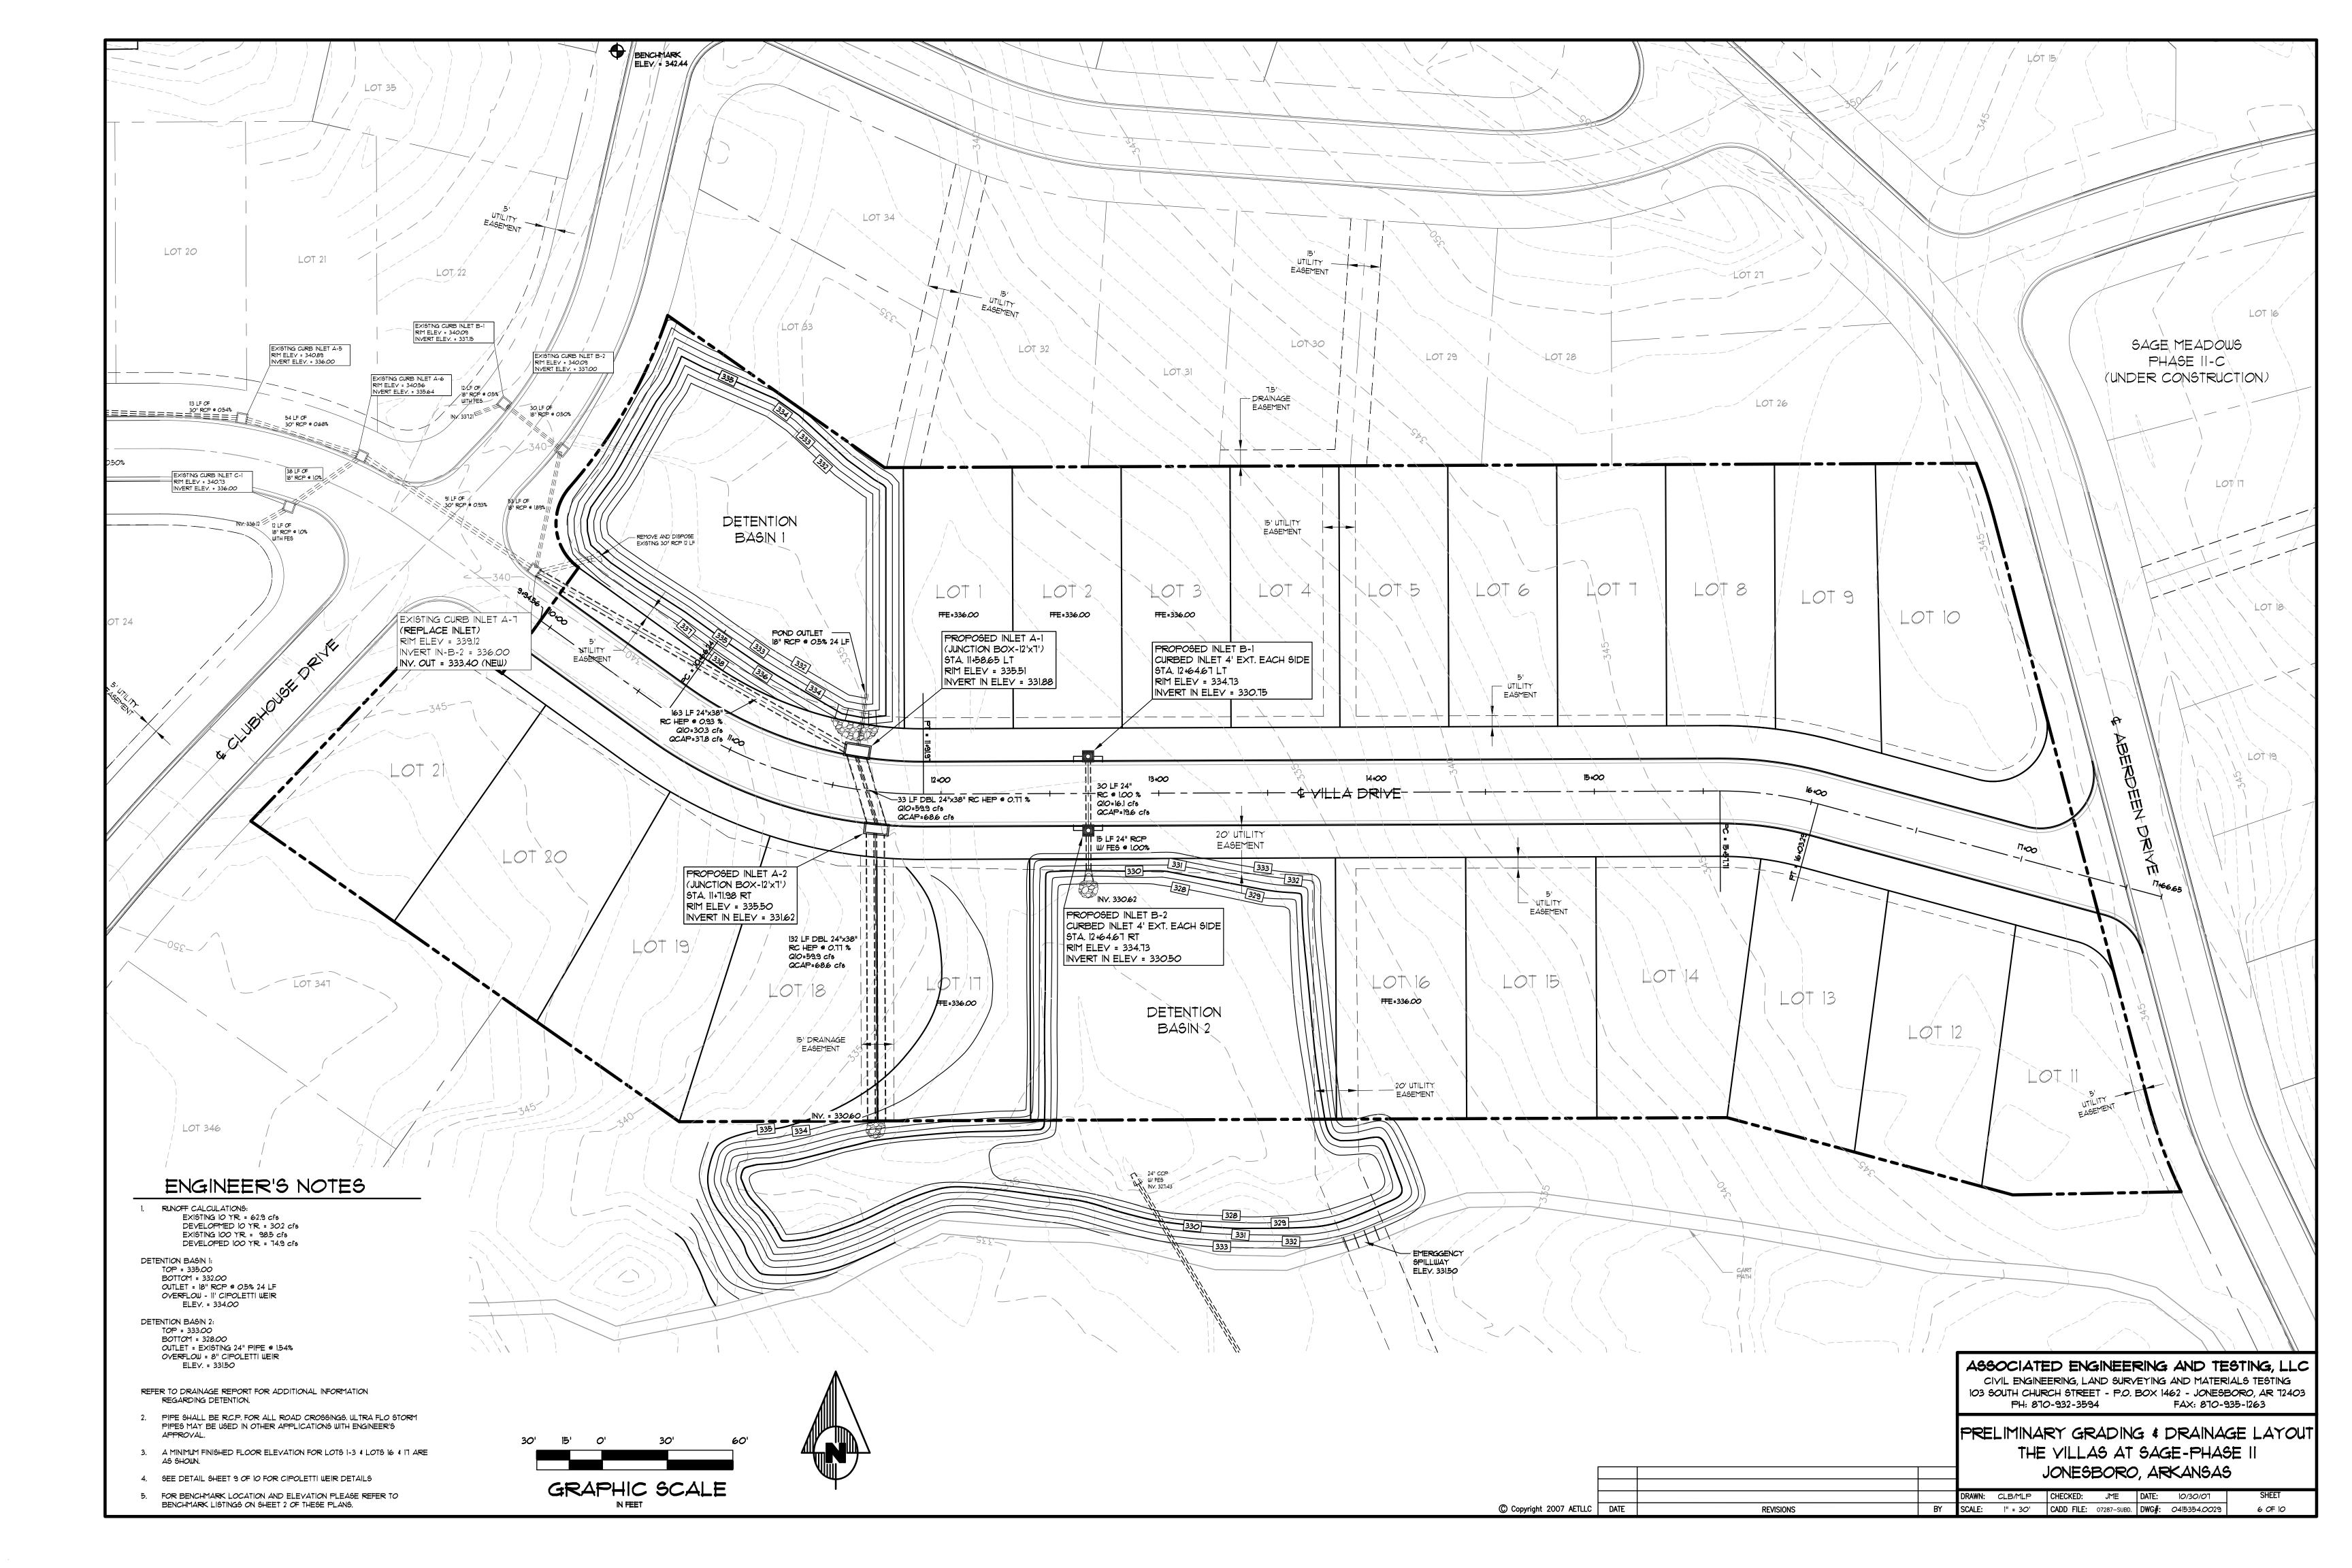

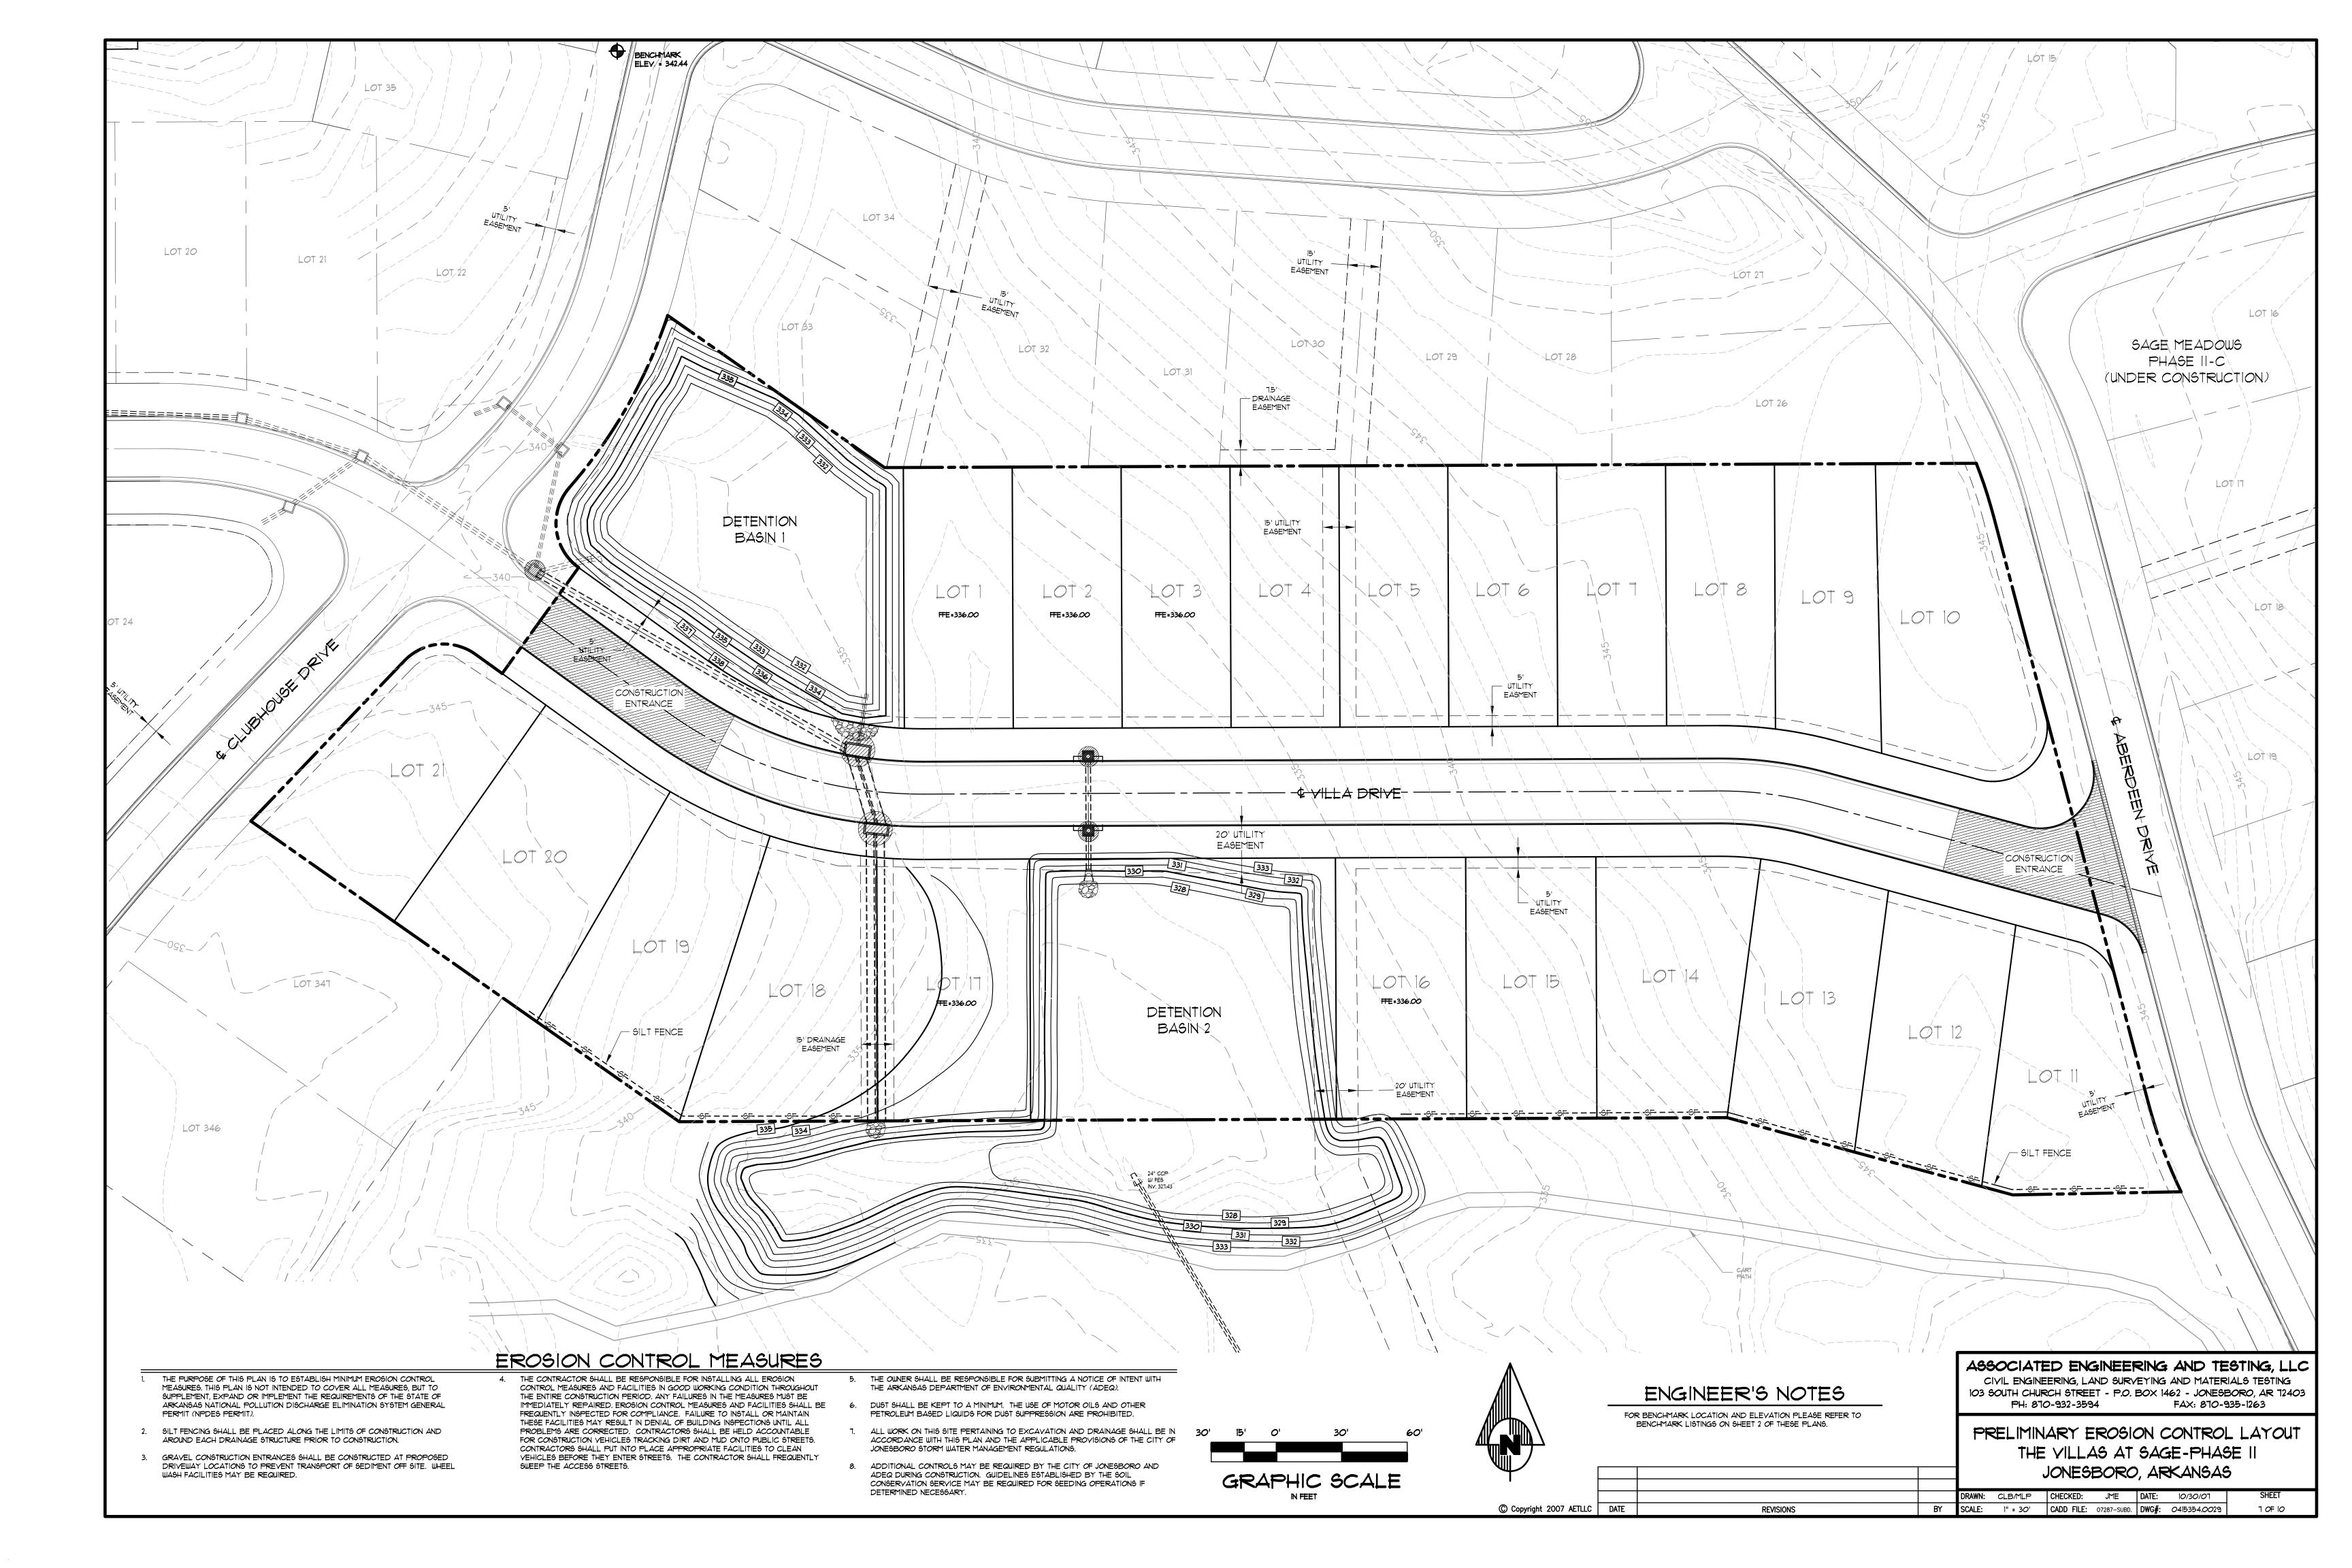


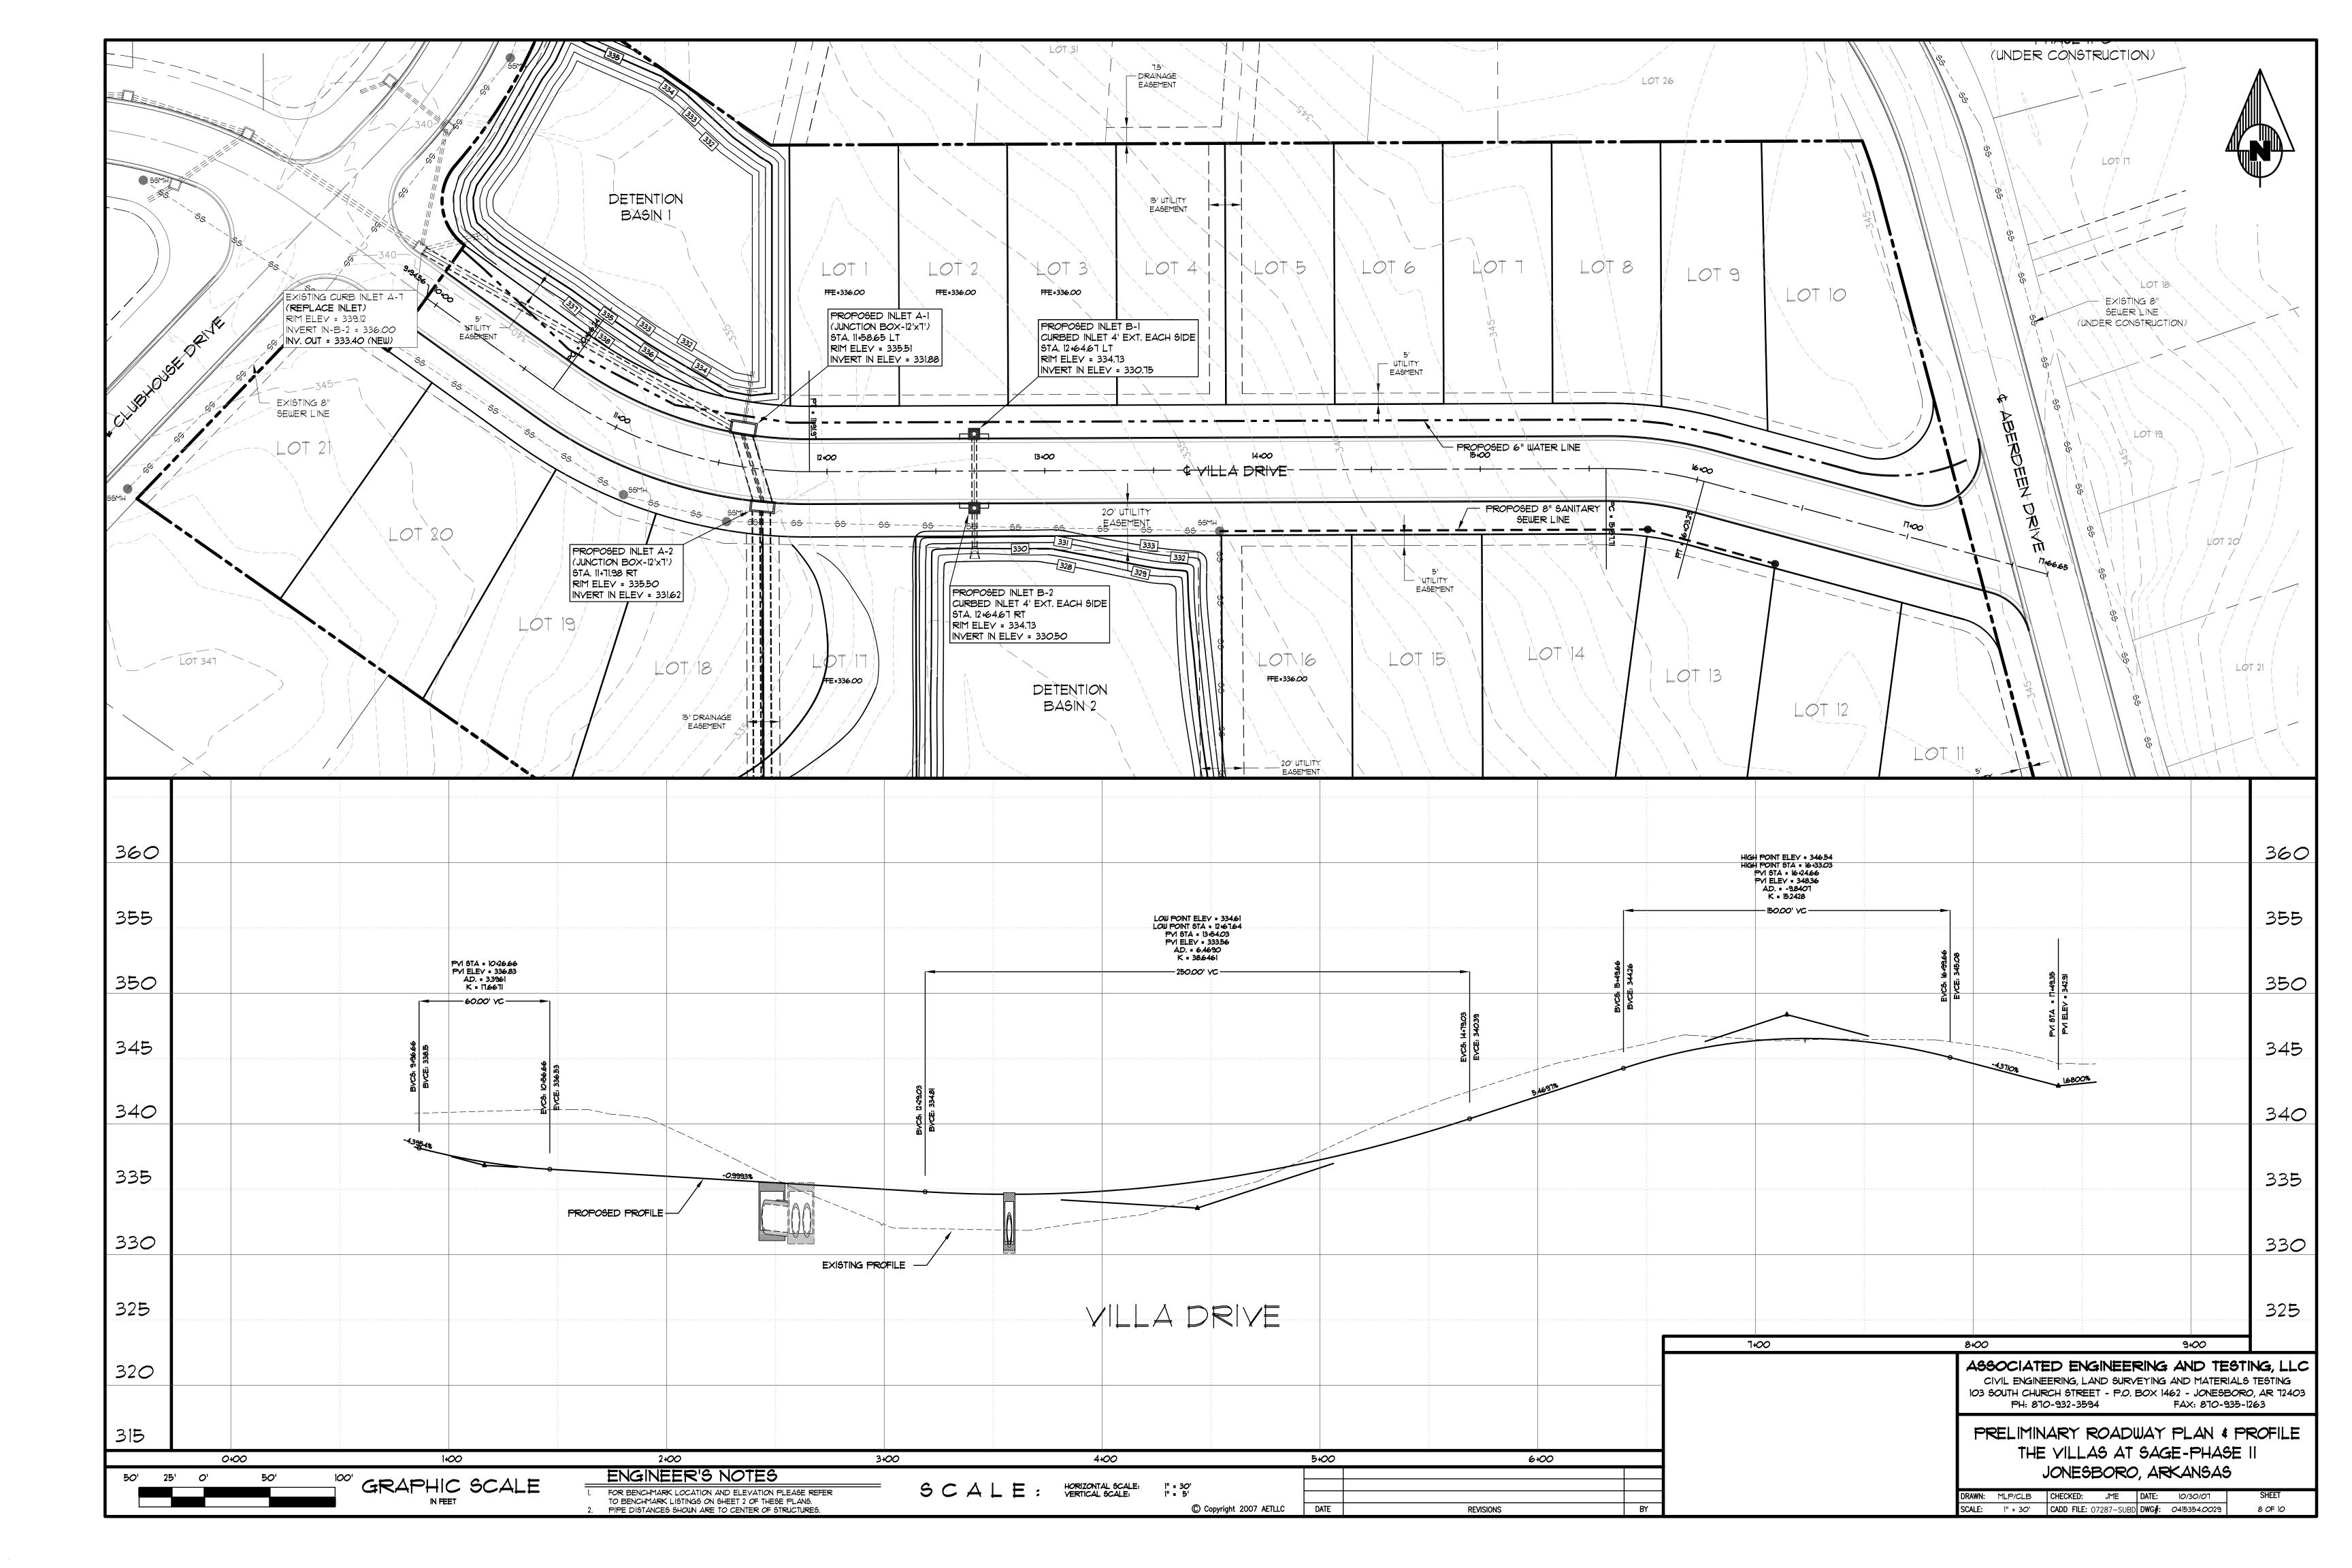

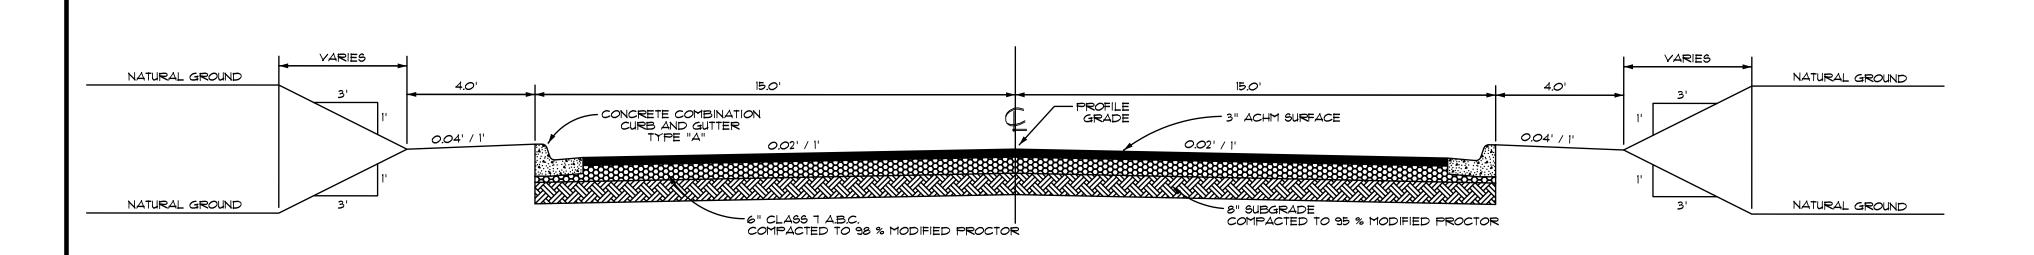


TYPICAL DRIVEWAY SECTION

(NOT TO SCALE)

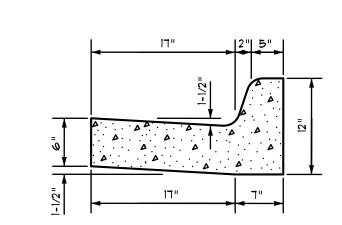


TYPICAL CURB & GUTTER TYPE "A" (NOT TO SCALE)

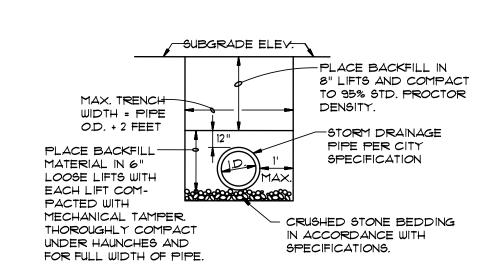

DRAINAGE PIPE TRENCH DETAIL NOTE: TO BE USED WITH NEW STREET CONSTRUCTION. SEE DRAWING NO. PT-1 FOR EXISTING


STREET CUTS.

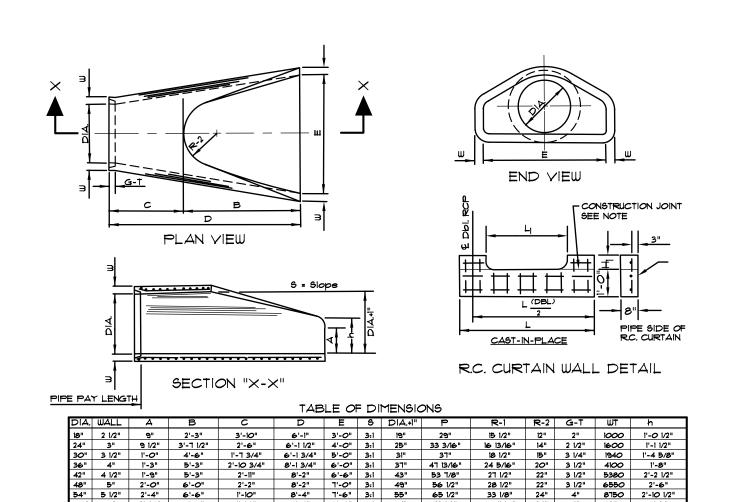


NOTES

- The portion of the R.C. Curtain Wall beneath the Flared End Section (Lower 1'-0") shall be placed monolithically. The Flared End Section shall then be set in place and the remaining portions of the R.C. Curtain Wall placed.
- 2. All reinforcing steel are #4 Bars at 6" O.C.
- 3. No separate payment will be made for the Curtain Walls. They shall be considered subsidiary to the Flared End Sections.
- 4. Tongue End On Upstream Section. Groove End On Downstream Section.


FLARED END SECTION DETAILS FOR REINFORCED CONCRETE PIPE CULVERT

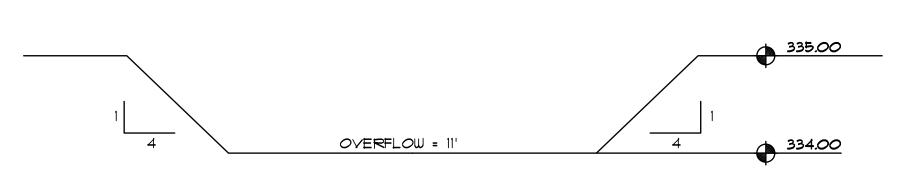

CIPOLETTI WEIR-BASIN 1

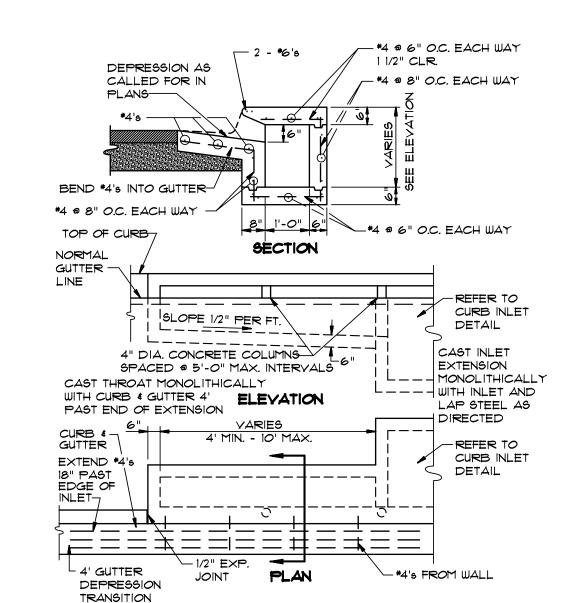


CURB INLET EXTENSION

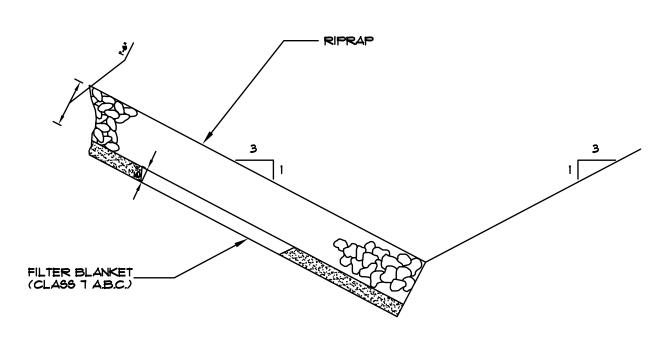


NOTE: IN LIEU OF AN AGGREGATE FILTER BLANKET,
A SYNTHETIC FIBER GEOTEXTILE FABRIC MEETING
THE REQUIREMENTS OF AASHTO M288 MAY BE USED.
IN LIEU OF RIPRAP, AN EROSION CONTROL MAT MAY
BE USED.

SECTION - DUMPED RIPRAP


TOE EXCAVATION IN SOIL

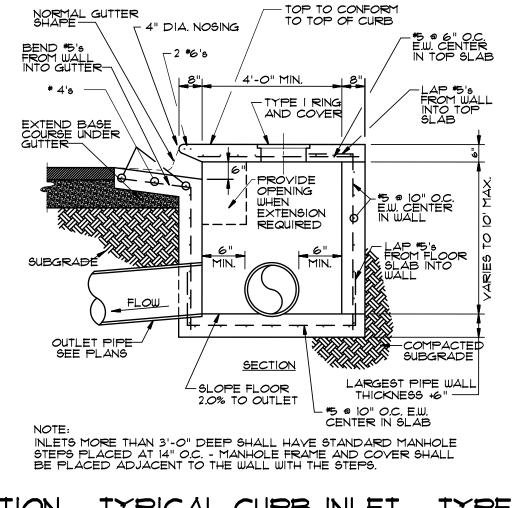

SECTION - TYPICAL CURB INLET - TYPE "A"

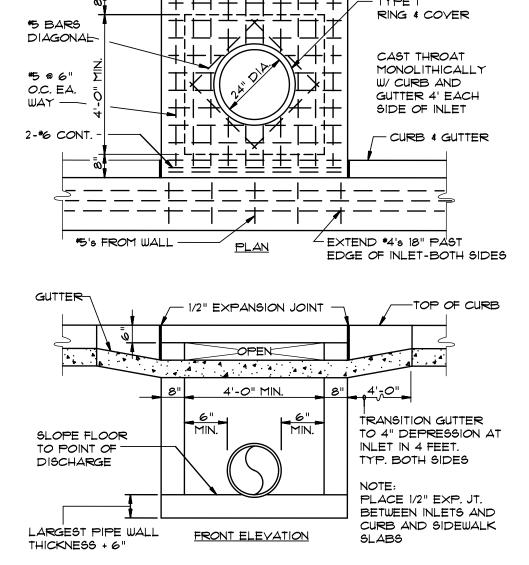


CURB INLET - TYPE "A"

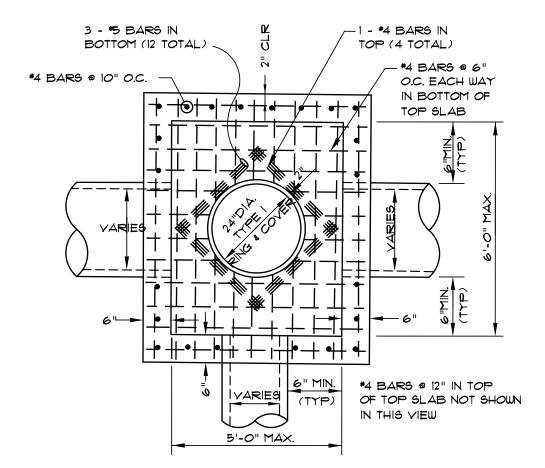

PLAN - JUNCTION BOX - LIGHT

<u>NOTE:</u> DO NOT USE UNDER VEHICULAR TRAFFIC.

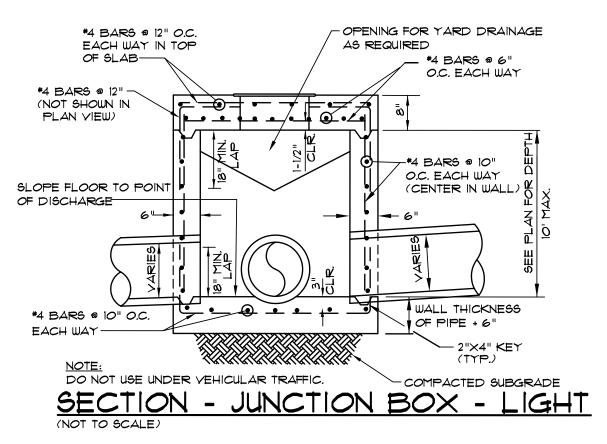

NOTES:

1. JUNCTION BOXES MORE THAN 3 FEET DEEP SHALL HAVE STANDARD MANHOLE STEPS PLACED @ 15" O.C.

2. SEE REINFORCING DETAIL FOR OPENING IN WALL OR SLAB.

CIPOLETTI WEIR-BASIN 2

(NOT TO SCALE)

ASSOCIATED ENGINEERING AND TESTING, LLC


CIVIL ENGINEERING, LAND SURVEYING AND MATERIALS TESTING


103 SOUTH CHURCH STREET - P.O. BOX 1462 - JONESBORO, AR 12403


PH: 870-932-3594


FAX: 870-935-1263

DETAILS-STANDARD
THE VILLAS AT SAGE-PHASE II
JONESBORO, ARKANSAS

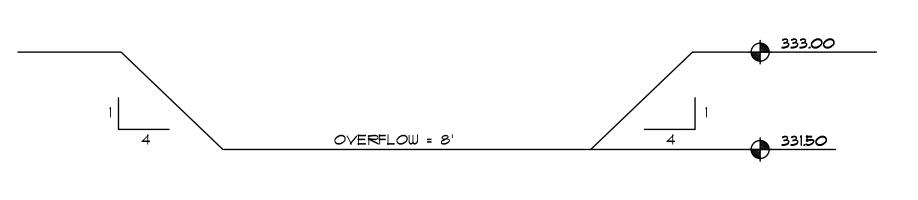

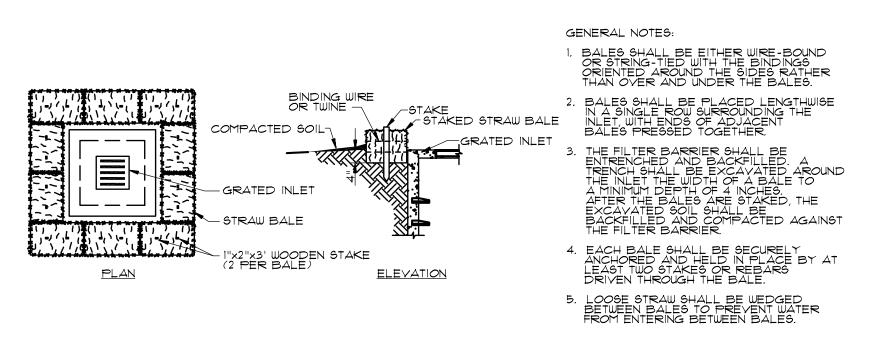

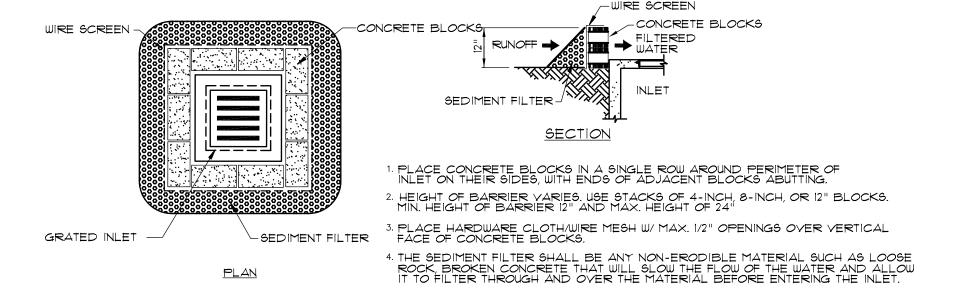


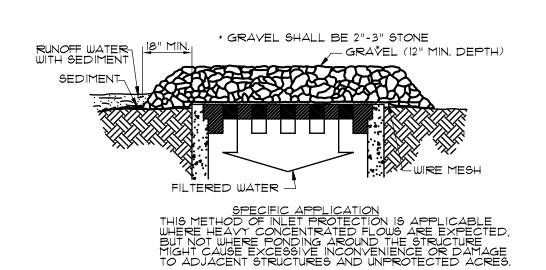



STRAW BALE INLET SEDIMENT FILTER


BLOCK AND AGGREGATE INLET SEDIMENT FILTER

GRAVEL AND WIRE MESH INLET SEDIMENT FITLER

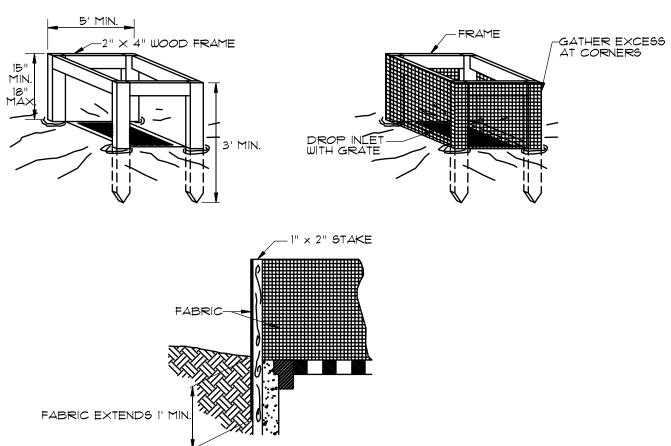

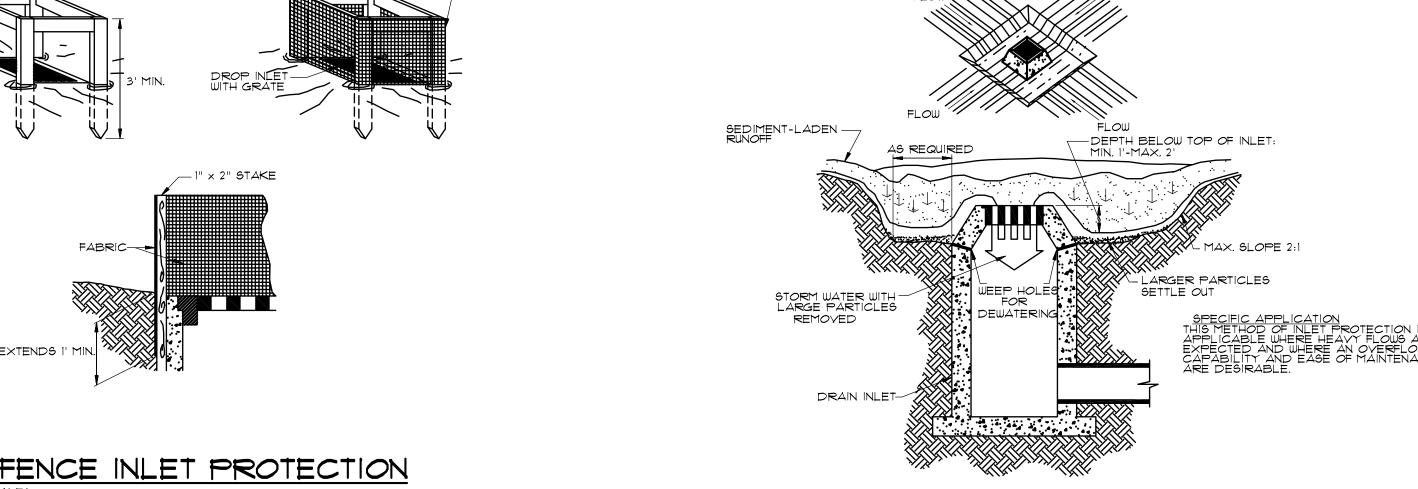

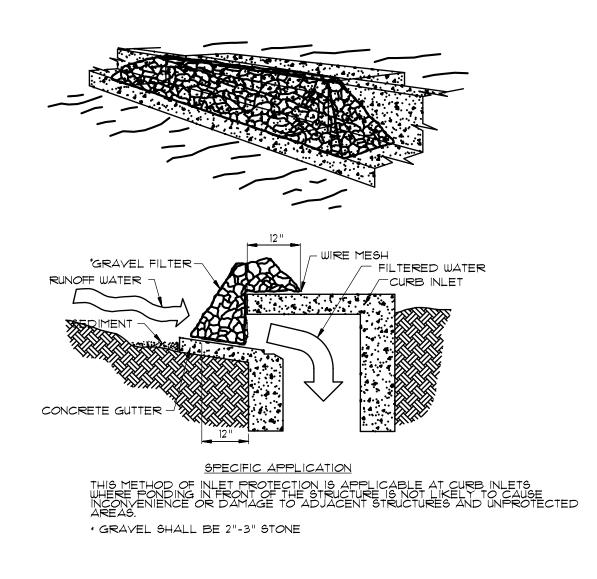

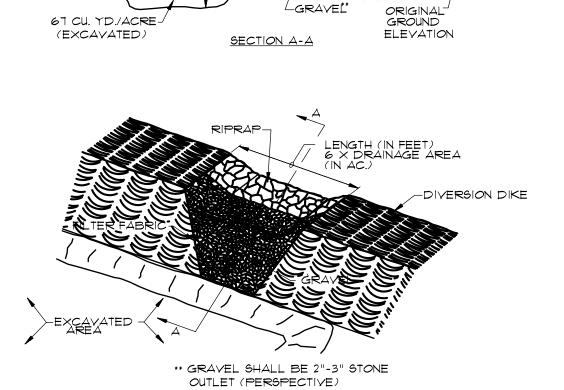

RIPRAP FILTER FABRIC


SILT FENCE INLET PROTECTION


(NOT TO SCALE)




GRAVEL CURB INLET SEDIMENT FILTER

TEMPORARY SEDIMENT TRAP

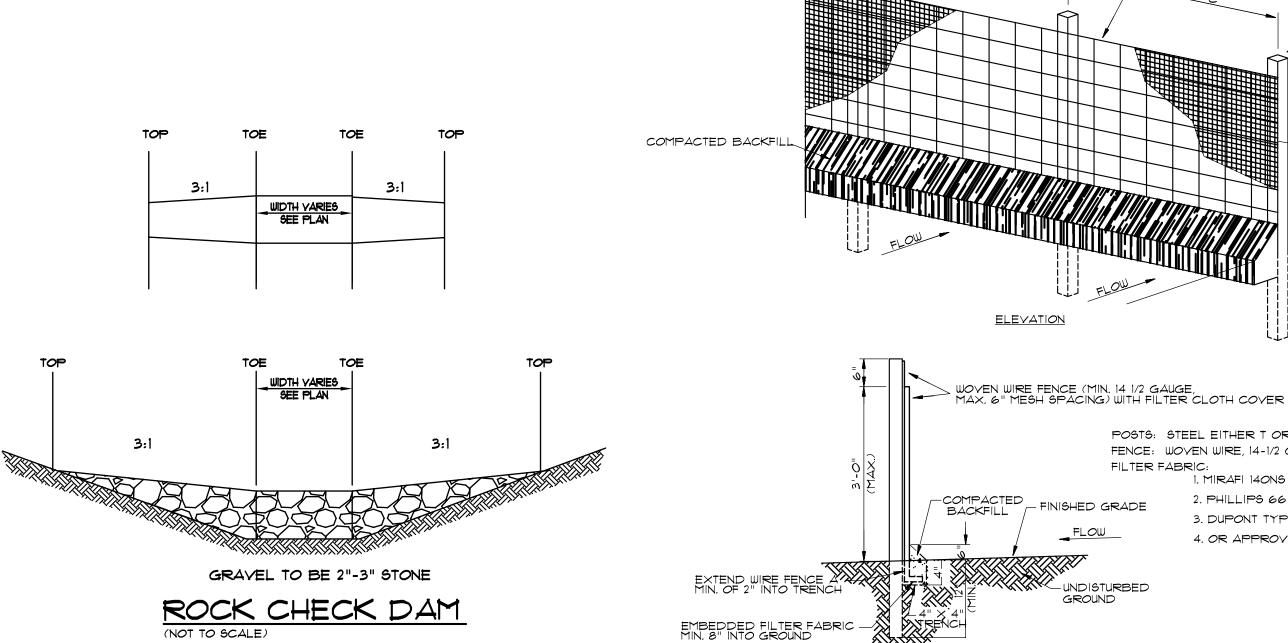

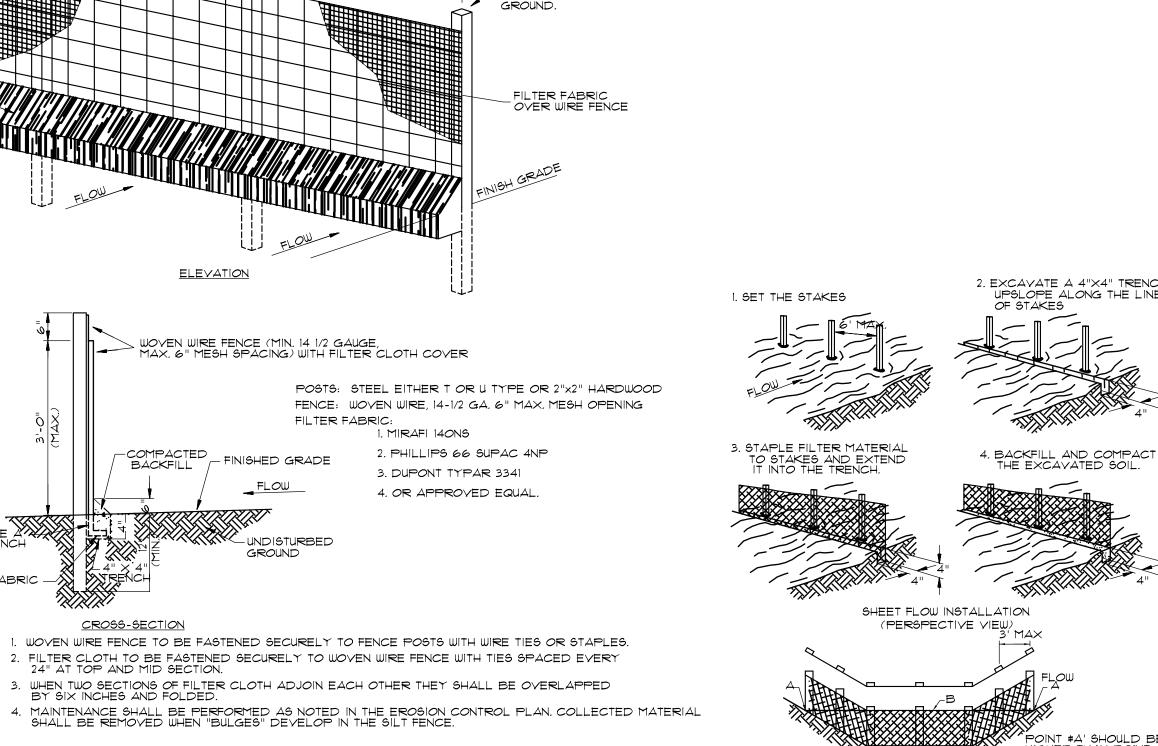

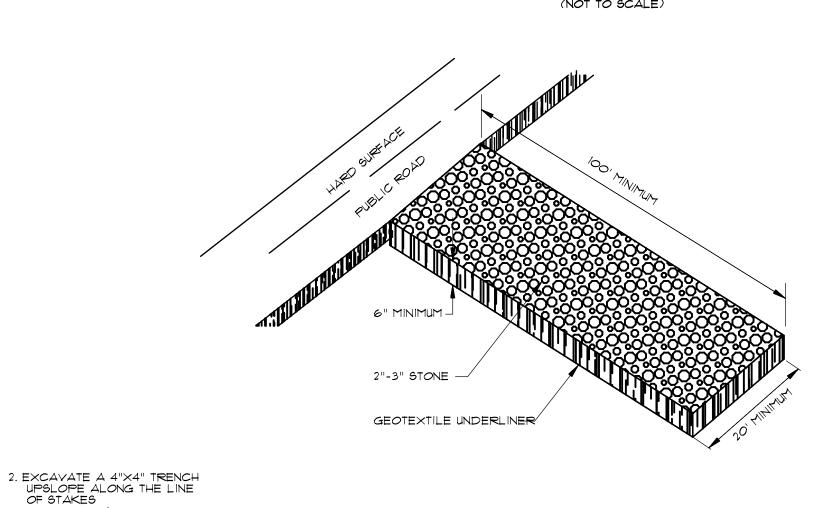

CONSTRUCTION ENTRANCE

ASSOCIATED ENGINEERING AND TESTING, LLC CIVIL ENGINEERING, LAND SURVEYING AND MATERIALS TESTING 103 SOUTH CHURCH STREET - P.O. BOX 1462 - JONESBORO, AR 12403 FAX: 870-935-1263 PH: 870-932-3594

DETAILS-EROSION CONTROL THE VILLAS AT SAGE-PHASE II JONESBORO, ARKANSAS

SEDIMENTATION/SILT FENCE

FILTER BARRIER (NOT TO SCALE)

DRAINAGEWAY INSTALLATION (FRONT ELEVATION)

DRAWN: CADD CHECKED: JME DATE: 10/30/01 © Copyright 2007 AETLLC DATE SCALE: AS SHOWN CADD FILE: 07287-SUBD. DWG#: 0415354.0029 10 OF 10 REVISIONS