
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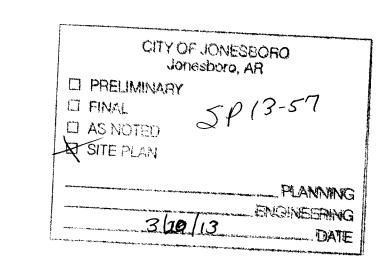
JONESBORO, CRAIGHEAD COUNTY, ARKANSAS

CONTACT INFORMATION			
CONTACT	ADDRESS	PHONE NUMBER	
CITY OF JONESBORO ENGINEERING DEPARTMENT	307 VINE STREET JONESBORO, AR 72401	870-932-2438	
CITY OF JONESBORO PLANNING AND ZONING	307 VINE STREET JONESBORO, AR 72401	870-932-0406	
CITY, WATER & LIGHT	400 EAST MONROE JONESBORO, AR 72401	870-935-5581	
AT&T	723 SOUTH CHURCH STREET JONESBORO, AR 72401	1-800-464-7928	
RITTER COMMUNICATIONS	2109 FOWLER AVENUE JONESBORO, AR 72401	870-336-3400	
SUDDENLINK COMMUNICATIONS	1520 SOUTH CARAWAY ROAD JONESBORO, AR 72401	870-935-3615	
CENTER POINT ENERGY GAS	3013 OLD FEED HOUSE ROAD JONESBORO, AR 72401	870-972-6682	




	INDEX	
PAGE	DESCRIPTION	DATE
1	COVER PAGE	3/18/2013
2	TOPOGRAPHIC SURVEY	1/24/2013
3	EROSION CONTROL PLAN	3/18/2013
4	CIVIL SITE PLAN	3/18/2013
5	CIVIL SITE GRADING PLAN	3/18/2013

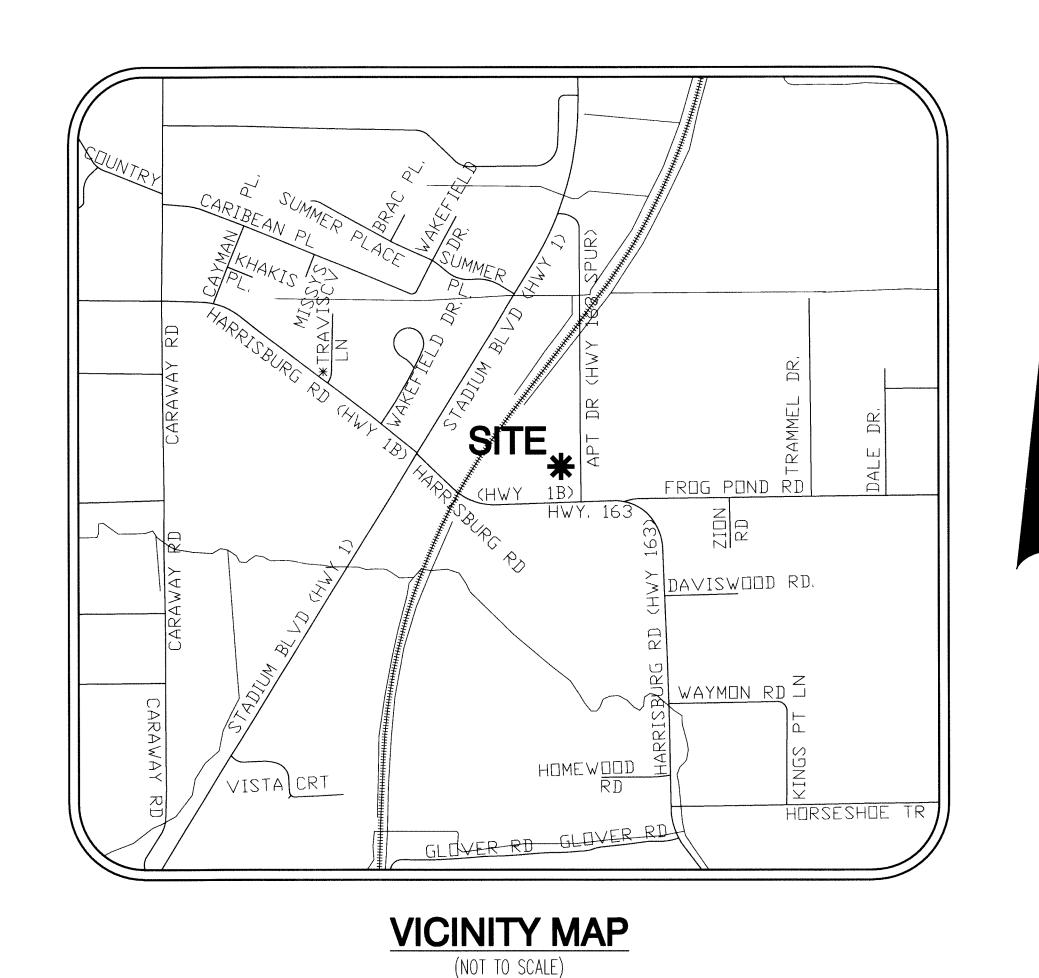



COVER SHEET

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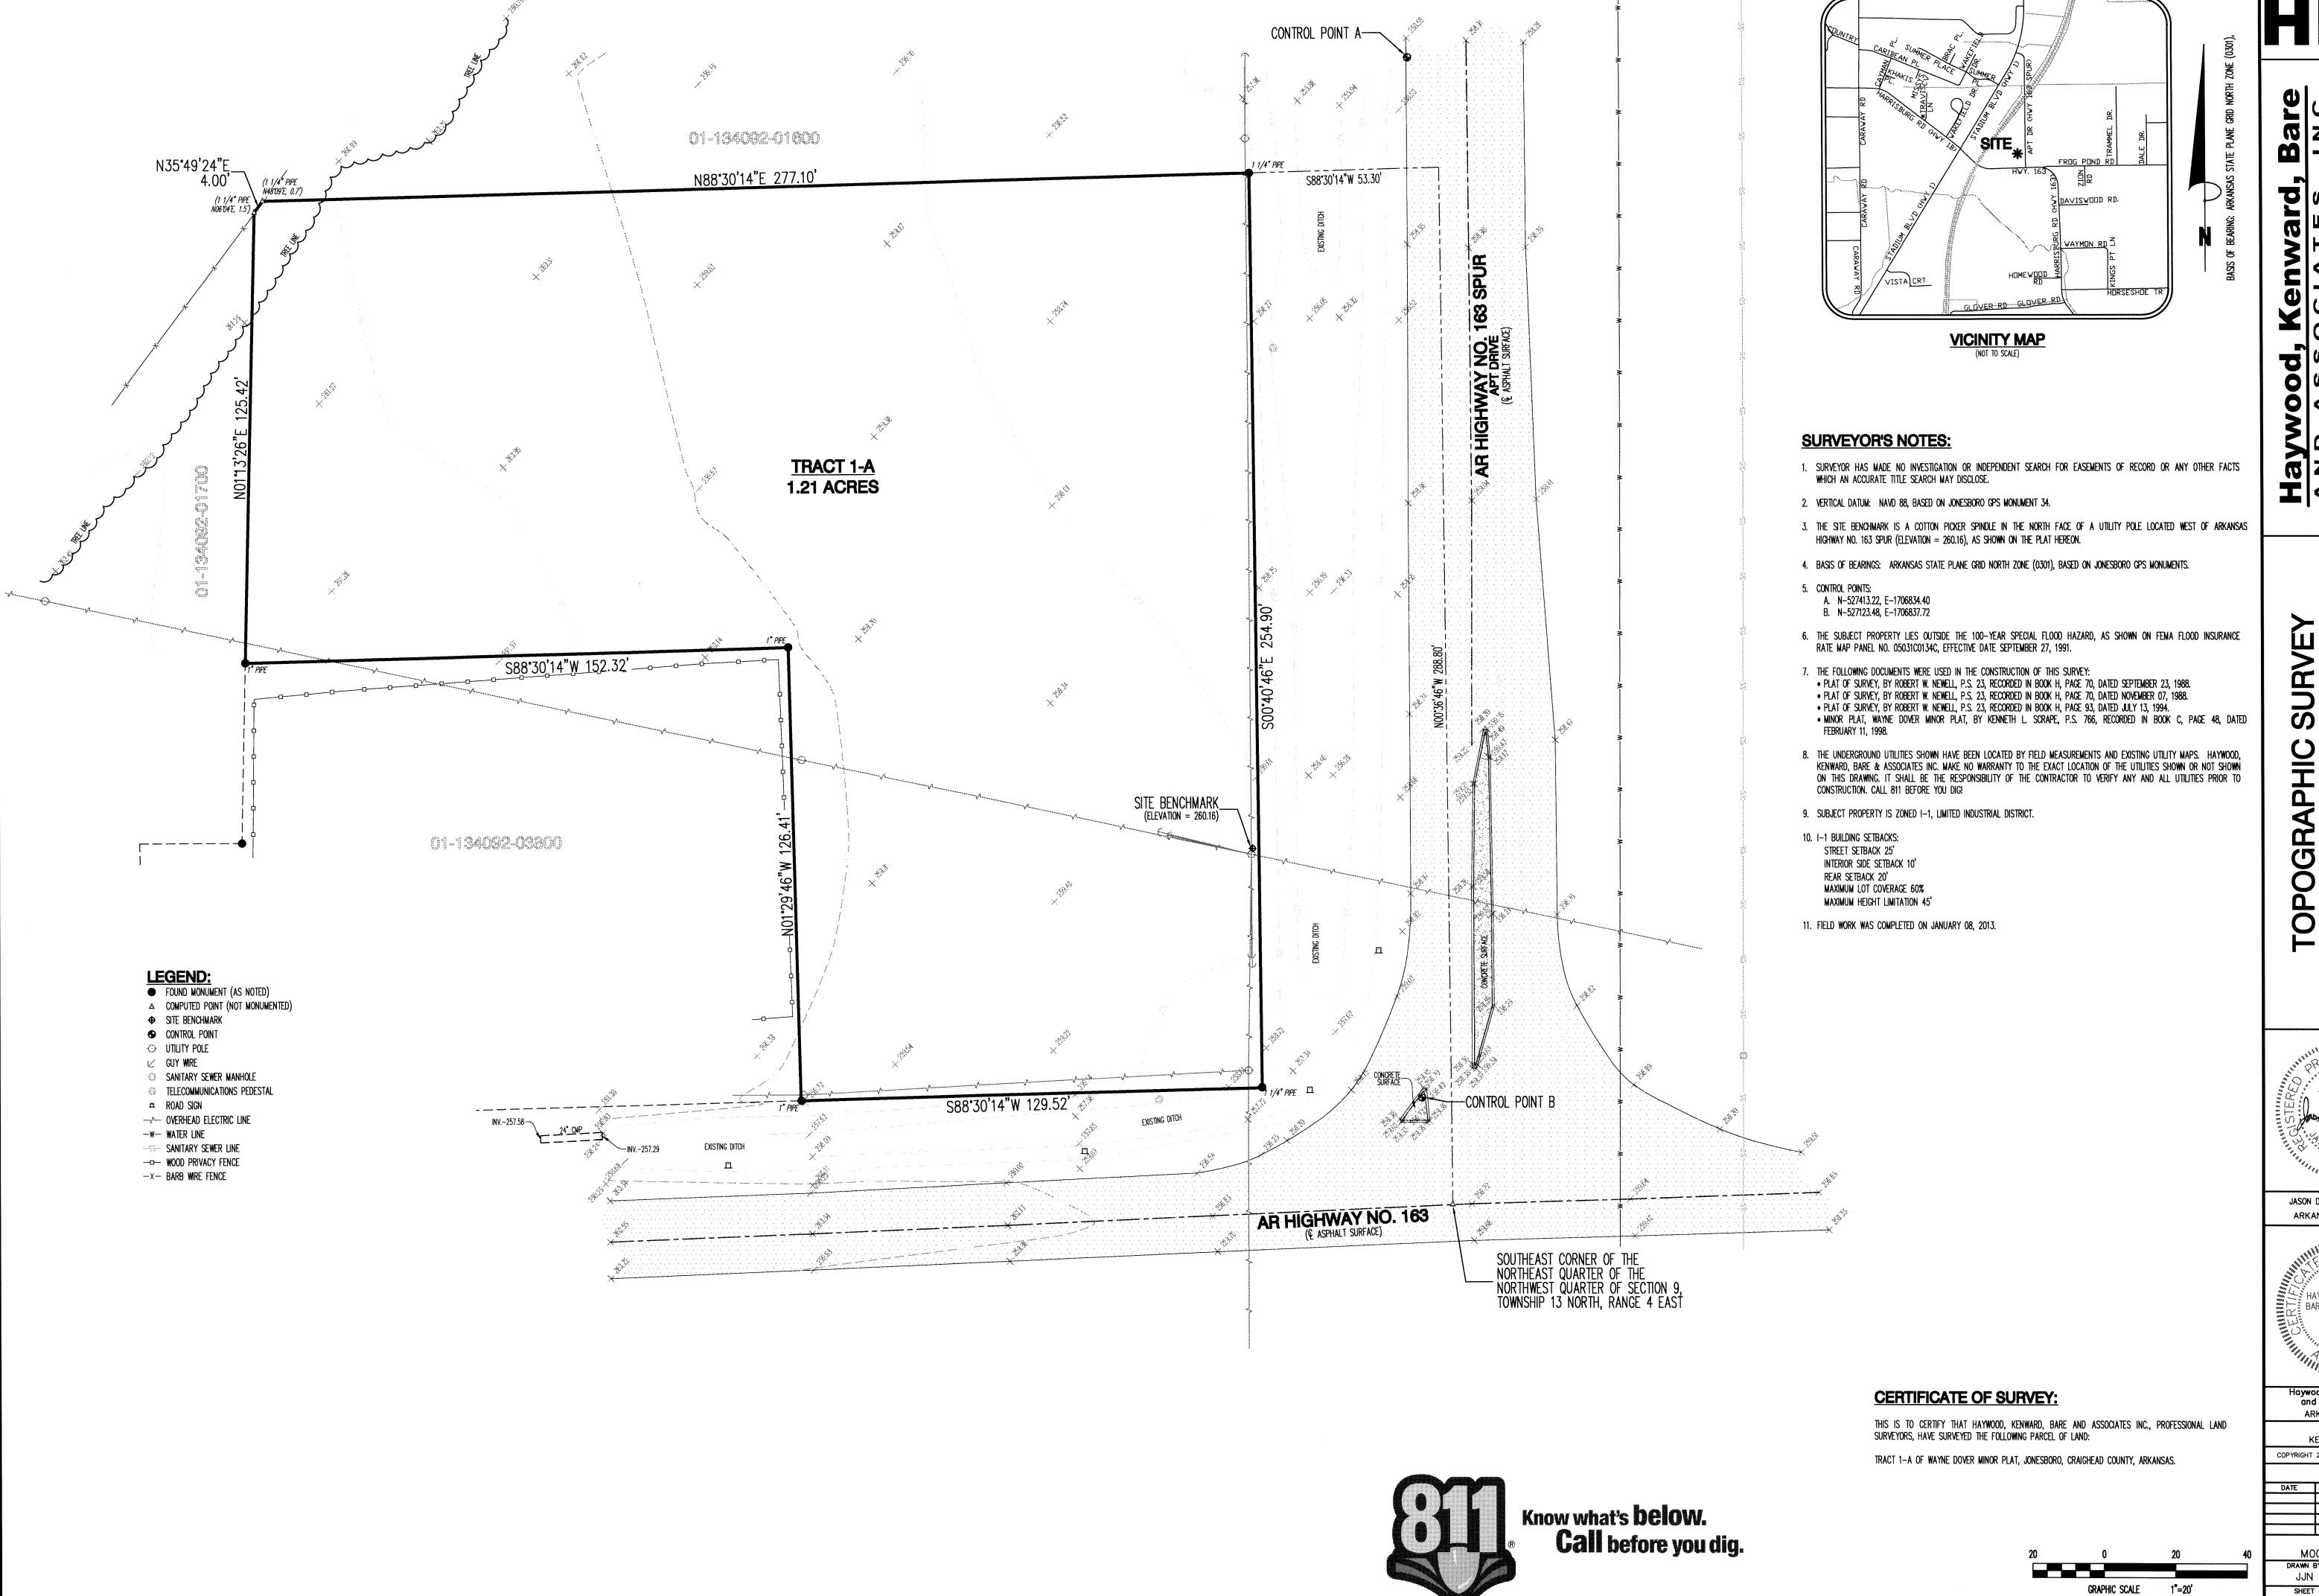


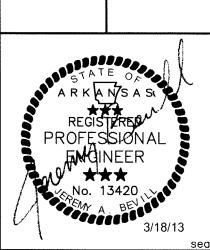JEREMY A. BEVILL - CIVIL ENGINEER ARKANSAS - # 13420

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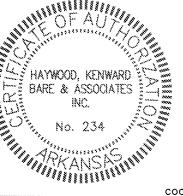
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scale 1"=20' 1 OF 5 DATE 03/18/13



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JASON D. BEARD — SURVEYOR ARKANSAS - NO. 1691





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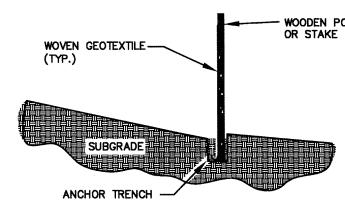
DATE BY DESCRIPTION project no. M003-0004-04

CHECKED BY JJN JDB 2 OF 5 1"=20' DATE 01/24/13 DRAWING NO. 20-62


TOPOGRAPHIC SURVEY



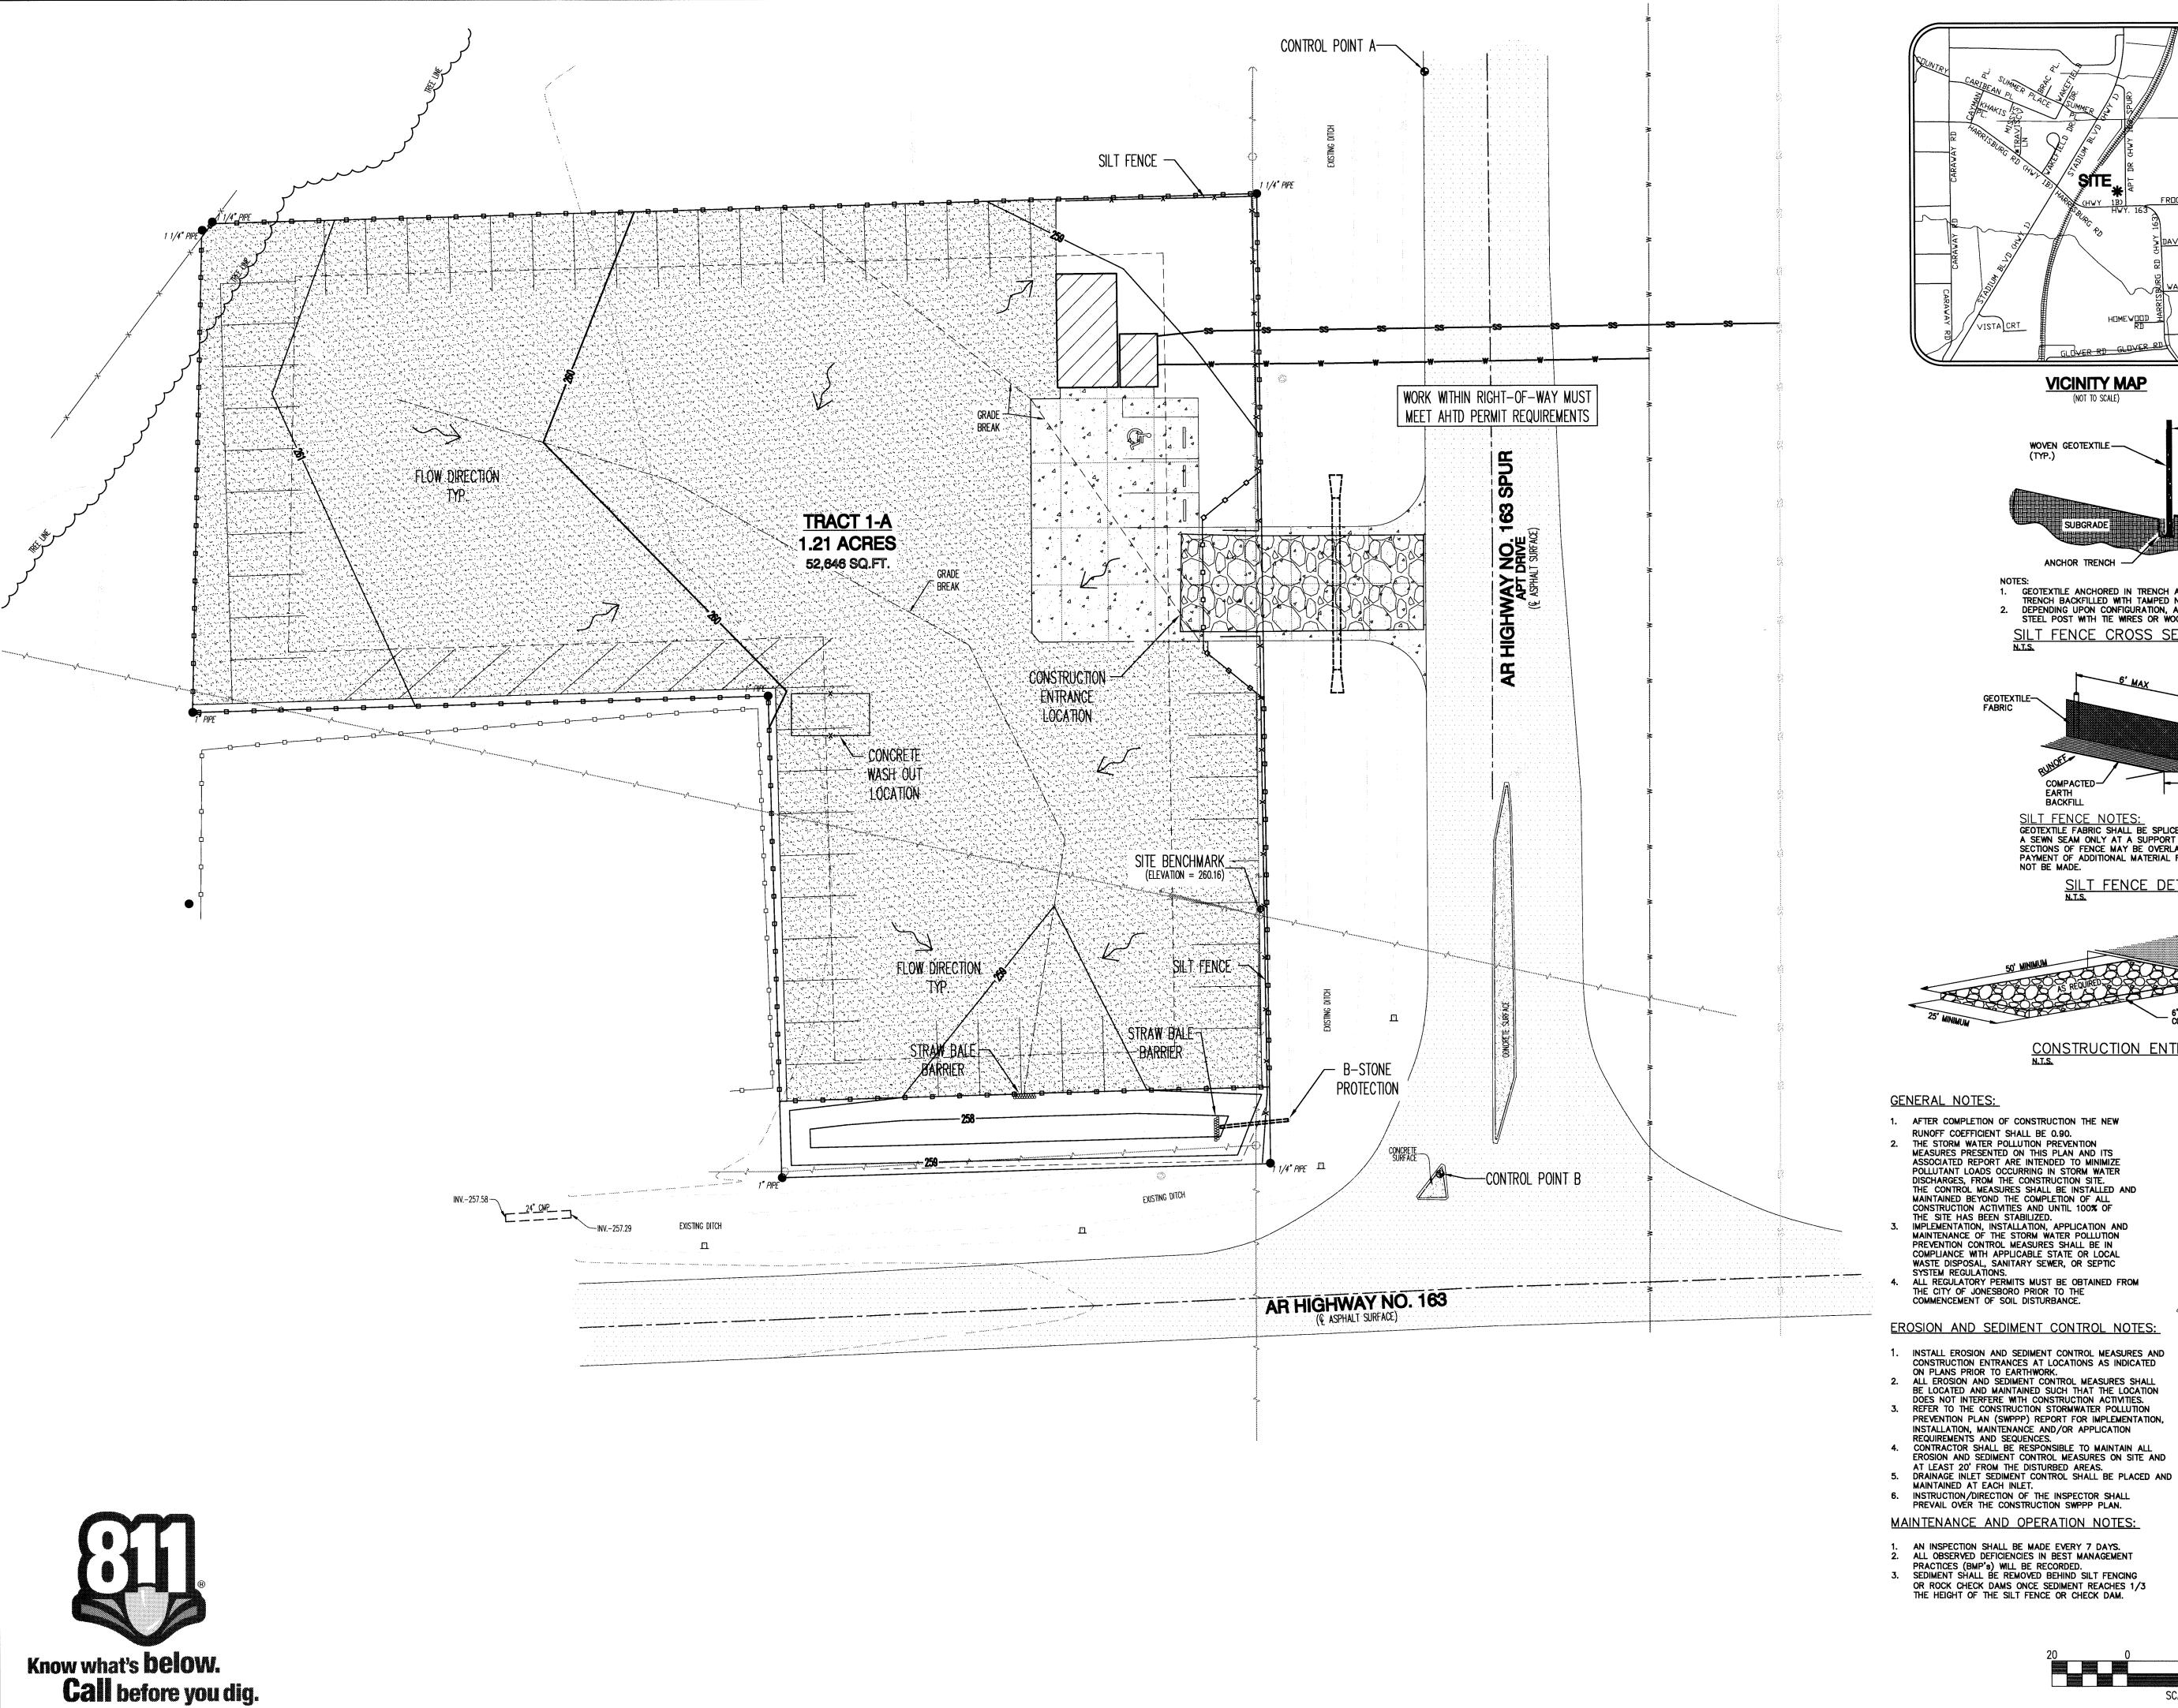

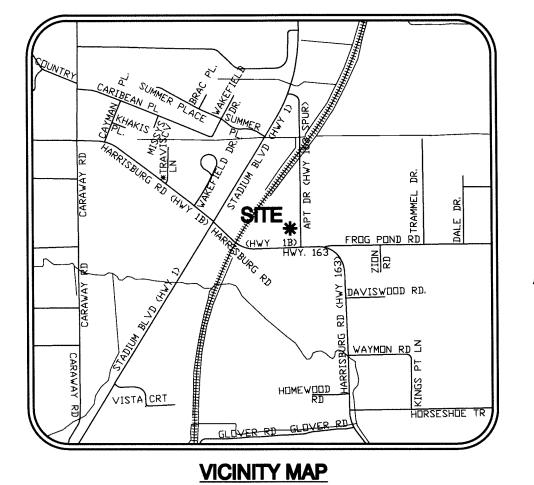


 GEOTEXTILE ANCHORED IN TRENCH A MINIMUM OF 15 CM (6 IN).
 TRENCH BACKFILLED WITH TAMPED NATURAL SOIL.
 DEPENDING UPON CONFIGURATION, ATTACH GEOTEXTILE TO STEEL POST WITH TIE WIRES OR WOOD POSTS WITH STAPLES. SILT FENCE CROSS SECTION

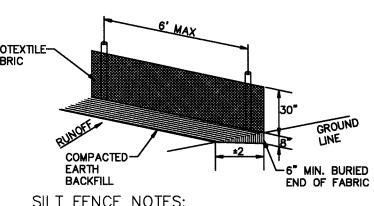

SILT FENCE NOTES:

GEOTEXTILE FABRIC SHALL BE SPLICED TOGETHER WITH A SEWN SEAM ONLY AT A SUPPORT POST, OR TWO SECTIONS OF FENCE MAY BE OVERLAPPED INSTEAD. PAYMENT OF ADDITIONAL MATERIAL FOR OVERLAP WILL NOT BE MADE.

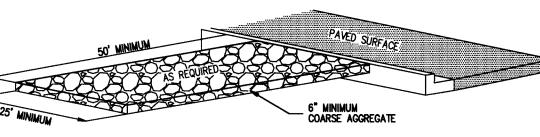

CONSTRUCTION ENTRANCE DETAIL

- 1. AFTER COMPLETION OF CONSTRUCTION THE NEW RUNOFF COEFFICIENT SHALL BE 0.90. 2. THE STORM WATER POLLUTION PREVENTION
- THE STORM WATER POLLUTION PREVENTION
 MEASURES PRESENTED ON THIS PLAN AND ITS
 ASSOCIATED REPORT ARE INTENDED TO MINIMIZE
 POLLUTANT LOADS OCCURRING IN STORM WATER
 DISCHARGES, FROM THE CONSTRUCTION SITE.
 THE CONTROL MEASURES SHALL BE INSTALLED AND
 MAINTAINED BEYOND THE COMPLETION OF ALL
 CONSTRUCTION ACTIVITIES AND UNTIL 100% OF
 THE SITE HAS BEEN STABILIZED.
 IMPLEMENTATION, INSTALLATION, APPLICATION AND
 MAINTENANCE OF THE STORM WATER POLLUTION
 PREVENTION CONTROL MEASURES SHALL BE IN
 COMPLIANCE WITH APPLICABLE STATE OR LOCAL
 WASTE DISPOSAL. SANITARY SEWER. OR SEPTIC WASTE DISPOSAL, SANITARY SEWER, OR SEPTIC
- ALL REGULATORY PERMITS MUST BE OBTAINED FROM THE CITY OF JONESBORO PRIOR TO THE COMMENCEMENT OF SOIL DISTURBANCE.

EROSION AND SEDIMENT CONTROL NOTES:

- INSTALL EROSION AND SEDIMENT CONTROL MEASURES AND CONSTRUCTION ENTRANCES AT LOCATIONS AS INDICATED ON PLANS PRIOR TO EARTHWORK.

 ALL EROSION AND SEDIMENT CONTROL MEASURES SHALL BE LOCATED AND MAINTAINED SUCH THAT THE LOCATION DOES NOT INTERFERE WITH CONSTRUCTION ACTIVITIES.

 DEFEN TO THE CONSTRUCTION STORMANTER POLICIES. REFER TO THE CONSTRUCTION STORMWATER POLLUTION
- PREVENTION PLAN (SWPPP) REPORT FOR IMPLEMENTATION, INSTALLATION, MAINTENANCE AND/OR APPLICATION REQUIREMENTS AND SEQUENCES.

 4. CONTRACTOR SHALL BE RESPONSIBLE TO MAINTAIN ALL EROSION AND SEDIMENT CONTROL MEASURES ON SITE AND AT LEAST 20' EROM THE DISTURDED AREAS.
- 6. INSTRUCTION/DIRECTION OF THE INSPECTOR SHALL PREVAIL OVER THE CONSTRUCTION SWPPP PLAN.

MAINTENANCE AND OPERATION NOTES:

- AN INSPECTION SHALL BE MADE EVERY 7 DAYS.
 ALL OBSERVED DEFICIENCIES IN BEST MANAGEMENT
- PRACTICES (BMP's) WILL BE RECORDED.


 3. SEDIMENT SHALL BE REMOVED BEHIND SILT FENCING OR ROCK CHECK DAMS ONCE SEDIMENT REACHES 1/3 THE HEIGHT OF THE SILT FENCE OR CHECK DAM.


PROFESSIONAL CERTIFICATION: I CERTIFY UNDER PENALTY OF LAW THAT THIS DOCUMENT AND ALL ATTACHMENTS WERE PREPARED UNDER MY DIRECTION OR
SUPERVISION IN ACCORDANCE WITH A SYSTEM
DESIGNED TO ASSURE THAT QUALIFIED
PERSONNEL PROPERLY GATHER AND EVALUATE PERSONNEL PROPERLY GATHER AND EVALUATE THE INFORMATION SUBMITTED. BASED ON MY INQUIRY OF THE PERSON OR PERSONS WHO MANAGED THE SYSTEMS, OR THOSE PERSONS DIRECTLY RESPONSIBLE FOR GATHERING THE INFORMATION, THE INFORMATION SUBMITTED IS, TO THE BEST OF MY KNOWLEDGE AND BELIEF, TRUE, ACCURATE, AND COMPLETE. I AM AWARE THAT THERE ARE SIGNIFICANT PENALTIES FOR SUBMITTING FALSE INFORMATION, INCLUDING THE POSSIBILITY OF FINE AND IMPRISONMENT FOR KNOWING VIOLATIONS.

Josemy R. JEREMY BEVILL, P.E. 13420 PROJECT ENGINEER

VIOLATIONS.

OWNER/CONTRACTOR CERTIFICATION: I CERTIFY UNDER PENALTY OF LAW THAT I UNDERSTAND THE TERMS AND CONDITIONS OF THE GENERAL NATIONAL POLLUTANT DISCHARGE ELIMINATION SYSTEM (NPDES)
PERMIT THAT AUTHORIZES THE STORM WATER
DISCHARGES ASSOCIATED WITH INDUSTRIAL
ACTIVITY FROM THE CONSTRUCTION SITE
IDENTIFIED AS PART OF THIS CERTIFICATION.

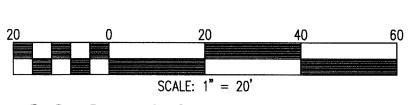

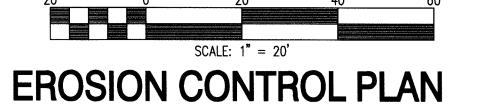


PLAN

CONTROL

EROSIO

PROFESSIONAL **EM** INEER ***


JEREMY A. BEVILL — CIVIL ENGINEER ARKANSAS - # 13420

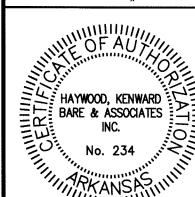


łaywood, Kenward, Bare, and Associates, Inc ARKANSAS - 234 CLIENT: KEVIN MEREDITH

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PROJECT NO. M003-0004-Rev DRAWN BY JAB 3 OF 5 1"=20' DRAWING NO. 20-62 DATE 03/18/13



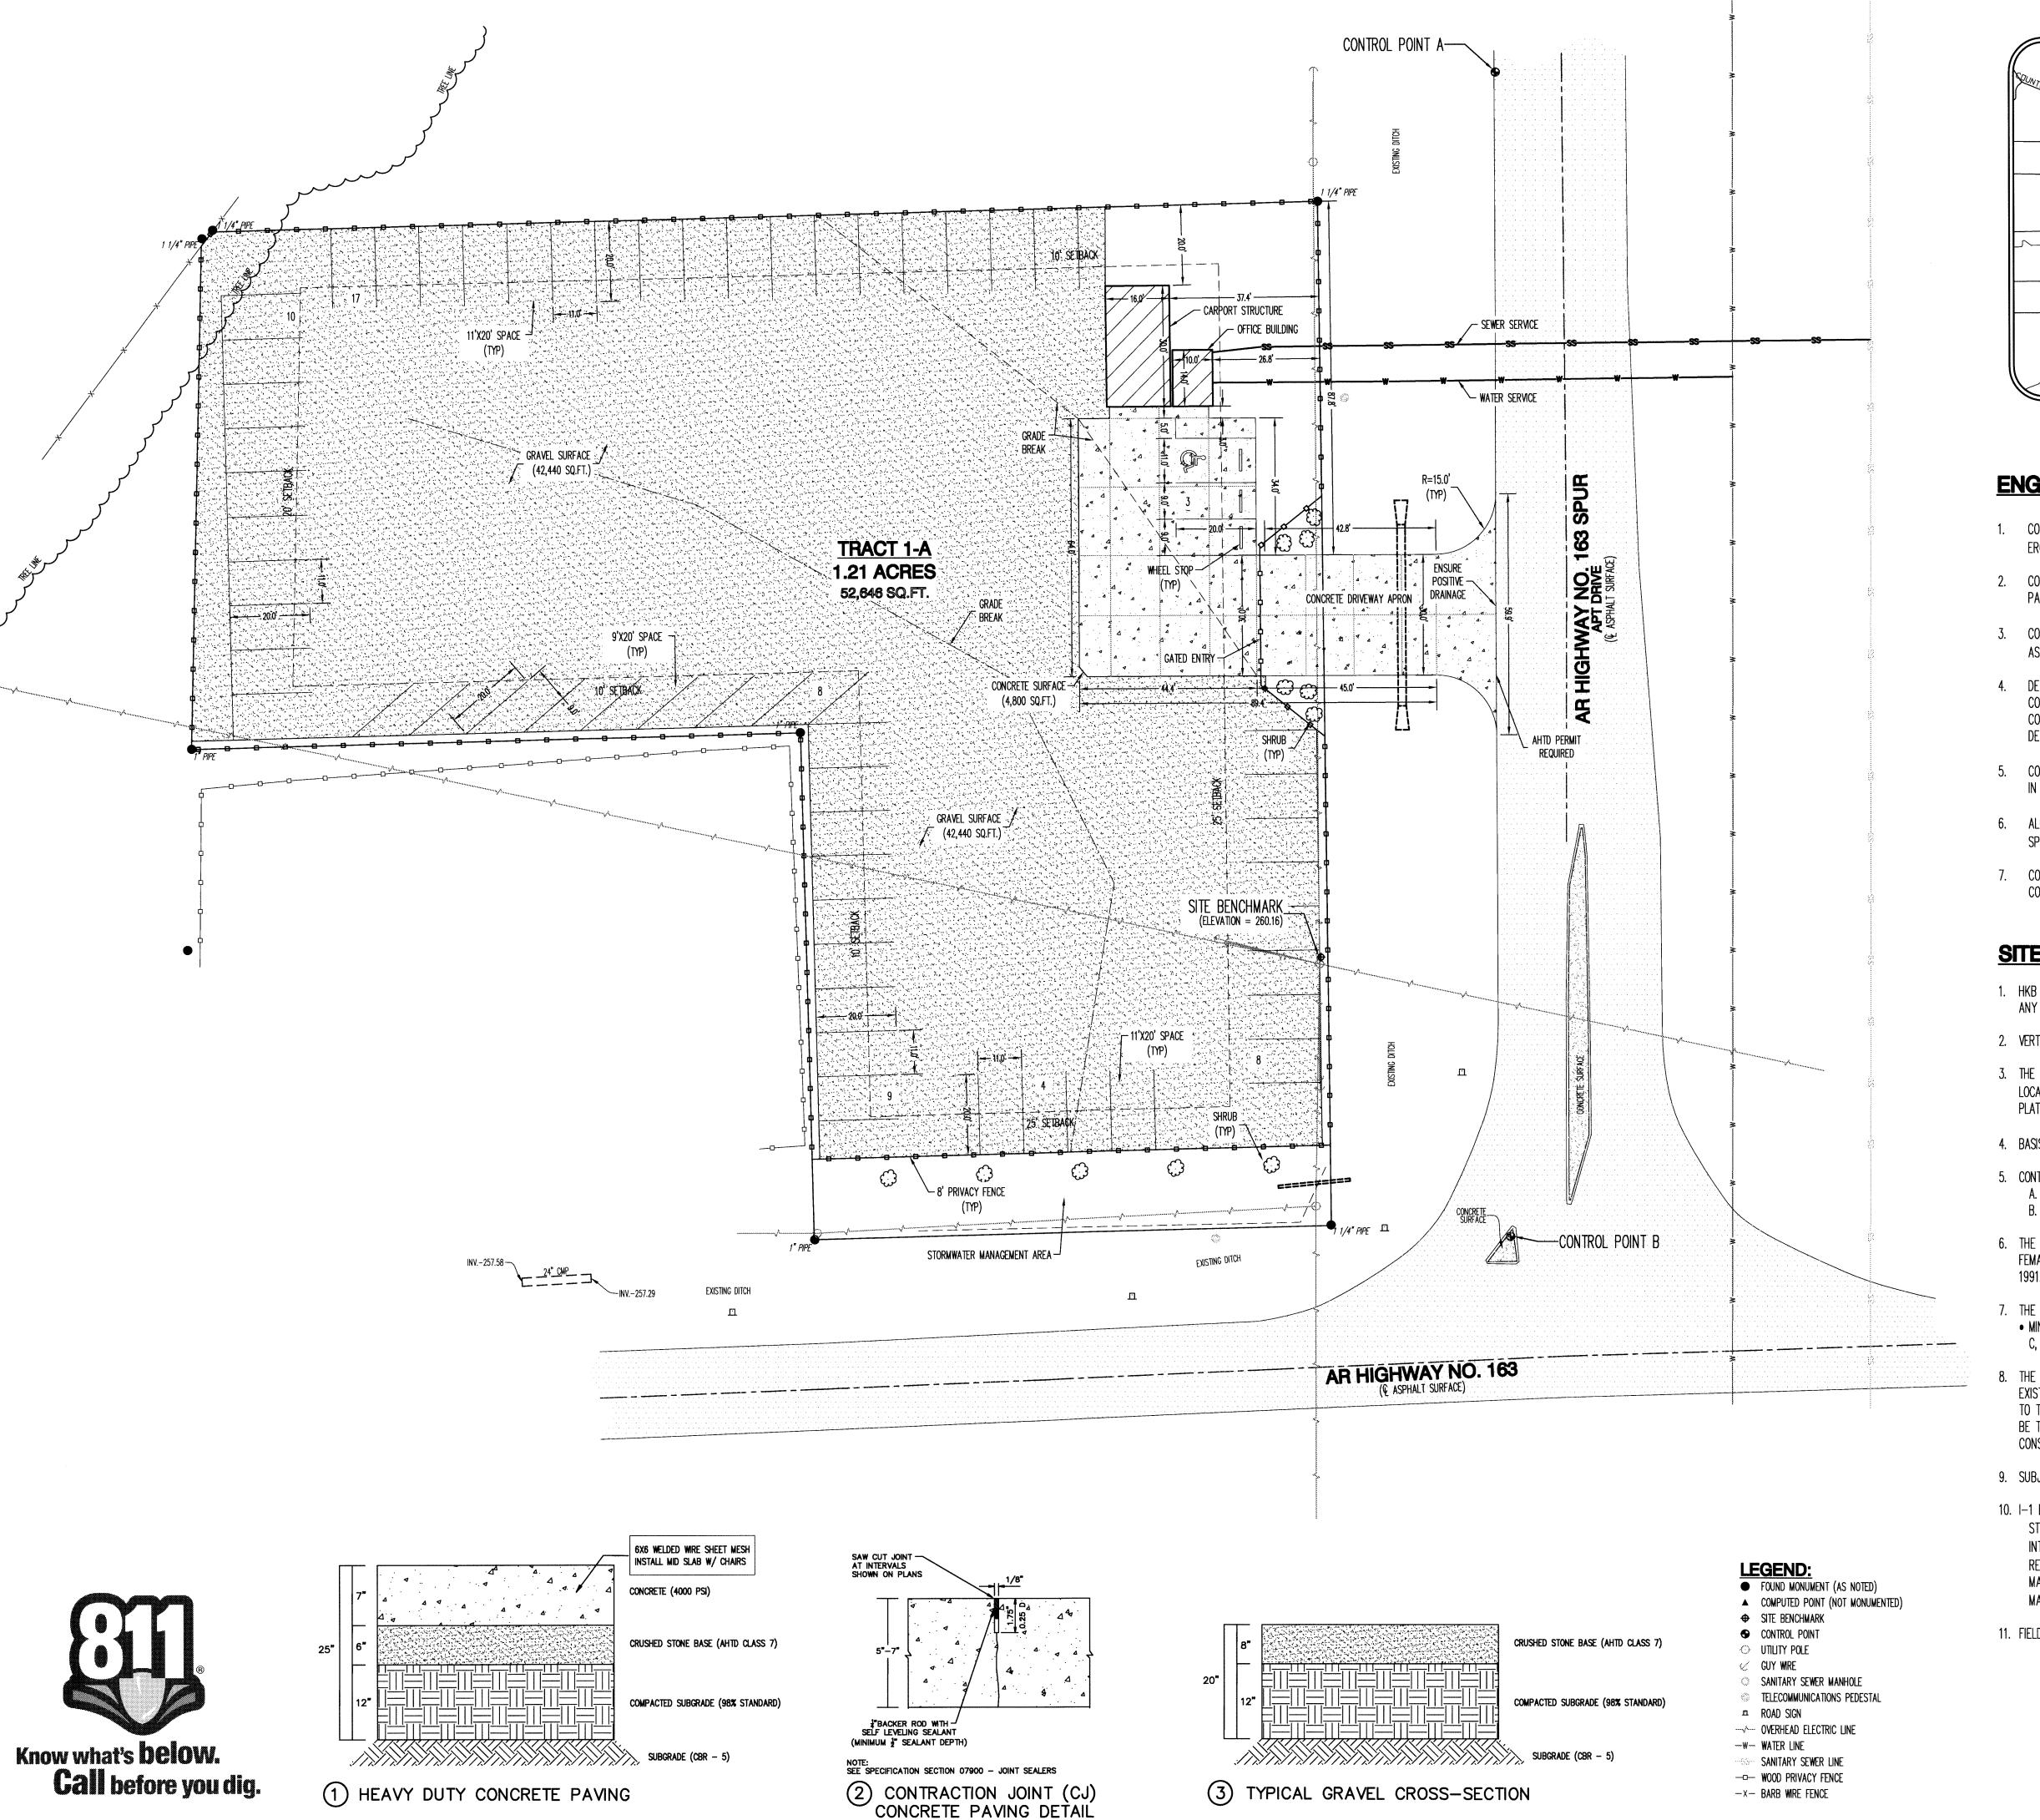

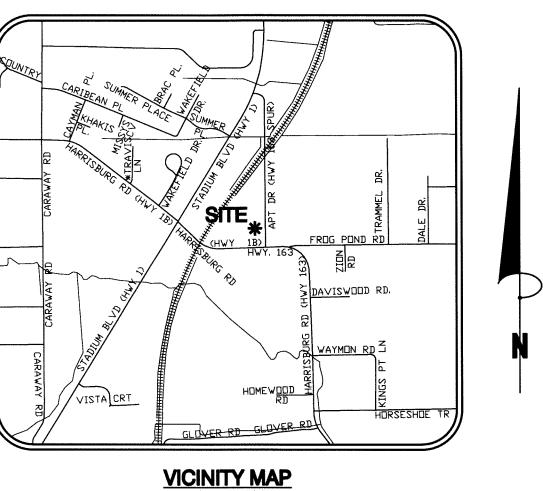ENGINEERING NOTES:


- 1. CONTRACTOR IS RESPONSIBLE FOR INSTALLING AND MAINTAINING ADEQUATE EROSION/SEDIMENTATION CONTROL DURING ALL PHASES OF CONSTRUCTION.
- 2. CONTRACTOR IS RESPONSIBLE FOR KEEPING MUD AND DEBRIS OFF CITY STREETS AND OFF OF PAVED DRIVEWAYS WHERE APPLICABLE. CLEAN UP IS REQUIRED DAILY.
- 3. CONTRACTOR IS RESPONSIBLE FOR THE REPLACEMENT OF SIDEWALK, CURB AND GUTTER AND/OR ASPHALT/CONCRETE DAMAGED DURING CONSTRUCTION.
- 4. DEVIATION FROM ENGINEERING DESIGN PLANS IS NOT PERMITTED. ANY CHANGE IN THE CONSTRUCTION DOCUMENTS THAT ARE NOT APPROVED BY THE ENGINEER WILL RESULT IN CONSTRUCTION TERMINATION UNTIL A RESOLUTION IS MET. MODIFICATION NEEDED TO UPDATE DESIGN PLANS WILL RESULT IN DESIGN EXPENSES FOR THE CONTRACTOR.
- 5. CONTRACTOR SHALL NOTIFY THE ENGINEER AND OWNER/DEVELOPER OF ANY INFORMATION FOUND IN THE FIELD THAT IS DIFFERENT FROM WHAT IS SHOWN ON THESE DESIGN PLANS.
- 6. ALL DISTURBED AREAS ARE TO BE SEED/STRAW UPON COMPLETION OF EARTHWORK (SEE SPECIFICATION).
- 7. CONTRACTOR IS RESPONSIBLE FOR ALL CITY, STATE, OR FEDERAL PERMIT FEES ASSOCIATED WITH CONSTRUCTION.

SITE NOTES:

- 1. HKB HAS MADE NO INVESTIGATION OR INDEPENDENT SEARCH FOR EASEMENTS OF RECORD OR ANY OTHER FACTS WHICH AN ACCURATE TITLE SEARCH MAY DISCLOSE.
- 2. VERTICAL DATUM: NAVD 88
- 3. THE SITE BENCHMARK IS A COTTON PICKER SPINDLE IN THE NORTH FACE OF A UTILITY POLE LOCATED WEST OF ARKANSAS HIGHWAY NO. 163 SPUR (ELEVATION = 260.16), AS SHOWN ON THE PLAT HEREON.
- 4. BASIS OF BEARINGS: ARKANSAS STATE PLANE GRID NORTH ZONE (0301)
- 5. CONTROL POINTS:
- A. N-527413.22, E-1706834.40 B. N-527123.48, E-1706837.72
- 6. THE SUBJECT PROPERTY LIES OUTSIDE THE 100-YEAR SPECIAL FLOOD HAZARD, AS SHOWN ON FEMA FLOOD INSURANCE RATE MAP PANEL NO. 05031C0134C, EFFECTIVE DATE SEPTEMBER 27,
- 7. THE FOLLOWING DOCUMENTS WERE USED IN THE CONSTRUCTION OF THIS SURVEY:

 MINOR PLAT, WAYNE DOVER MINOR PLAT, BY KENNETH L. SCRAPE, P.S. 766, RECORDED IN BOOK C, PAGE 48, DATED FEBRUARY 11, 1998.
- 8. THE UNDERGROUND UTILITIES SHOWN HAVE BEEN LOCATED BY FIELD MEASUREMENTS AND EXISTING UTILITY MAPS. HAYWOOD, KENWARD, BARE & ASSOCIATES INC. MAKE NO WARRANTY TO THE EXACT LOCATION OF THE UTILITIES SHOWN OR NOT SHOWN ON THIS DRAWING. IT SHALL BE THE RESPONSIBILITY OF THE CONTRACTOR TO VERIFY ANY AND ALL UTILITIES PRIOR TO CONSTRUCTION. CALL 811 BEFORE YOU DIG!
- 9. SUBJECT PROPERTY IS ZONED I-1, LIMITED INDUSTRIAL DISTRICT.
- 10. I-1 BUILDING SETBACKS:

 STREET SETBACK 25'
 INTERIOR SIDE SETBACK 10'
 REAR SETBACK 20'
 MAXIMUM LOT COVERAGE 60%
 MAXIMUM HEIGHT LIMITATION 45'
- 11. FIELD WORK WAS COMPLETED ON JANUARY 08, 2013.

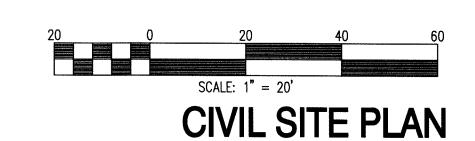

HKE

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ASSOCIATES, IN

STADIUM TOWING WAYNE DOVER MINOR PLAT TO THE DRO, CRAIGHEAD COUNTY, ARKANSAS

> TRACT CITY OF

SITE

REGISTERED PROFESSIONAL ENGINEER

JEREMY A. BEVILL - CIVIL ENGINEER
ARKANSAS - # 13420

HAYWOOD, KENWARD

NO. 234

NO. 234

Haywood, Kenward, Bare, and Associates, Inc ARKANSAS — 234 CLIENT: KEVIN MEREDITH

KEVIN MEREDITH

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REVISIONS

DATE BY DESCRIPTION

PROJECT NO.

M003-0004-Rev


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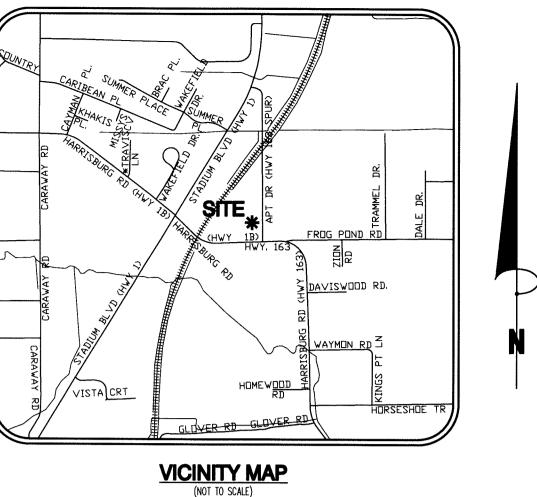
JAB

SHEET SCALE
4 OF 5 1"=20'

DATE DRAWING NO.

03/18/13 20-62



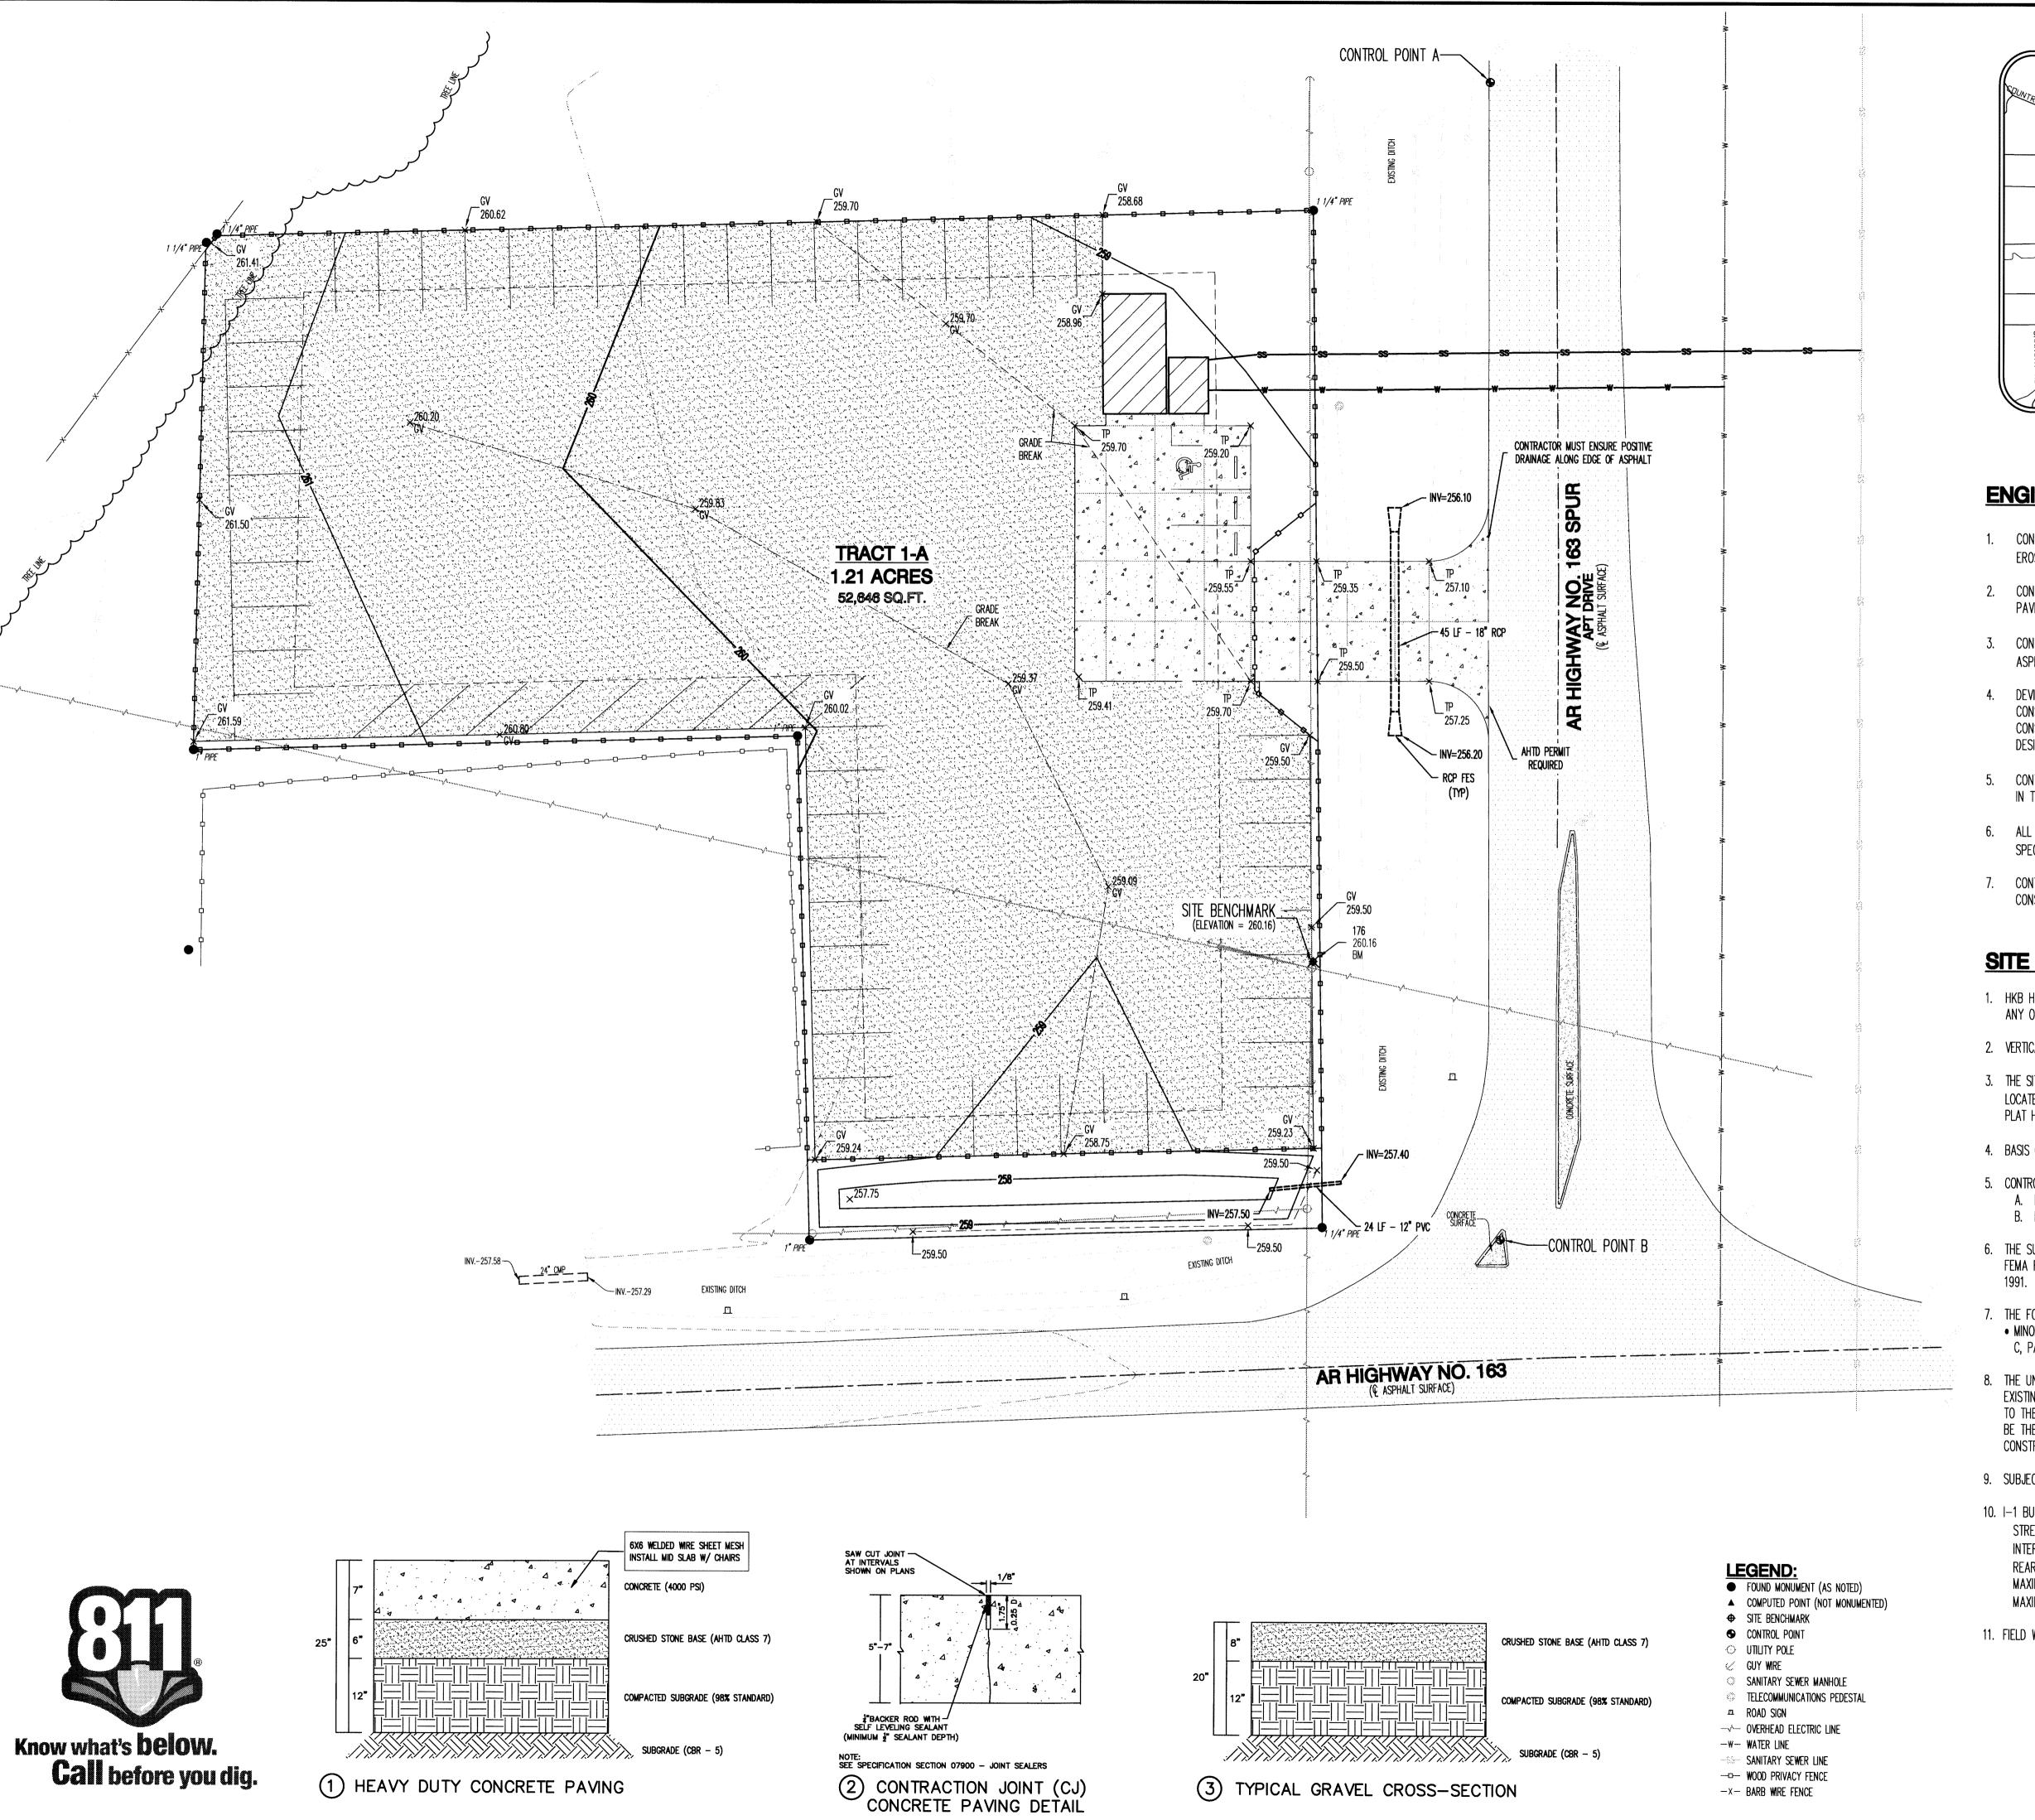


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- 11. FIELD WORK WAS COMPLETED ON JANUARY 08, 2013.



DRAINAGE

∞

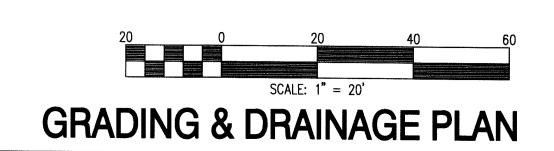GRADING

REGISTERED PROFESSIONAL FMGINEER *** No. 13420

JEREMY A. BEVILL - CIVIL ENGINEER

ARKANSAS - # 13420 HAYWOOD, KENWARD INC.

No. 234 MARKANSA

Haywood, Kenward, Bare, and Associates, Inc ARKANSAS - 234 CLIENT: KEVIN MEREDITH

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M003-0004-Rev scale 1"=20' 5 OF 5 DATE 03/18/13

20-62