



DRIVING DIRECTIONS:

FROM LITTLE ROCK, HEAD NORTH ON US-67N TOWARDS JACKSONVILLE. CONTINUE TO EXIT 102 FOR AR-226 TOWARDS JONESBORO, CONTINUE ON 1-555/US-49N/US-63. TAKE EXIT 42 FOR US-49N/STADIUM BLVD. TURN RIGHT ONTO AR-I S/STADIUM BLVD. TURN LEFT ONT E. PARKER RD.

DEPARTMENT	NAME / SIGNATURE	DATE
LAND OWNER / TOWER OWNER		
SITE ACQUISITION AGENT		
ZONING / PERMITTING AGENT		
A & E MANAGER		
CONSTRUCTION MANAGER		
RF ENGINEER		

SITE NUMBER:

AR1516

SITE NAME:

METHODIST HOSPITAL

TOWER TYPE:

PROPOSED 100-FT MONOPOLE TOWER

(OVERALL APPURTENANCE HEIGHT - 101-FT AGL)

TOWER OWNER:



PREPARED BY:



1000 HOLCOMB WOODS PKWY SUITE 210 ROSWELL, GA 30076 678-280-2325

PROJECT INFORMATION

SITE ADDRESS:

3313 E. PARKER ROAD JONESBORO, AR 72404

LATITUDE: LONGITUDE:

35° 48' 22.593" -90° 39' 44.824" 01-144331-00201

PARCEL ID:

C-3 (GENERAL COMMERCIAL)

JURISDICTION:

ZONING:

CITY OF JONESBORO

PROPERTY OWNER:

MOBEME LLC 3206 ROOK ROAD JONESBORO, AR 72404 ELIZABETH MOORE

APPLICANT/OWNER: DIAMOND TOWER VILLO

820 MORRIS TURNPIKE, SUITE 104

SHORT HILLS, NJ 07078 KAREY L. ARNTSON-VAWTER

(404) 909-8705

ENGINEER:

P. MARSHALL & ASSOCIATES 1000 HOLCOMB WOODS PKWY, SUITE 210

ROSWELL, GA 30076

(678) 280-2325

DARA AY, PE, PROJECT ENGINEER DAVID CRABBE, PE, SENIOR ENGINEER

POWER:

DRAWING INDEX

TITLE SHEET & PROJECT INFORMATION

ENTERGY

TBD

AERIAL IMAGE SITE PLAN

OVERALL SITE PLAN DETAILED SITE PLAN

TOWER ELEVATION

FENCE & H-FRAME DETAILS

LANDSCAPE PLAN


24-HOUR CONTACT:

KAREY L. ARNTSON-VAWTER - (404) 909-8705



CALL BEFORE YOU DIG ARKANSAS ONE-CALL 811

http://www.arkonecall.com/

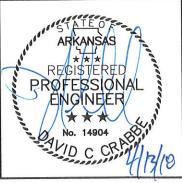





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TITLE SHEET & ROJECT INFORMATION

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DESIGNED:

DA DRAWN: CHECKED: PWM

JOB #: DC18-001








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SITE PLAN

AERIAL IMAGE


GRAPHIC SCALES



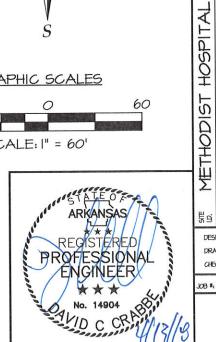

CHECKED: PWM 108 #: DC18-001

DESIGNED: DA DRAWN DA

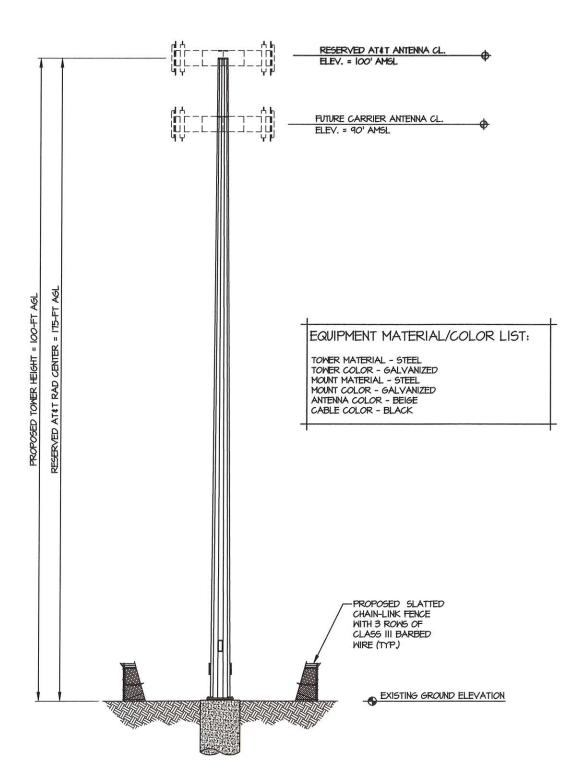

TOWER ELEVATION

SCALE: NOT TO SCALE

Designed Appurtenance Loading

Elev	Description	Tx-Line
120***	(12) 8' X 1' X 6IN	(12) 1 5/8*
120***	(18) RRH	
118***	Platform - 12' w/ Enhanced Support Rail	
100	(6) SBNH-1D6565C	(6) 1 5/8"
100	(6) SBNHH-1D65C	(18) 3/4"
100	(12) RRUS 11	(6) 1/2*
100	(3) RRUS 12	
100	(3) RRUS AWS A2	
100	(3) RRUS-32B30	
100	(3) DC6-48-60-18-8F	
100	(6) RRH	
98	Commscope Tri-Sector Platform Mount - MTC3607	
90	Platform - 12' w/ Enhanced Support Rail	
90	(12) 8' X 1' X 6IN	(12) 1 5/6*
90	(12) RRH	

Load Case Reactions

Edda Gade Hadellone						
Description	Axial (kips)	Shear (kips)	Moment (ft-k)	Deflection (ft)	Sway (deg)	
3s Gusted Wind	33.73	22.74	2175.1	9.51	7.77	
3s Gusted Wind 0.9 Dead	25.33	22.73	2129.72	9.26	7.54	
3s Gusted Wind&Ice	57,43	3,28	340.9	1.55	1.26	
Service Loads	28.12	5.66	536.39	2.37	1,92	

Base Plate Dimensions

Shape	Diameter	Thickness	Batt Circle	Bolt Qty	Bolt Diameter
Round	51.75*	2"	46*	10	2.25*

A	nchoi	Rolf	Dime	nsioi	1

Length	Diameter	Hole Diameter	Weight	Тура	Finish
84"	2.25*	2.625*	1211	A615-75	Galv

- 1) Antenna Feed Lines Run Inside Pole
- 2) All dimensions are above ground level, unless otherwise specified.
 3) Weights shown are estimates. Final weights may vary.
- The Monopole was designed for a basic wind speed of 90 mph with 0" of radial ice, and 30 mph with 1" of radial ice, in accordance with ANSI/TIA-222-G, Structure Class II, Exposure Category C, Topographic Category 1.
 The tower design meets the requirements for an Ultimate Wind Speed of 115 mph (Risk Category II), in accordance with the 2012 International Bullding Code.
- 6) Full Height Step Bolts
- 7) Tower Rating: 100%
- *** These Appurtenances cannot be installed until the Monopole has been extended.

Sabre Industries Towers and Poles

FUTURE EXTENSION

Sabre Communications Corpora 7101 Southbridge Drive P.O. Box 658 Sloux City, IA 51:102-0658 Peace (712;378-656 Fec (712;378-6514

-9" | 10,5" x 25.5" @ 90",270" ---5" ↑ 10.5" × 25.5" @ 180",360"


DIAMOND COMMUNICATIONS LLC Methodist Hospital, AR AR1516 100' ext. 120' Monopole

TOWER DESIGN

SCALE: NOT TO SCALE

TOWER/FOUNDATION DESIGN NOTE:

REFER TO FULL "STRUCTURAL DESIGN REPORT" BY SABRE TOWERS & POLES DATED FEBRUARY I, 2018 FOR FULL DETAILS, CALCULATIONS, AND SPECIFICATIONS.

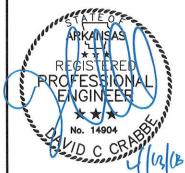






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ELEVATION TOWER


METHODIST HOSPITAL

DESIGNED: DA CHECKED: PWM

10B #: DCI8-001

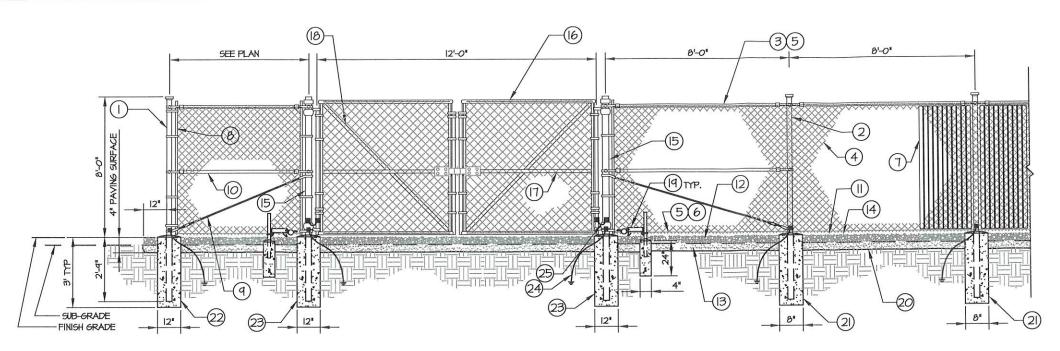

STANDARD FENCE ELEVATION DETAILS

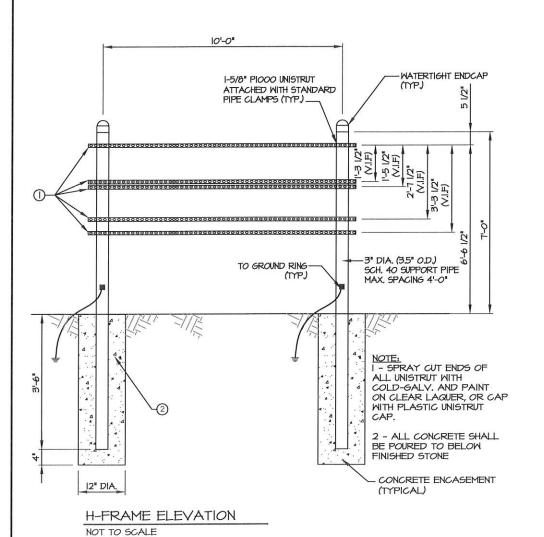



SITE SIGNAGE NOTE INSTALL (1) ON ALL SIDES OF SITE

RED/ WHITE BACKGROUND WITH CONTRASTING LETTERING.

STE SIGNAGE


NOT TO SCALE

KEY NOTES: (X)

- CORNER, END OR PULL POST 3" NOMINAL SCHEDULE 40 PIPE.
- 2. LINE POST: 2-1 /2" SCHEDULED 40 PIPE, PER ASTM-FI083. LINE POSTS SHALL BE EQUALLY SPACED AT MAXIMUM 8'-O" O.C.
- 3. TOP RAIL & BRACE RAIL: I-I /2" PIPE PER ASTM-FI083.
- 4. FABRIC: 9 GA CORE WIRE SIZE 2" MESH, CONFORMING TO ASTM-A392. ALL TIES TO BE GALVANIZED.
- 5. TIE WIRE: MINIMUM II GA. GALVANIZED STEEL AT POSTS AND RAILS A SINGLE WRAP OF FABRIC TIE AND AT TENSION WIRE BY HOG RINGS SPACED MAXIMUM 24" INTERVALS.
- 6. TENSION WIRE: 9 GA. GALVANIZED STEEL
- 7. VINYL PRIVACY SLATS: PROVIDE 75% SCREENING (MINIMUM).
- 8. STRETCHER BAR
- 9. 3 /8" DIAGONAL ROD WITH GALVANIZED STEEL TURNBUCKLE OR DIAGONAL THREADED ROD.
- 10. FENCE CORNER POST BRACE: 1-5 /8" DIAMETER EACH CORNER EACH
- II. I-I /2" MAXIMUM CLEARANCE FROM GRADE.
- 12, FINISHED GRADE
- 13. MATERIAL SUB-GRADE
- 14. FINISHED GRADE SHALL BE UNIFORM AND LEVEL.
- 15. GATE POST 4" SCHEDULE 40 PIPE (FOR GATE WIDTHS UP THRU T' OR 14" FOR DOUBLE SWING GATES) PER ASTM-FI083.
- 16. GATE FRAME: I-I /2' PIPE, PER ASTM-FI083.
- 17. GATE FRAME: 1-5 /8" DIAMETER PIPE, PER AGTM-FI083.
- 18. GATE DIAGONAL GALVANIZED STEEL I-I /2" PIPE.
- 19. DUCK BILL OPEN GATE HOLDER. VERIFY LOCATION IN FIELD PRIOR TO INSTALLATION.
- 20. GEOTEXTILE FABRIC
- 21. LINE POST: CONCRETE FOUNDATION (2000 PSI)
- 22. CORNER POST: CONCRETE FOUNDATION (2000 PSI)
- 23. GATE POST: CONCRETE FOUNDATION (2000 PSI)
- 24. BOND FENCE POSTS TO GROUND RING WITH CADWELD
- 25. GATE FLEXIBLE JUMPER WITH CADWELD CONNECTIONS (TYP.)

GENERAL NOTES:

- A. INSTALL FENCE PER ASTM F-567
- B. INSTALL SWING GATE PER ASTM F-900
- C. LOCAL ORDINANCE OF BARBED WIRE PERMIT REQUIREMENT SHALL BE COMPLIED IF REQUIRED.
- D. POST & GATE PIPE SIZES ARE INDUSTRY STANDARDS.
- D.A. ALL PIPES TO BE I-I/ 2" GALVANIZED (HOT DIP, ASTM AI20 GRADE "A" STEEL).
- ALL GATE FRAMES SHALL BE WELDED.
- ALL WELDING SHALL BE COATED WITH (3) COATS OF COLD D.C. GALVANIZED STEEL (OR EQUAL).
- E. ALL OPEN POSTS SHALL HAVE END-CAPS
- F. USE GALVANIZED HOG-RING WIRE TO MOUNT ALL SIGNS.
- G. ALL SIGNS MUST BE MOUNTED ON INSIDE OF FENCE FABRIC.
- H. CONTRACTOR SHALL PROVIDE AND INSTALL STYMIE-LOCK LOCKING MECHANISM ON 12'-O" GATE. COORDINATE W/ PM FOR FINAL COMBINATION CODE

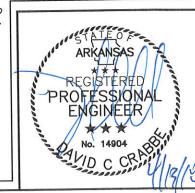



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TICT LOCULTAI		OF CITY O		R-FRAME DE AILS	
NUM DATE DESCRIPTION.	ATTIME OF DESIGNATION OF STREET				

og 0 Ž DESIGNED:

DA DA CHECKED! PWM

08 #: DC18-001

